Verizon

PROJECT NAME: SPO ASSEMBLY PROJECT LOCATION: 4301 W SUNSET BLVD **SPOKANE. WA 99224**

PROJECT

CITY OF SPOKANE

25262.0607

CB-55 (COMMUNITY BUSINESS)

VICINITY MAP JURISDICTION: ZONING CLASS: PARCEL NUMBER:

DRIVING DIRECTIONS

(FROM SPOKANE INTERNATIONAL AIRPORT)

- HEAD NORTHEAST ON W AIRPORT DR TOWARD W EX-USAF SECURITY ROAD.
- USE THE RIGHT LANE TO TAKE THE RAMP TO W SPOKANE.
- CONTINUE ONTO W SUNSET HWY.
 TURN RIGHT ONTO S RUSTLE RD.
 SITE WILL BE LOCATED ON THE LEFT IN THE SOUTHWEST CORNER OF THE HOTEL PARKING LOT.

TRS: SEC 26, TWN 25N, RNG 42E -117.472914* PARCEL SIZE: 2.26 ACRES GROUND ELEVATION: 2,184.0' AMSL 70'-0" (TOP OF MONOPOLE) STRUCTURE HEIGHT: HIGHEST APPURTENANCE: 70'-0" (TOP OF ANTENNAS) SCOPE OF WORK VERIZON WIRELESS PROPOSES TO INSTALL AN UNMANNED WIRELESS FACILITY CONSISTING OF (3) EQUIPMENT CABINET: VERIZON WIRELESS PROPOSES TO INSTALL AN UNMANNED WIRELESS FACILITY CONSISTING OF (3.) EQUIPMENT CABINI INSTALLED ON (1) 4'-0"x11'-0" CONCRETE PAD AND (1) 30x0 DIESEL GENERATOR INSTALLED ON (1) 4'-0"x8'-0' CONCRETE PAD AND (1) ILC AND (1) POWER METER INSTALLED ON A PROPOSED H-FRAME, ALL WITHIN A 14'-0"x32'-0" WOOD FENCED COMPOUND (26'-0"x44'-0" LEASE AREA). ALSO PROPOSED IS THE INSTALTION OF (6) PANEL ANTENNAS, (6) RRU'S, (1) 12-PORT RAYCAP SPLITTER/SURGE SUPPRESSOR, (1) 6'-7"Ø MICROWAVE ANTENNA, (2) ELLIPTICAL COAX CABLES AND (1) 12x24 HYBRID CABLE ON A PROPOSED 70'-0" MONOPOLE.

LATITUDE:

LONGITUDE:

INFORMATION

47°38'21 67"N

117°28'22.49"W

47.639353*

SHEET

T-1

N-1

C-1A

C-1B

C-2

A-1

A-2

A-3

RF-1

RF-2

TITLE

REPRESENTATIVE

RF ENGINEER PROPERTY OWNER DESCRIPTION

COVER SHEET

GENERAL NOTES

PROPOSED SITE PLAN

PROPOSED ELEVATION

PROPOSED IT DIAGRAM

EXISTING COMPOUND PLAN

PROPOSED COMPOUND PLAN

PROPOSED ANTENNA CONFIGURATIONS

PROPOSED POWER AND FIBER PLAN

LEGAL DESCRIPTION

ABBREVIATED LEGAL (SEE C-1 FOR FULL DESCRIPTION):

GARDEN SPRINGS ADDITION NW1/4 26-25-42 LTS7-18 BLK6 EXC PTN OF SD LTS CONV TO ST OF WA FOR HWY GARDEN SPRINGS ADDITION NWT/4 26-29-42 LIS/-18 BLK& EXC PIN OF SD LIS CONV TO ST OF WA POR HWY LYG NLY OF LN DRWN PAR WITH & 90° SLY MEAS RADLY FROM CL PSH#2 TOG W/PTN VAC 12TH ST DAF: BEG SE COR SDBLK6 TH N TO SLY LN ST HWY#2 TH ELY TO ITS INTERSECTION W/E LN VAC 12TH ST TH S ALG SD E LN TO PT AT WHICH INTERSECTION WOULD OCCUR IF S LN LT9 WERE EXTED E TH SWLY TO POBE EXC PTN CONV TO CITY DAF:PTN LAND W/ N BNDRY OF ROW ST HWY#2 & E BNDRY IS E LN VAC 12TH ST & S & W BNDRY BY CUR OF A CIR W/RAD OF 45° SD CIR TAN TO ABOVE TWO DESC LNS & TOG W/PTN N1/2 VAC 17TH AVE LYG BTW WL N BLK6 EXTEDSLY & E LN VAC 12TH ST & PTNS LTS6,718 & 19 BLK6 & VAC 12TH ST LYG WITHIN 40° STP SLY OF, ABUTTING UPON, ADJ TO & CONTIG W/ROW HWY#2, SPO GEIGER FLD RD, DRAWN PAR WITH & 50° SLY MEAS RADIALLY FROM CLSD HWY & EXTENDING FR ELY LN VAC 12TH ST WLY TO WLY LN SD BLK

CONTACTS

APPLICANT: RENA PEYTON VERIZON WIRELESS (VAW) LLC

(d/b/a VERIZON WIRELESS) 3245 158TH AVE SE, MS 231 BELLEVUE, WA 98009 PHONE: (425) 603-2272

PROFESSIONAL OF RECORD:
BERT WHITE
LYNX CONSULTING, INC
17311 135TH AVE NE, SUITE A-100 WOODINVILLE, WA 98072 PHONE: (253) 230-2335

PROPERTY OWNER:

4301 W SUNSET BLVD

SPOKANE, WA 99224

APPLICANT AGENT:

JULEI CAMPOS LYNX CONSULTING, INC 17311 135TH AVE NE, SUITE A-100 WOODINVILLE, WA 98072 PHONE: (206) 388-7611 icampos@lvnxconsultina.ord

TOWER OWNER VERIZON WIRELESS (VAW) LLC (d/b/a VERIZON WIRELESS) 3245 158TH AVE SE, MS 231 BELLEVUE, WA 98009

PERMITTING CONTACT: AILEEN ZAVALES LYNX CONSULTING, INC


17311 135TH AVE NE. SUITE A-100 WOODINVILLE, WA 98072 PHONE: (206) 972-1368 azavales@lvnxconsultina.org

verizon

IMPLEMENTATION TEAM/CLIENT



DO NOT SCALE DRAWINGS. CONTRACTOR MUST VERIFY ALL DRAWINGS AND ADVISE CONSULTANTS OF ANY ERRORS OR MOSIGNON, NO VARIATIONS OR MODIFICATIONS TO WORK SHOWN SHAUL BE MEMELMENTED WITHOUT PRIOR WRITTEN APPROVAL ALL PREVIOUS ISSUES OF THIS DRAWINGS ARE SUPERSEDED BY THE LATEST REVISION, ALL DRAWINGS AND SPECIFICATIONS REMAIN THE PROPERTY OF LYNX CONSULTING, INC. NEITHER LYNX CONSULTING, INC. NOR THARCHHEET WILL BE PROVIDING CONSTRUCTION REVIEW OF THIS PROJECT.

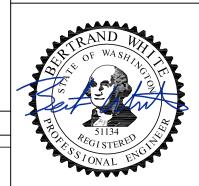

REV	DATE	DESCRIPTION				
_	_	-				
7	11/13/19	REVISED COMPOUND LOCATION				
6	9/18/19	REVISED PER COMMENTS AND ADDED MW				
5	5/23/19	FZD'S ISSUED FOR SUBMITTAL				
4	4/23/19	LANDSCAPING REMOVED				
3	4/08/19 TOWER RELOCATED A ADDITIONAL SURVEY A					
2	2/11/19	REVISED PER LL COMMENTS				
1	1/16/19	ZD'S ISSUED FOR REVIEW				
PROJEC	T:					

LIST OF DRAWINGS

CODE COMPLIANCE

APPROVALS

ALL WORK AND MATERIALS SHALL BE PERFORMED AND INSTALLED IN ACCORDANCE WITH THE CURRENT CONDITIONS OF THE FOLLOWING CODES AS ADOPTED BY THE LOCAL GOVERNING AUTHORITIES. NOTHING IN THESE PLANS IS TO BE CONSTRUED TO PERMIT WORK NOT CONFORMING TO THESE CODES:

WASHINGTON STATE AND LOCAL BUILDING CODES WITH THE FOLLOWING REFERENCE CODE

2015 INTERNATIONAL BUILDING CODE (IBC) 2015 INTERNATIONAL MECHANICAL CODE (IMC) 2015 INTERNATIONAL FIRE CODE (IFC)

2017 NATIONAL ELECTRIC CODE (NFPA 70)

SIGNATURE

ANSI/TIA-222-H (REVISION H)

TOPOGRAPHIC SURVEY AND EXISTING CONDITIONS MAP

TOPOGRAPHIC SURVEY AND EXISTING CONDITIONS MAP

SPO ASSEMBLY

4301 W SUNSET BLVD SPOKANE, WA 99224

DATE

COVER SHEET

PROJECT NUMBER:	DATE:
1	12/18/18
DRAFTER:	PROFESSIONAL OF RECORD
BEW	BEW
REVISION NO:	SHEET NO:
7	T 1
/	

GENERAL NOTES

- THESE DOCUMENTS ARE FOR THE DESIGN OF AN UNMANNED TELECOMMUNICATIONS FACILITY. THE FACILITY SHALL BE USED FOR THE TRANSMISSION OF RADIO SIGNALS FOR THE PURPOSE OF PROVIDING PUBLIC CELLULAR SERVICE. THE FACILITY WILL NOT BE OPEN TO THE PUBLIC AND SHALL HAVE RESTRICTED ACCESS TO THE WIRELESS CARRIER'S PERSONNEL AND SERVICE EQUIPMENT.
- PERSONNEL AND SERVICE EQUIPMENT.

 THE WIRELESS CARRIER CERTIFIES THAT THIS TELECOMMUNICATIONS FACILITY WILL BE SERVICED ONLY BY THE CARRIER'S
- ON AVERAGE THE WIRELESS CARRIER'S EMPLOYEES OR SUB-CONTRACTORS (TYPICALLY ONE PERSON) WILL VISIT THE WIRELESS FACILITY TWO TIMES PER MONTH FOR A DURATION OF APPROXIMATELY ONE HOUR.
- 4. THIS FACILITY IS UNMANNED AND IS NOT FOR HUMAN HABITATION (NO ADA ACCESS IS REQUIRED).

EMPLOYEES AND THEIR SUB-CONTRACTORS, FOR INSPECTION AND REPAIR PURPOSES ONLY.

- 5. THIS FACILITY WILL CONSUME NO UNRECOVERABLE ENERGY.
- 6. NO POTABLE WATER SUPPLY IS TO BE PROVIDED TO THIS FACILITY.
- 7. NO WASTE WATER WILL BE GENERATED FROM THIS FACILITY.
- 8. NO SOLID WASTE WILL BE GENERATED FROM THIS FACILITY.
- . WORK SHALL COMPLY WITH ALL APPLICABLE STATE AND FEDERAL CODES, ORDINANCES AND REGULATIONS. ALL NECESSARY LICENSES, CERTIFICATES, ETC., REQUIRED BY AUTHORITY HAVING JURISDICTION SHALL BE PROCURED AND PAID FOR BY THE CONTRACTOR.
- WORK SHALL COMPLY WITH ALL MANUFACTURER'S RECOMMENDED SPECIFICATIONS. THE CONTRACTOR SHALL FOLLOW SPECIFICATIONS SHOWN IN THESE DOCUMENTS, ONLY WHEN THOSE SPECIFICATIONS ARE MORE STRINGENT THAN THE MANUFACTURER'S.
- 11. WHERE ONE DETAIL IS SHOWN FOR ONE CONDITION, IT SHALL APPLY FOR ALL LIKE OR SIMILAR CONDITIONS, EVEN THOUGH NOT SPECIFICALLY MARKED ON THE DRAWINGS OR REFERRED TO IN THE SPECIFICATIONS, UNLESS OTHERWISE NOTED.
- 12. IN EVERY EVENT, THESE CONSTRUCTION DOCUMENTS AND SPECIFICATIONS SHALL BE INTERPRETED AS A MINIMUM ACCEPTABLE MEANS OF CONSTRUCTION. HOWEVER, THIS SHALL NOT RELIEVE THE CONTRACTOR, SUB-CONTRACTOR, AND/OR SUPPLIER/MANUFACTURER FROM PROVIDING A COMPLETE AND CORRECT JOB WHEN ADDITIONAL ITEMS ARE REQUIRED TO THE MINIMUM SPECIFICATIONS. IF ANY ITEMS NEED TO EXCEED THESE MINIMUM SPECIFICATIONS TO PROVIDE A COMPLETE, ADEQUATE AND SAFE WORKING CONDITION, THEN IT SHALL BE DEEMED AND UNDERSTOOD TO BE INCLUDED IN THE DRAWINGS. FOR EXAMPLE, IF AN ITEM AND/OR PIECE OF EQUIPMENT REQUIRES A LARGER WIRE SIZE (I.E. ELECTRICAL WIRE), STRONGER OR LARGER PIPING, INCREASED QUANTITY (I.E. STRUCTURAL ELEMENTS), REDUCED SPACING, AND/OR INCREASED LENGTH (I.E. BOLT/ BAR LENGTHS), THEN IT SHALL BE DEEMED AND UNDERSTOOD TO BE INCLUDED IN THE BID/PROPOSAL. THESE DOCUMENTS ARE MEANT TO SERVE AS A GUIDE AND ALL ITEMS REASONABLY INFERRED SHALL BE DEEMED TO BE INCLUDED.
- 13. SEE THE STRUCTURAL ANALYSIS BY OTHERS UNDER SEPARATE COVER FOR APPLICABLE CODE REFERENCES AND PROPOSED DESIGN LOADS.
- 14. NO WORK SHALL COMMENCE WITHOUT THE APPROVED STRUCTURAL ANALYSIS REPORT (STAMPED AND SIGNED) PROVIDED BY OTHERS UNDER SEPARATE COVER.
- 15. THE CONTRACTOR, PRIOR TO INSTALLATION OF ANTENNAS, EQUIPMENT, AND/OR COAX CABLES, SHALL REVIEW THE APPROVED STRUCTURAL ANALYSIS AND MODIFY, IF REQUIRED, ALL APPLICABLE MEMBERS AS INDICATED IN THE CERTIFIED STRUCTURAL ANALYSIS.
- 16. THESE DESIGN DOCUMENTS AND SPECIFICATIONS SHALL NOT BE CONSTRUED TO CREATE A CONTRACTUAL RELATIONSHIP OF ANY KIND BETWEEN THE ENGINEER AND THE CONTRACTOR.
- 17. THE CONTRACTOR SHALL BE RESPONSIBLE FOR DAILY CLEANUP OF ALL TRADES AND REMOVE ALL DEBRIS FROM THE CONSTRUCTION SITE. AT THE COMPLETION OF THE PROJECT, THE CONTRACTOR SHALL THOROUGHLY CLEAN THE BUILDING, SITE AND ANY SURROUNDING AREA TO BETTER THAN EXISTING CONDITION.
- 18. THE CONTRACTOR SHALL ADEQUATELY BRACE AND PROTECT ALL WORK DURING CONSTRUCTION AGAINST DAMAGE, BREAKAGE, COLLAPSE, ETC., ACCORDING TO APPLICABLE CODES, STANDARDS AND BEST CONSTRUCTION PRACTICES.
- 19. THE CONTRACTOR SHALL MEET ALL OSHA REQUIREMENTS FOR ALL SITE CONDITIONS AND INSTALLATIONS.
- 20. WHERE NEW PAVING, CONCRETE SIDEWALKS, OR PATHS MEET EXISTING CONSTRUCTION, THE CONTRACTOR SHALL MATCH THE EXISTING SLOPE AND ELEVATION AS TO MAINTAIN A SMOOTH TRANSITION.

- 21. ALL ITEMS NOT LISTED AS "EXISTING" OR "PROVIDED BY OTHERS" ARE TO BE SUPPLIED AND INSTALLED BY THE CONTRACTOR.
- 22. ALL MATERIALS FURNISHED UNDER THIS CONTRACT SHALL BE NEW, UNLESS OTHERWISE NOTED.
- 23. WHERE EXISTING MATERIALS ARE RE-USED, THE CONTRACTOR SHALL ENSURE THAT ALL OF THE EXISTING MATERIALS ARE FREE FROM DEFECTS OR HAVE BEEN REPAIRED TO LIKE NEW CONDITION.
- 24. ALL WORK SHALL BE GUARANTEED AGAINST DEFECTS IN MATERIALS AND WORKMANSHIP. THE CONTRACTOR SHALL REPAIR OR REPLACE AT THEIR EXPENSE ALL WORK THAT MAY DEVELOP DEFECTS IN MATERIALS OR WORKMANSHIP WITHIN ONE YEAR AFTER FINAL ACCEPTANCE OF THE ENTIRE PROJECT OR A PREDETERMINED PERIOD OF TIME (AS NEGOTIATED WITH THE PROPERTY OWNER AND WIRELESS CARRIER), WHICHEVER IS GREATER.
- 25. THE CONTRACTOR SHALL BE RESPONSIBLE FOR ALL DAMAGES TO THE EXISTING CONSTRUCTION AND REPAIR ALL DAMAGES TO BETTER THAN NEW CONDITION. THE CONTRACTOR SHALL NOTIFY THE ENGINEER OF ANY DAMAGE TO THE BUILDING SITE OR ANY ADJACENT STRUCTURES. THE PROPERTY OWNER SHALL BE SOLE AND FINAL JUDGE AS TO THE QUALITY OF THE REPAIRED CONSTRUCTION. ANY REPAIRS OR MODIFICATIONS WHICH MUST BE MADE SHALL BE MADE AT THE EXPENSE OF THE CONTRACTOR.
- 26. THE EXISTING CONDITIONS REPRESENTED HEREIN ARE BASED ON VISUAL OBSERVATIONS AND INFORMATION PROVIDED BY OTHERS. LYNX CONSULTING INC. CANNOT GUARANTEE THE CORRECTNESS NOR COMPLETENESS OF THE EXISTING CONDITIONS AS SHOWN AND ASSUMES NOR ESPONSIBILITY THEREOF. THE CONTRACTOR AND SUB—CONTRACTORS SHALL VISIT THE SITE AND VERIFY ALL EXISTING CONDITIONS AS REQUIRED FOR PROPER EXECUTION OF THE PROJECT. THE CONTRACTOR AND SUB—CONTRACTORS SHALL REPORT ANY CONFLICTS OR DISCREPANCIES TO THE ENGINEER PRIOR TO CONSTRUCTION.
- 27. THE CONTRACTOR SHALL CALL FOR UTILITY LOCATES, VERIFY LOCATIONS AND MARK ALL BURIED UTILITIES PRIOR TO PERFORMING ANY EXCAVATIONS OR GRADING ACTIVITIES
- 28. DO NOT SCALE THESE DRAWINGS. DIMENSIONS ARE EITHER TO THE FACE OF FINISHED ELEMENTS OR TO THE CENTERLINE OF ELEMENTS, UNLESS OTHERWISE NOTED. CRITICAL DIMENSIONS SHALL BE VERIFIED AND THE ENGINEER SHALL BE NOTIFIED OF ANY DISCREPANCIES IMMEDIATELY.
- 29. LYNX CONSULTING INC. HAS NOT CONDUCTED, NOR DOES IT INTEND TO CONDUCT ANY INVESTIGATION AS TO THE PRESENCE OF HAZARDOUS MATERIALS, INCLUDING, BUT NO LIMITED TO, ASBESTOS WITHIN THE CONFINES OF THIS PROJECT. LYNX CONSULTING INC. DOES NOT ACCEPT RESPONSIBILITY FOR THE INDEMNIFICATION, REMOVAL, OR ANY EFFECTS FROM THE PRESENCE OF THESE MATERIALS. IF EVIDENCE OF HAZARDOUS MATERIALS IS FOUND, WORK IS TO BE SUSPENDED AND THE PROPERTY OWNER NOTIFIED. THE CONTRACTOR IS NOT TO PROCEED WITH FURTHER WORK UNTIL INSTRUCTED BY THE PROPERTY OWNER IN WRITING.
- 30. THE GENERAL CONTRACTOR AND EACH SUBCONTRACTOR SHALL BE RESPONSIBLE FOR VERIFYING ALL EXISTING CONDITIONS, DIMENSIONS, AND UTILITIES ON SITE PRIOR TO THE COMMENCEMENT OF WORK. ALL DISCREPANCIES BETWEEN THESE DOCUMENTS AND THE EXISTING ONSITE CONDITIONS SHALL BE IMMEDIATELY BROUGHT TO THE ENGINEER'S ATTENTION. NO CLAIM FOR ADDITIONAL COMPENSATION FOR WORK WHICH COULD HAVE BEEN FORESEEN BY AN INSPECTION, WHETHER SHOWN ON THE CONTRACT DOCUMENTS OR NOT, WILL BE ACCEPTED OR PAID.
- 31. THE CONTRACTOR SHALL VERIFY AND COORDINATE SIZE AND LOCATION OF ALL OPENINGS FOR STRUCTURAL, MECHANICAL, FLECTRICAL PLIMBING CIVIL OR ARCHITECTURAL WORK
- 32. THE CONTRACTOR SHALL VERIFY THAT NO CONFLICTS EXIST BETWEEN THE LOCATIONS OF ANY AND ALL MECHANICAL, ELECTRICAL, PLUMBING, OR STRUCTURAL ELEMENTS AND THAT ALL REQUIRED CLEARANCES FOR THE INSTALLATION AND MAINTENANCE ARE MET. IN THE CASE OF ANY CONFLICTS, THE ENGINEER SHALL BE NOTIFIED IMMEDIATELY. THE ENGINEER HAS THE RIGHT TO MAKE MINOR MODIFICATIONS IN THE DESIGN OF THE FACILITY WITHOUT THE CONTRACTOR GETTING ADDITIONAL COMPENSATION.
- 33. IF THE CONTRACTOR OR SUB-CONTRACTORS FIND IT NECESSARY TO DEVIATE FROM THE ORIGINAL APPROVED PLANS, THEN IT IS THE CONTRACTOR'S AND THE SUB-CONTRACTOR'S RESPONSIBILITY TO PROVIDE THE ENGINEER WITH COPIES OF THE PROPOSED CHANGES FOR THEIR APPROVAL BEFORE PROCEEDING WITH THE WORK. IN ADDITION, THE CONTRACTOR SHALL BE RESPONSIBLE FOR PROCURING ALL NECESSARY APPROVALS FROM THE BUILDING AUTHORITIES FOR THE PROPOSED CHANGES BEFORE PROCEEDING WITH THE WORK. THE CONTRACTOR AND SUB-CONTRACTORS SHALL BE RESPONSIBLE FOR PROCURING ALL NECESSARY INSPECTIONS AND APPROVALS FROM BUILDING AUTHORITIES DURING EXECUTION OF THE WORK.

CONCRETE NOTES

 CONCRETE SHALL BE MIXED, PROPORTIONED, CONVEYED AND PLACED IN ACCORDANCE WITH CHAPTER 19 OF THE IBC 2015, STRENGTHS AT 28 DAYS AND MIX CRITERIA SHALL BE AS FOLLOWS.

W/C RATIO

MINIMUM CEMENT

1. ALL CONCRETE CONSTRUCTION SHALL BE IN ACCORDANCE WITH ACI-318

	(fc)	,	CONTENT PER CUBIC YARD
SLAB ON GRADE TOPPING SLABS CONCRETE PIERS	3,000 PSI	≤ 0.45	5 1/2 SACKS
ALL STRUCTURAL CONCRETE	4,000 PSI	≤ 0.45	6 1/2 SACKS
CONCRETE WALLS	4,000 PSI	≤ 0.45	6 1/2 SACKS

CEMENT SHALL BE ASTM C150, PORTLAND CEMENT TYPE II U.N.O.

TYPE OF CONSTRUCTION 28 DAY STRENGTH

- THE GENERAL CONTRACTOR SHALL SUPERVISE AND BE RESPONSIBLE FOR THE METHODS AND PROCEDURES OF CONCRETE PLACEMENT.
- 4. ALL CONCRETE WITH SURFACES EXPOSED TO STANDING WATER SHALL BE AIR-ENTRAINED WITH AN AIR-ENTRAINMENT AGENT CONFORMING TO ASTM C260, C494, C989, AND C1017, TOTAL AIR CONTENT SHALL BE IN ACCORDANCE WITH TABLE 1904.2.1 OF THE IBC 2015.
- 5. REINFORCING STEEL SHALL CONFORM TO ASTM A615 (INCLUDING SUPPLEMENTS S1), GRADE 60, f_=60,000 PSI. EXCEPTIONS: ANY BARS SPECIFICALLY SO NOTED ON THE DRAWINGS SHALL BE GRADE 40, f_=40,000 PSI. GRADE 60 REINFORCING BARS INDICATED ON DRAWINGS TO BE WELDED SHALL CONFORM TO ASTM A706. REINFORCING COMPLYING WITH ASTM A615(S1) MAY BE WELDED ONLY IF MATERIAL PROPERTY REPORTS INDICATING CONFORMANCE WITH WELDING PROCEDURES SPECIFIED IN A.W.S. D14 ARE SUBMITTED.
- 6. REINFORCING STEEL SHALL BE DETAILED (INCLUDING HOOKS AND BENDS) IN ACCORDANCE WITH ACI 315 AND 318. LAP ALL CONTINUOUS REINFORCEMENT AT LEAST 30 BAR DIAMETERS OR A MINIMUM OF 2'-O". PROVIDE CORNER BARS AT ALL WALL AND FOOTING INTERSECTIONS. LAP CORNER BARS AT LEAST 30 BAR DIAMETERS OR A MINIMUM OF 2'-O". LAP ADJACENT MATS OF WELDED WIRE FABRIC A MINIMUM OF 8" AT SIDES AND ENDS.
- 7. WELDED WIRE FABRIC SHALL CONFORM TO ASTM A-165.
- 8. SPIRAL REINFORCEMENT SHALL BE PLAIN WIRE CONFORMING TO ASTM A615, GRADE 60, $f_\nu {=}\,60,\!000$ PSI.
- 9. NO BARS PARTIALLY EMBEDDED IN HARDENED CONCRETE SHALL BE FIELD BENT UNLESS SPECIFICALLY DO DETAILED OR APPROVED BY THE ENGINEER.
- 10. CONCRETE PROTECTION (COVER) FOR REINFORCING STEEL SHALL BE AS FOLLOWS:


SURFACES, EARTH FACE		
FORMED SURFACES EXPOSED TO EARTH OR WEATHER	(#6 BARS OR LARGER) (#5 BARS OR SMALLER)	2" 1-1/2"
SLABS AND WALLS (INTERIOR FACE)		3/4"

- 11. BARS SHALL BE SUPPORTED ON CHAIRS OR DOBIE BRICKS.
- 12. ANCHOR BOLTS TO CONFORM TO ASTM A307.

FOOTINGS AND OTHER LINEORMED

- 13. NON-SHRINKING GROUT SHALL BE FURNISHED BY AN APPROVED MANUFACTURER AND SHALL BE MIXED AND PLACED IN STRICT ACCORDANCE WITH THE MANUFACTURER'S PUBLISHED RECOMMENDATIONS. GROUT STRENGTH SHALL BE AT LEAST EQUAL TO THE MATERIAL ON WHICH IT IS PLACED (3,000 PSI MINIMUM).
- 14. ALL EXPANSION ANCHORS TO BE HILTI BRAND. ADHESIVE ANCHORS REQUIRE TESTING TO CONFIRM CAPACITY UNLESS WAIVED BY ENGINEER.

LEGEND

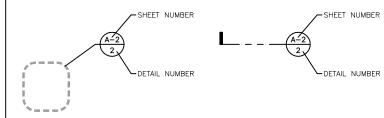

LARGE SCALE DETAIL

SECTION DETAIL

Call Before You Dig

SPECIAL INSPECTIONS

RECOMMENDED TESTING AGENCY: PHONE: (___) _____ PHONE: (___) _____

THE OWNER, OR THE OWNER'S AGENT, IS REQUIRED TO HIRE AN INDEPENDENT TESTING/INSPECTION AGENCY TO PERFORM REQUIRED SPECIAL INSPECTIONS.

THE INDEPENDENT AGENCY HIRED TO PERFORM THE DUTIES OF SPECIAL INSPECTION IS REQUIRED TO BE A REGISTERED AGENCY WITH WASHINGTON ASSOCIATION OF BUILDING OFFICIALS (WABO), UNDER THE SPECIAL INSPECTION REGISTRATION PROGRAM (SIRP) STANDARD NO. 1701 OR MOST CURRENT ADOPTED SPECIAL INSPECTION STANDARD PUBLISHED BY WABO.

SPECIAL INSPECTOR MUST BE CONTACTED IN ADVANCE OF ANY WORK NOTED BELOW. IT IS THE RESPONSIBILITY OF THE OWNER OR OWNER'S DESIGNEE TO NOTIFY THE SPECIAL INSPECTION AGENCY AND SCHEDULE A BUILDING INSPECTION IN A TIMELY MANNER. COPIES OF ALL INSPECTION REPORTS MUST BE POSTED ON SITE AND SUMMARY LETTERS SUBMITTED TO THE BUILDING INSPECTION SUPERVISOR. UNRESOLVED NON-CONFORMANCIES MUST BE BROUGHT TO THE IMMEDIATE ATTENTION OF THE MUNICIPALITY'S INSPECTOR.

REQUIRED SPECIAL INSPECTIONS 2015 INTERNATIONAL BUILDING CODE; SECTIONS 1701, 1704, & 1705 STRUCTURAL STEEL (1705.2; AISC 360) STEEL - OTHER THAN STRUCTURAL STEEL (1705.2.2) INTUMESCENT FIRE-RESIST CTGS (1705.14)

STEEL - OTHER THAN STRUCTURAL STÉEL (1705.2.2) INTUMESCENT FIRE-RESIST CTGS (1705.14)

STRUCTURAL CONCRETE (1705.3) EIFS (1705.15)

REINF. STEEL/PRESTRESSING TENDONS (1705.3) POST-INSTALLED ANCHORS (1705.3; AISC 315: D.9.2)

SHOTCRETE (1705.3; 1910) SMOKE CONTROL (1705.17)

 □ SHOTCRETE (1705.3; 1910)
 □ SMOKE CONTROL (1705.17)

 □ STRUCTURAL MASONRY (1075.4)
 □ STRUCTURAL STEEL (SFRS 1705.11.1; AISC 314)

 TMS 402/ACI 530/ASCE 5;
 □ STRUCTURAL WOOD (SFRS 1705.11.2)

□ DRIVEN DEEP FOUNDATIONS (1705.7) □ ARCHITECTURAL COMPONENTS (SFRS 1705.11.5)
□ CAST-IN-PLACE DEEP FOUNDATIONS (1705.8) □ MECH. AND ELEC. COMPONENTS (SFRS 1705.11.6)

☐ INSTALLATION OF PRECAST ELEMENTS (1705.3) ☐ SEISMIC ISOLATION SYSTEMS (SFRS 1705.11.8) ☐ OTHER

STRUCTURAL STEEL NOTES

- SHOP DRAWINGS FOR STRUCTURAL STEEL SHALL BE SUBMITTED TO THE CONSULTANT FOR REVIEW PRIOR TO FABRICATION.
- 2. STRUCTURAL STEEL DESIGN, FABRICATION AND ERECTION (INCLUDING FIELD WELDING, HIGH STRENGTH FIELD BOLTING, EXPANSION BOLTS, AND THREADED EXPANSION ANCHORS) SHALL BE BASED ON ALISI. "SPECIFICATION FOR THE DESIGN, FABRICATION AND ERECTION OF STRUCTURAL STELL FOR BUILDINGS" LATEST EDITION. SUPERVISION SHALL BE IN ACCORDANCE WITH IBC 2015 CHAPTER 22, BY A QUALIFIED TESTING AGENCY DESIGNATED BY THE ENGINEER. THE ENGINEER SHALL BE FURNISHED WITH A COPY OF ALL INSPECTION REPORTS AND TEST RESULTS.
- 3. STRUCTURAL STEEL SHALL CONFORM TO THE FOLLOWING REQUIREMENTS:

TYPE OF MEMBER

 WIDE FLANGE SHAPE S
 ASTM A992, fy 50 KSI

 OTHER SHAPES, PLATES AND RODS
 ASTM A36, fy 36 KSI

 PIPE COLUMNS
 ASTM A50, fy 35 KSI

 STRUCTURAL TUBING
 ASTM A500, fy 46 KSI

 ANCHOR BOLTS
 ASTM A307

 CONNECTION BOLTS
 ASTM A325

- 4. ALL MATERIAL TO BE HOT DIPPED GALVANIZED AFTER FABRICATION PER A123/A123M-00.
- 5. ALL WELDING SHALL BE IN CONFORMANCE WITH A.I.S.I. AND AWS STANDARDS AND SHALL BE PERFORMED BY WABO CERTIFIED WELDERS USING E70 XX ELECTRODES. ONLY PREQUALIFIED WELDS (AS DEFINED BY AWS) SHALL BE USED. WELDING OF GRADE 60 REINFORCING BARS (IF REQUIRED) SHALL BE PERFORMED USING LOW HYDROGEN ELECTRODES. WELDING OF GRADE 40 REINFORCING BARS (IF REQUIRED) SHALL BE PERFORMED USING E70 XX ELECTRODES. WELDING WITH A" OF COLD BENDS IN REINFORCING STEEL IS NOT PERMITTED. SEE REINFORCING NOTE FOR MATERIAL REQUIREMENTS OF WELDED BARS.
- 6. COLD-FORMED STEEL FRAMING MEMBERS SHALL BE OF THE SHAPE, SIZE AND GAGE SHOWN ON THE PLANS. PROVIDE MINIMUM SECTION PROPERTIES INDICATED. ALL COLD-FORMED STEEL FRAMING SHALL CONFORM TO THE A.I.S.I. "SPECIFICATION FOR THE DESIGN OF COLD-FORMED STEEL STRUCTURAL MEMBERS".
- BOLTED CONNECTIONS SHALL USE BEARING TYPE ASTM A325 BOLTS (3/4" DIAMETER) AND SHALL HAVE A MINIMUM OF TWO BOLTS UNLESS NOTED OTHERWISE.
- NON-STRUCTURAL CONNECTIONS FOR STEEL GRATING MAY USE 5/8" DIAMETER ASTM A307 BOLTS UNLESS NOTED OTHERWISE.
- 9. ALL STEEL WORK SHALL BE PAINTED IN ACCORDANCE WITH THE DESIGN AND CONSTRUCTION SPECIFICATION AND IN ACCORDANCE WITH ASTM A36 UNLESS NOTED OTHERWISE.
- 10. ALL WELDS TO BE 1/4" FILLET UNLESS NOTED OTHERWISE.
- 11. TOUCH UP ALL FIELD DRILLING AND WELDING WITH 2 COATS OF GALVACON (ZINC RICH PAINT) OR APPROVED EQUAL.

SHEET TITLE:

GENERAL NOTES

PROJECT NUMBER: DATE:
12/18/18

DRAFTER: PROFESSIONAL OF RECORD BEW

REVISION NO: SHEET NO:

DO NOT SCALE DRAWINGS. CONTRACTOR MUST VERIFY ALL DRAWINGS AND ADVISE CONSULTANTS OF ANY ERRORS OR MISSIONS. NO VARRATIONS OR MODIFICATIONS TO WORK SHOWN SHALL BE MIPLEMENTED WITHOUT PRIOR WRITTEN PAPROVAL. ALL PREVIOUS ISSUES OF THIS DRAWINGS ARD SPECIFICATIONS REMAIN THE PROPERTY OF LYNK.

IMPLEMENTATION TEAM/CLIENT



ARCHITECT WILL BE PROVIDING CONSTRUCTION REVIEW OF THIS PROJECT.

REVISED COMPOUND 11/13/19 LOCATION REVISED PER COMMENTS 9/18/19 AND ADDED MW FZD'S ISSUED 5/23/19 4/23/19 LANDSCAPING REMOVED TOWER RELOCATED AND 4/08/19 ADDITIONAL SURVEY ADDE 2/11/19 LL COMMENTS ZD'S ISSUED FOR REVIEW

DESCRIPTION


PROJECT:

RFV

DATE

SPO ASSEMBLY

4301 W SUNSET BLVD SPOKANE, WA 99224

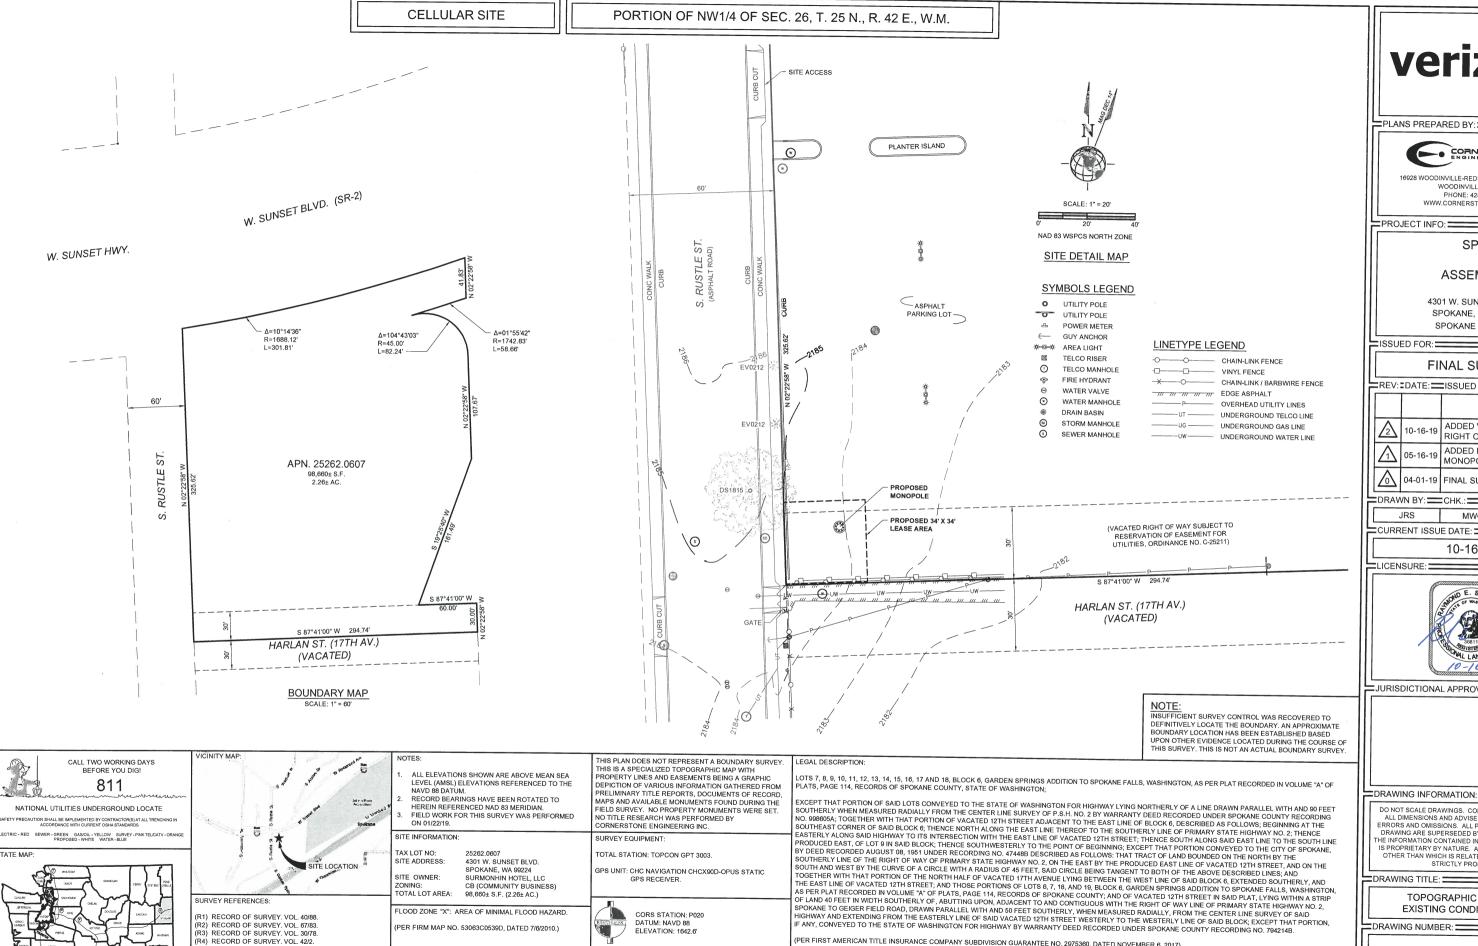

DATUM: NAVD 88

ELEVATION: 1642.6

BENCHMARK DISCLAIMER: ELEVATIONS ESTABLISHED AT THIS SITE ARE REFERENCED TO THE ABOVE NAMED

CORS STATION. NO EFFORT WAS MADE TO CHECK FOR

LOCAL BENCHMARKS. THE ELEVATIONS ARE ACCURATE WITHIN THE FAA TOLERANCE REQUESTED FOR THIS PROJECT.

EASEMENTS OF RECORD

(PER FIRST AMERICAN TITLE INSURANCE COMPANY SUBDIVISION GUARANTEE NO. 2975360, DATED NOVEMBER 6, 2017).

10. SUBJECT TO EASEMENT IN FAVOR OF COMCAST FOR BROADBAND COMMUNICATIONS SYSTEM, RECORDED JANUARY 18, 2008 UNDER RECORDING NO. 5632872. (THE DESCRIPTION CONTAINED THEREIN IS NOT SUFFICIENT TO PLOT HEREON)

PER FIRM MAP NO. 53063C0539D, DATED 7/6/2010.)

COORDINATE DATA @ CENTER PROPOSED MONOPOLE

47° 38' 21.67" N

117° 28' 22.49" W 2184.0 FEET

LATITUDE

LONGITUDE -

R2) RECORD OF SURVEY, VOL. 67/83.

R3) RECORD OF SURVEY, VOL. 30/78.

R5) RECORD OF SURVEY, VOL. 137/7.

R6) RECORD OF SURVEY VOL 45/22

verizon/

PLANS PREPARED BY:



16928 WOODINVILLE-REDMOND RD NE, SUITE 210 WOODINVILLE, WA 98072 PHONE: 425.487.1732 WWW CORNERSTONE-ENGR COM

=PROJECT INFO: =

SPO

ASSEMBLY

4301 W SUNSET BLVD SPOKANE, WA 99224 SPOKANE COUNTY

ISSUED FOR:

FINAL SURVEY

ſ	-REV:	-DATE:	ISSUED FOR:	BY:
	2	10-16-19	ADDED VACATED RIGHT OF WAY	JRS
l	\triangle	05-16-19	ADDED PROPOSED MONOPOLE LOCATION	JRS
		04-01-19	FINAL SURVEY	JRS

DRAWN BY: CHK.:

MWO JRS

10-16-19

I ICENSURE:



JURISDICTIONAL APPROVAL:

DRAWING INFORMATION:

DO NOT SCALE DRAWINGS. CONTRACTOR MUST VERIFY ALL DIMENSIONS AND ADVISE CONSULTANTS OF ANY ERRORS AND OMISSIONS. ALL PREVIOUS ISSUES OF THIS DRAWING ARE SUPERSEDED BY THE LATEST REVISION. THE INFORMATION CONTAINED IN THIS SET OF DOCUMENTS IS PROPRIETARY BY NATURE. ANY USE OR DISCLOSURE OTHER THAN WHICH IS RELATED TO NAMED CLIENT IS STRICTLY PROHIBITED.


DRAWING TITLE:


TOPOGRAPHIC SURVEY & EXISTING CONDITIONS MAP

DRAWING NUMBER:

18-55006

CELJOB NUMBER:

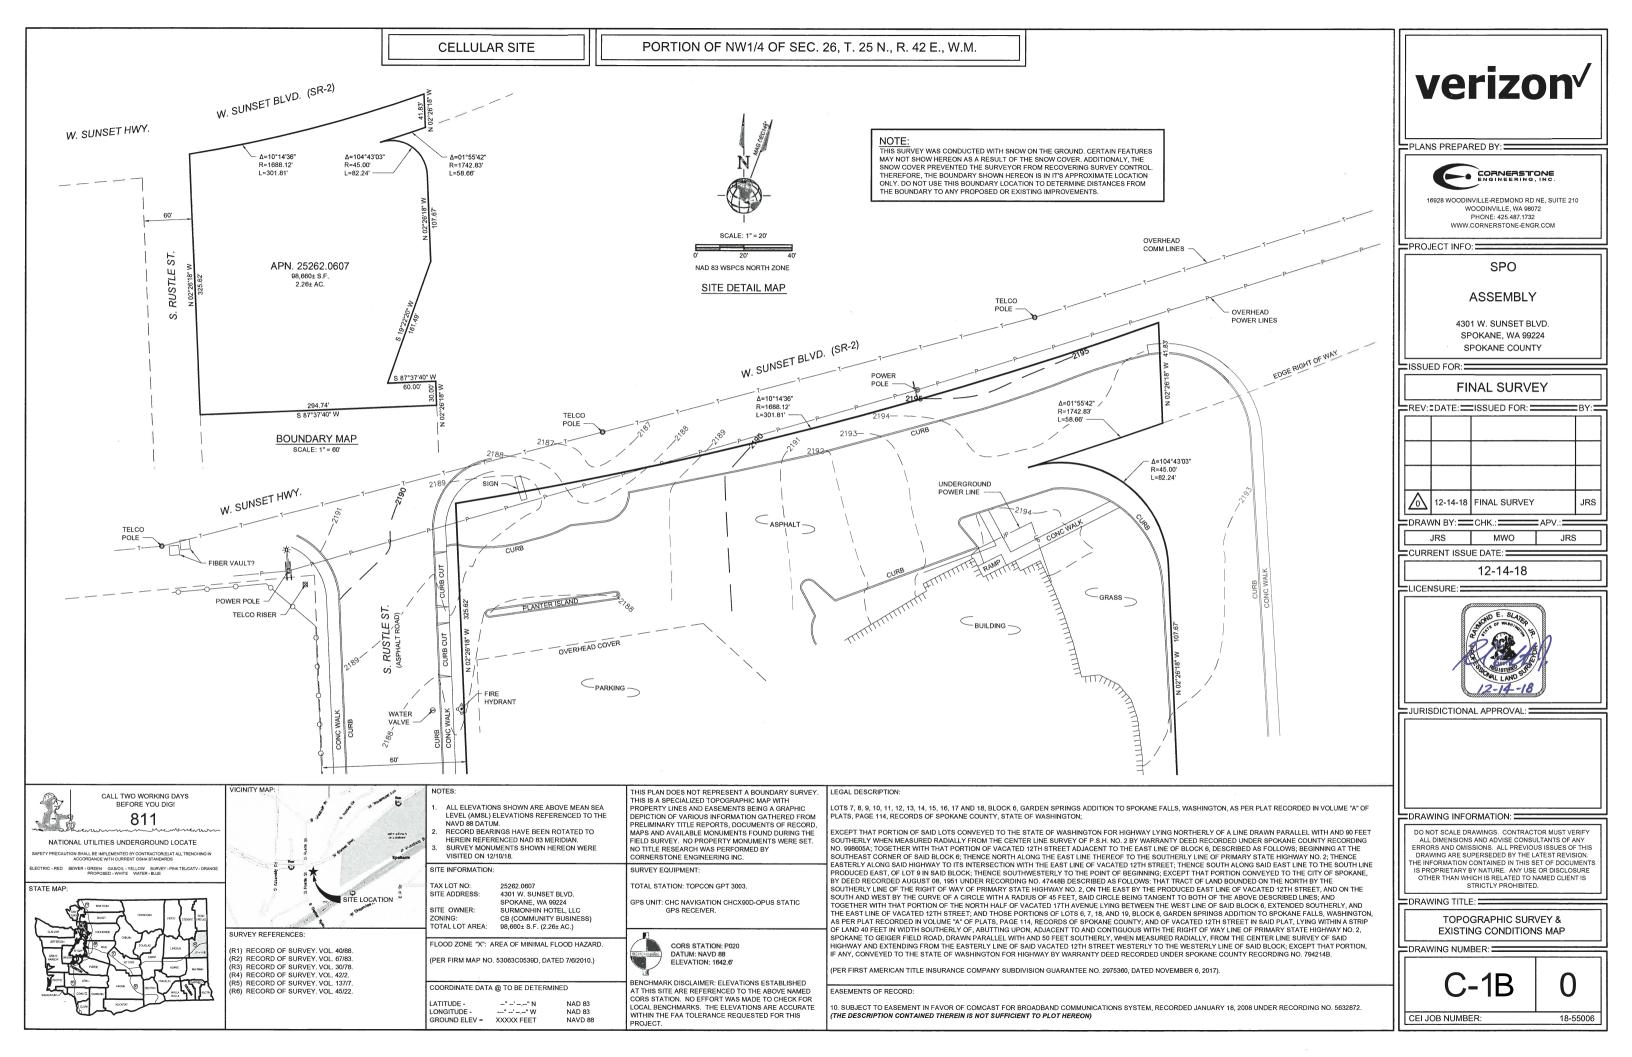

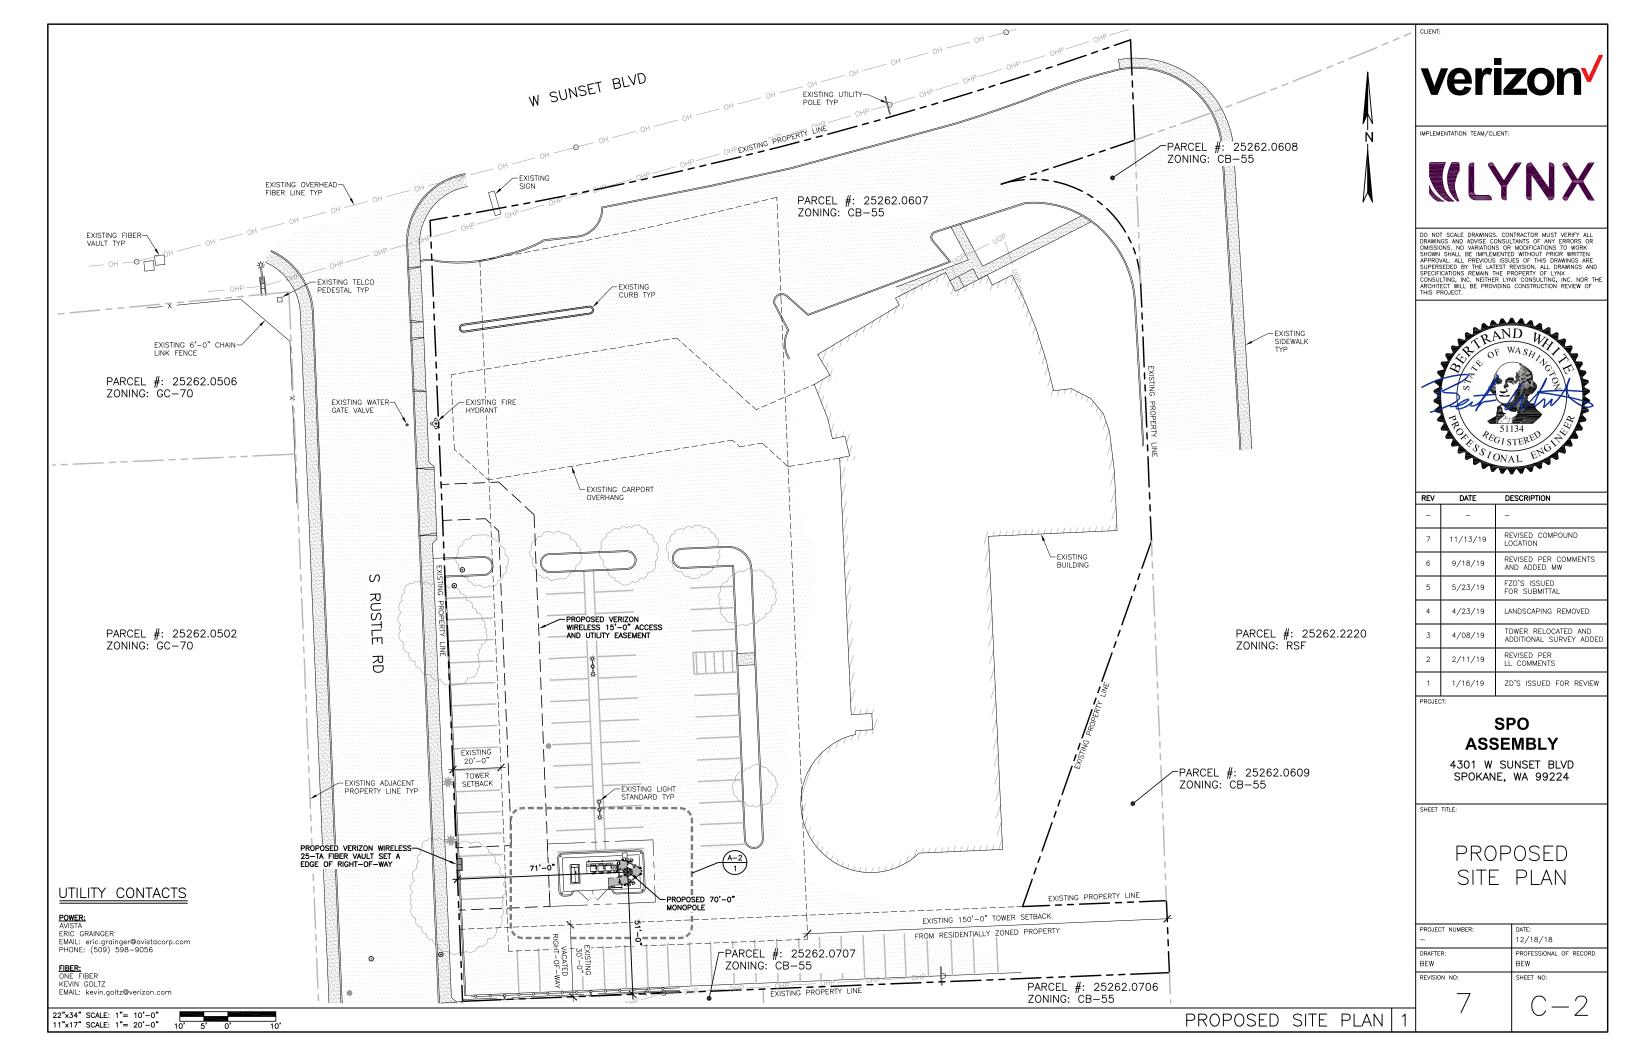

EXISTING LIGHT STANDARD IMPLEMENTATION TEAM/CLIENT: EXISTING ASPHALT— PARKING LOT EXISTING PARKING LOT STRIPING TYP EXISTING STRIPE TO BE REMOVED SPO 4301 W SUNSET BLVD SPOKANE, WA 99224 EXISTING ASPHALT PARKING LOT SHEET TITLE: EXISTING EDGE OF 30'-0"-VACATED RIGHT-OF-WAY 22"x34" SCALE: 3/8"= 1'-0" 11"x17" SCALE: 3/16"= 1'-0" 2' 1' 0' 2' EXISTING COMPOUND PLAN

verizon /



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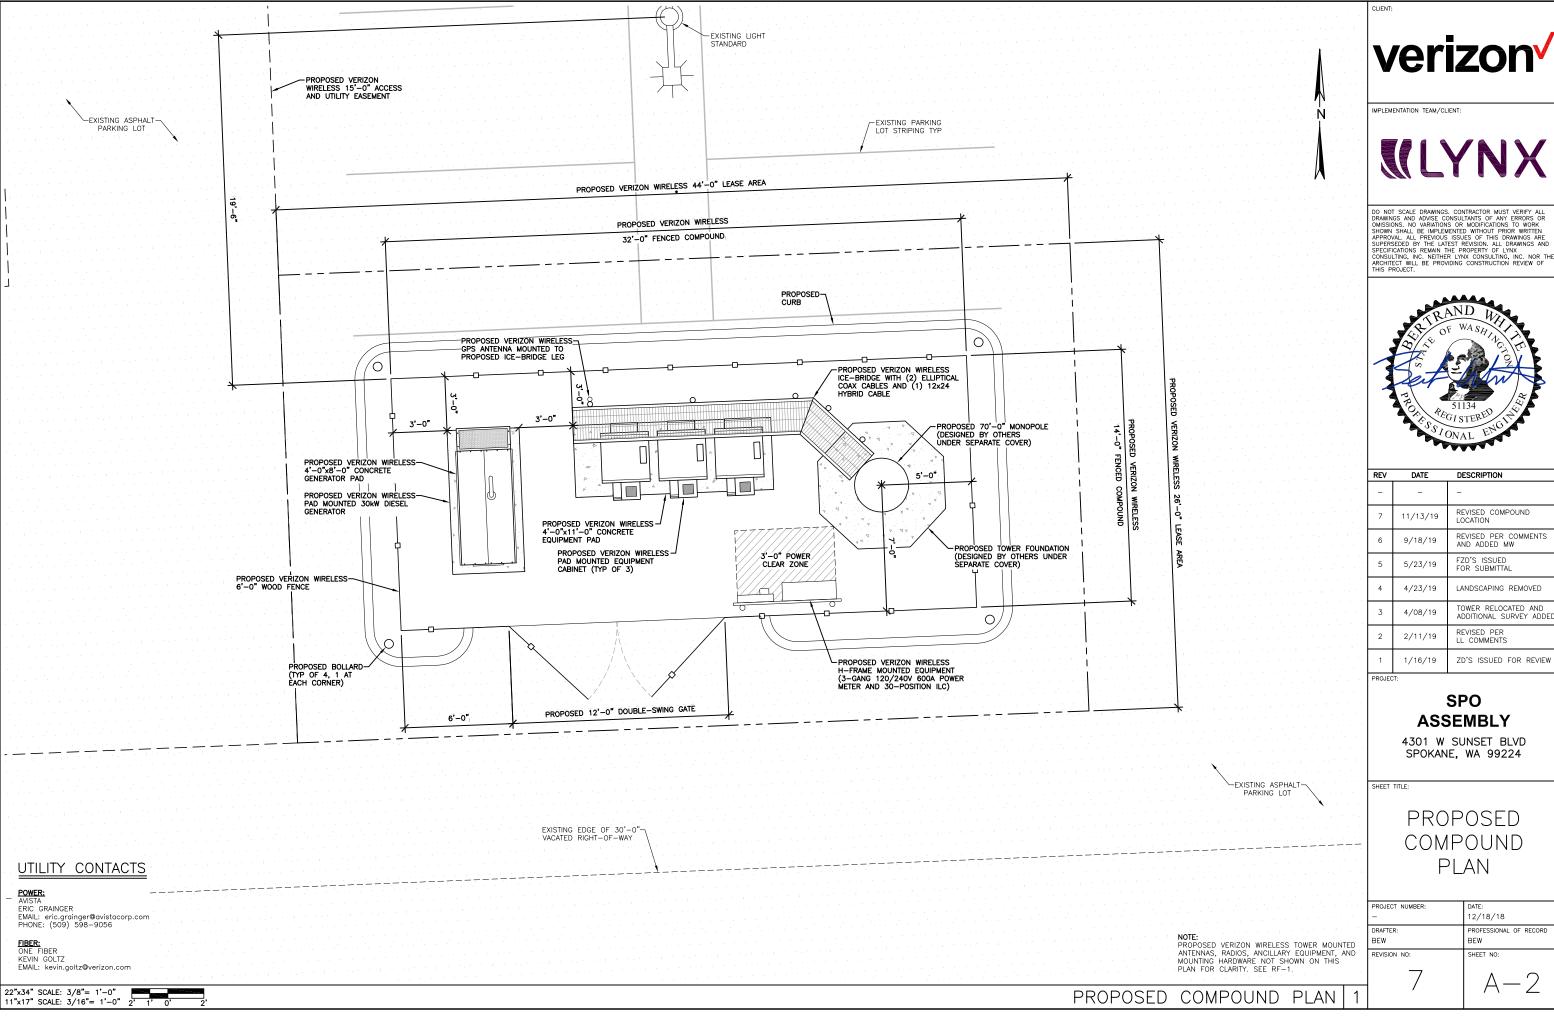


REV	DATE DESCRIPTION					
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5	5/23/19	FZD'S ISSUED FOR SUBMITTAL				
4	4/23/19	LANDSCAPING REMOVED				
3	4/08/19 TOWER RELOCATED AT ADDITIONAL SURVEY A					
2	2/11/19	REVISED PER LL COMMENTS				
1	1/16/19	ZD'S ISSUED FOR REVIEW				
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ASSEMBLY

EXISTING COMPOUND PLAN

PROJECT NUMBER:	DATE:
-	12/18/18
DRAFTER:	PROFESSIONAL OF RECORD
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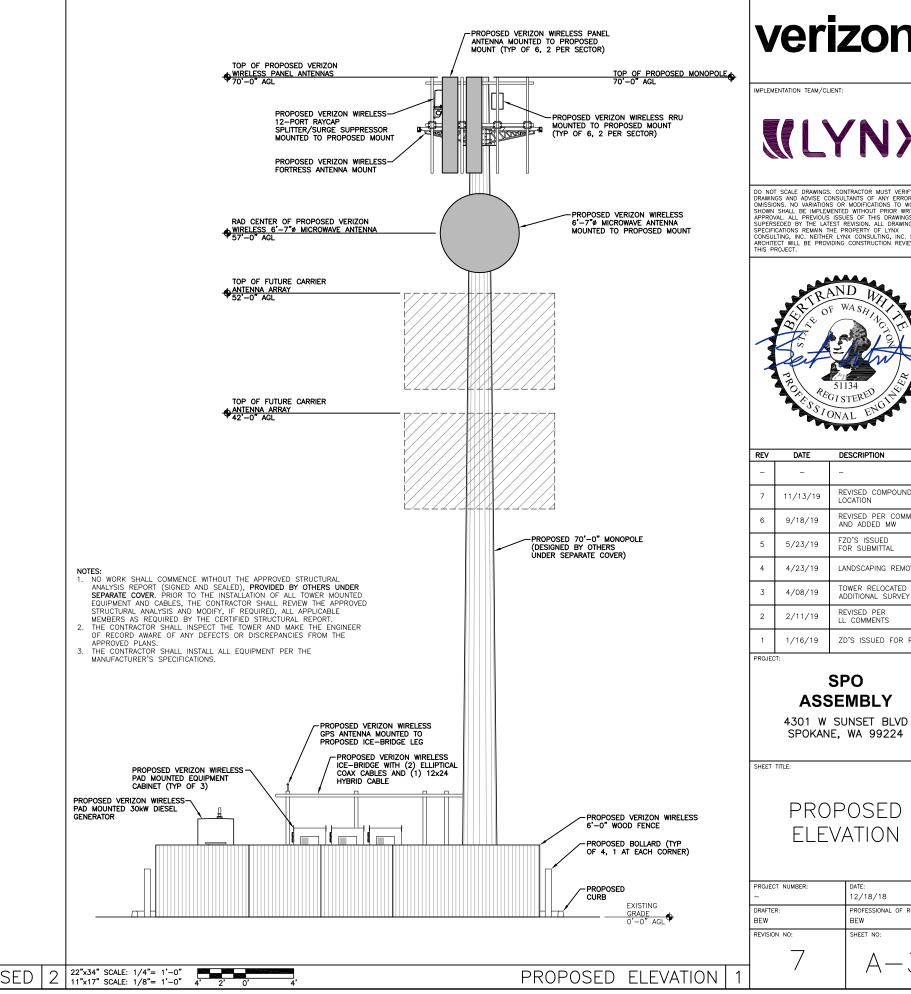
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	-	12/18/18				
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SPO ASSEMBLY

SPOKANE, WA 99224

PROPOSED ELEVATION


PROJECT NUMBER:	DATE:					
=	12/18/18					
DRAFTER:	PROFESSIONAL OF RECORD					
BEW	BEW					
REVISION NO:	SHEET NO:					
	, -,					

PROPOSED ANTENNA SCHEDULE MECH ELEC CABLE FEEDER FEEDER TILT TILT QTY TYPE LENGTH ADDITIONAL EQUIPMENT AZIMUTH QTY VENDOR MODEL LENGTH WIDTH DEPTH SECTOR HEIGHT 850 LTE RRUS4449 B5/B13 700 LTE MX06FIT845-02 95.9" 15.4" 10.7" PCS LTE 0. RRUS8843 B2/B66 12x24 HYBRID 90'-0" 850 LTE 6* NONE 700 LTE 10° 70'-0" JMA MX06FIT845-02 95.9" 15.4" 10.7" 3° 6* NONE AWS LTE NONE ELEC CABLE FEEDER FEEDER TILT QTY TYPE LENGTH BETA ADDITIONAL TIP MECH TILT HEIGHT OTY **AZIMUTH** VENDOR MODEL LENGTH WIDTH DEPTH SECTOR **EQUIPMENT** 850 LTE RRUS4449 B5/B13 10.7" 700 LTE 160° MX06FR0860-02 95.9" 15.4 JMA PCS LTE RRUS8843 B2/B66 NA NA 850 LTE NONE 95.9" 10.7" 700 LTE 160° 70'-0 JMA MX06FR0860-02 15.4 2° .3* NONE AWS LTE NONE GAMMA MECH ELEC CABLE FEEDER FEEDER TILT TILT QTY TYPE LENGTH ADDITIONAL TIP AZIMUTH VENDOR MODEL LENGTH DEPTH SECTOR HEIGHT EQUIPMENT 850 LTE RRUS4449 B5/B13 95.9" 10.7" 700 LTE 275° MX06FIT845-02 15.4" JMA PCS LTE RRUS8843 B2/B66 NA NA 2* 850 LTE NONE 10.7" 70'-0" 95.9" 15.4" 700 LTE 275° JMA MX06FIT845-02 -2* 2* NONE AWS LTE NONE

-PROPOSED VERIZON WIRELESS 850/700/PCS LTE PANEL ANTENNA MOUNTED TO PROPOSED MOUNT -PROPOSED VERIZON WIRELESS 850/700/AWS LTE PANEL ANTENNA MOUNTED TO PROPOSED VERIZON WIRELESS— 12—PORT RAYCAP SPLITTER/SURGE SUPPRESSOR MOUNTED TO PROPOSED MOUNT PROPOSED MOUNT -PROPOSED VERIZON WIRELESS RRU MOUNTED TO PROPOSED MOUNT (TYP OF 6, 2 PER SECTOR) PROPOSED VERIZON WIRELESS-850/700/AWS LTE PANEL ANTENNA MOUNTED TO PROPOSED MOUNT GAMMA
AZ=275* PROPOSED VERIZON WIRELESS-850/700/PCS LTE PANEL ANTENNA MOUNTED TO PROPOSED MOUNT -PROPOSED 70'-0" MONOPOLE (DESIGNED BY OTHERS UNDER SEPARATE COVER) PROPOSED VERIZON WIRELESS 850/700/PCS LTE PANEL ANTENNA MOUNTED TO PROPOSED VERIZON WIRELESS-FORTRESS ANTENNA MOUNT PROPOSED MOUNT -PROPOSED VERIZON WIRELESS 850/700/AWS LTE PANEL ANTENNA MOUNTED TO

22"x34" SCALE: NOT TO SCALE NOT USED 11"x17" SCALE: NOT TO SCALE

PROPOSED MICROWAVE SCHEDULE											
SECTOR AZIMUTH RAD CENTER QTY VENDOR MODEL DIAMETER TILT CABLE FEEDER FEEDER ADDITIONAL EQUIPMENT											
TBD	TBD	57'-0"	1	RFS	UXA6	6'-7"ø	TBD	2	EWP63	75'-0"	NONE

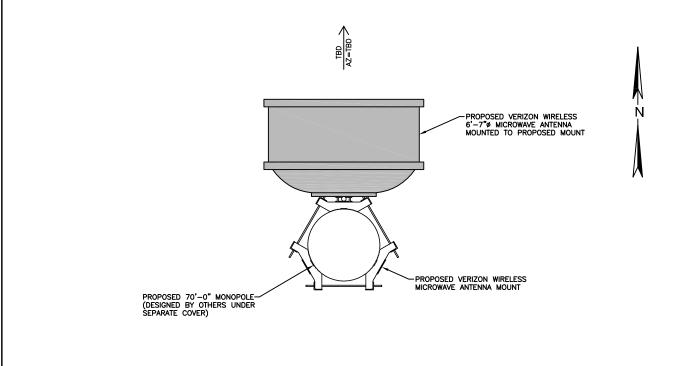



IMPLEMENTATION TEAM/CLIENT:



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PROJECT:			

SPO ASSEMBLY


4301 W SUNSET BLVD SPOKANE, WA 99224

SHEET TITLE:

PROPOSED ANTENNA CONFIGURATIONS

PROJECT NUMBER:	DATE:		
-	12/18/18		
DRAFTER:	PROFESSIONAL OF RECORD		
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REVISION NO:	SHEET NO:		

RF-1

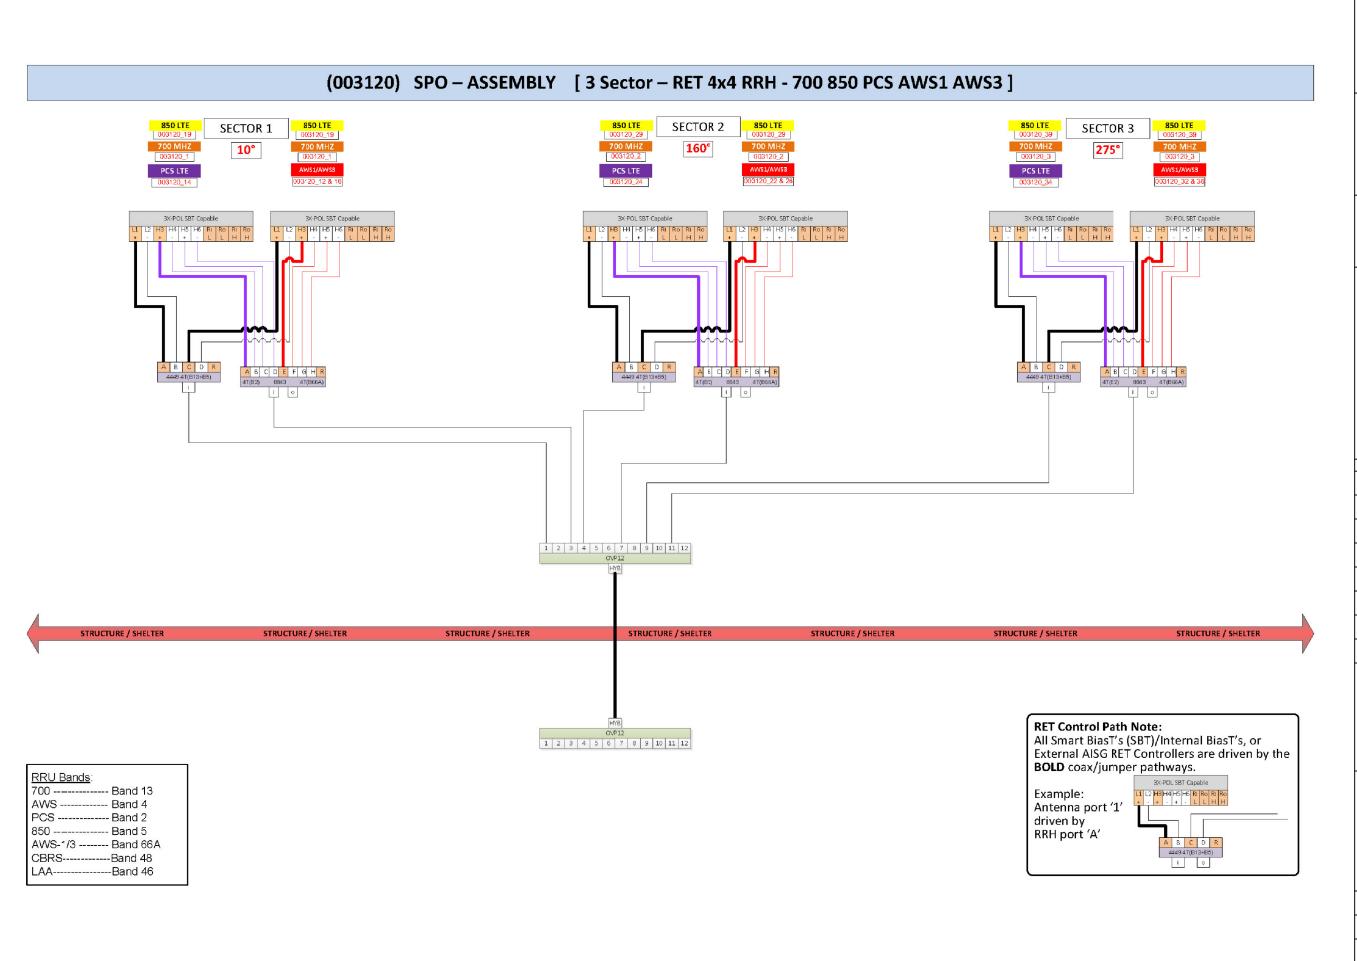

CLIENT:

verizon v

IMPLEMENTATION TEAM/CLIENT:



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PROJECT:

SPO ASSEMBLY

4301 W SUNSET BLVD SPOKANE, WA 99224

SHEET TITLE:

PROPOSED IT DIAGRAM

PROJECT NUMBER:	DATE:	
1	12/18/18	
DRAFTER:	PROFESSIONAL OF RECORD	
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