

General Notes

- 1. CONTRACTOR TO VERIFY LOCATION OF ALL UTILITIES PRIOR TO INITIATION OF ANY DEMOLITION OR CONSTRUCTION OPERATIONS. ANY DAMAGE TO EXISTING UTILITIES ON SITE OR ADJACENT
- PROPERTY SHALL BE CONTRACTOR'S RESPONSIBILITY TO CORRECT.
- 2. COORDINATE ALL DEMOLITION AND CONSTRUCTION OPERATION WITH ARCHITECTURAL, CIVIL, AND ELECTRICAL ENGINEERING SHEETS.
- 3. COORDINATE INSTALLATION OF ELECTRICAL AND IRRIGATION CONDUIT AND SLEEVES WITH RESPECTIVE CONTRACTORS
- 4. WHEREVER CONCRETE FLATWORK ABUTS BUILDING, WALL OR COLUMNS IT SHALL HAVE AN
- EXPANSION JOINT. 5. PROVIDE TOOLED SCORE JOINTS AS SHOWN ON PLANS. SCORE JOINTS ARE AN INTEGRAL PART OF THE DESIGN AND SHALL NOT VARY FROM PATTERNS AND LOCATIONS SHOWN. CONTRACTOR SHALL
- REMOVE ANY FLATWORK THAT DOES NOT CONFORM TO DESIGN. 6. CONTRACTOR SHALL REFER TO SPECIFICATIONS FOR ADDITIONAL REQUIREMENTS.
- 7. CONTRACTOR RESPONSIBLE FOR CORRECTING ANY DAMAGE TO NEW OR EXISTING CONCRETE
- FLATWORK, ASPHALT, TURF AREAS OR ANY OTHER EXISTING ELEMENTS AS A RESULT OF CONSTRUCTION ACTIVITIES.
- 8. IN THE EVENT OF A DISCREPANCY, IMMEDIATELY NOTIFY LANDSCAPE ARCHITECT.
- 9. REFER TO PLANTING PLANS FOR 'SOFT' MATERIAL LOCATIONS.
- 10. REFER TO DETAIL DRAWINGS AND SPECIFICATIONS FOR ACTUAL CONSTRUCTION REQUIREMENTS. 11. COLORED CONCRETE SHALL BE 'COLOR GROUP: PREMIUM' @ 4# PER SACK
- 12. IN THE EVENT OF A DISCREPANCY, IMMEDIATELY NOTIFY LANDSCAPE ARCHITECT. 13. ALL RETAINING WALLS AND SEAT CAPS SHOWN ON PLANS SHALL RECEIVE ANTI-GRAFFITI COATING

MATERIALS PLAN

S

 \leq 0

> Project No: 13-172 Drawn by:

Date: Nov. 27, 2013

UTILITY STATEMENT
LOCATION OF EXISTING UNDERGROUND UTILITIES
HAVE BEEN TAKEN FROM DRAWINGS AND FIELD LOCATES SUPPLIED BY THE APPROPRIATE
UTILITY COMPANIES. UTILITY LOCATIONS SHOWN ON THIS DRAWING ARE APPROXIMATE ONLY. PRIOR TO BEGINNING ANY CONSTRUCTION, THE CONTRACTOR SHALL VERIFY THE EXACT LOCATION OF EACH UTILITY



SCALE: 1" = 20'-0"



- EVERGREEN TREES 6" WIDE EXTRUDED CONCRETE EDGING BETWEEN LAWN AND LANDSCAPE SHRUB BEDS. (SEE DETAILS)

_ DECIDUOUS SHRUBS / GROUNDCOVERS/ ORNAMENTAL GRASSES

- EVERGREEN SHRUBS / GROUNDCOVERS

DETAIL NUMBER — DETAIL CALLOUT PAGE NUMBER

IDENTIFICATION KEY - PLANT QUANTITY BASALT BOULDERS. SIZE SHALL BE EQUALLY DIVIDED INTO 3 SIZE RANGES: 2'-3', 3'-4', AND 4'-5'. USED DRAWINGS AS GUIDE TO SIZE PLACEMENT ON SITE.

TREES - NOT IN CONTRACT - PER TARGET DEVELOPMENT

		PLANT LIST - TRE	ES			
KEY	NO.	BOTANICAL - COMMON NAME	SIZE	TYPE	REMARKS	
		LARGE TREES				
QS	-	QUERCUS ROBUR X Q. ALBA - CRIMSON SPIRE OAK	3" CAL.	B&B	MATCHED	
		SMALL & FLOWERING TREES				45'H X
MS	-	MALUS 'SPRING SNOW' - SPRING SNOW CRABAPPLE (FRUITLESS)	2.5" CAL.	B&B	MATCHED	25'H X
PC	-	PRUNUS SARGENTII 'COLUMNARIS' - COLUMNAR SARGENT CHERRY	2.5" CAL.	B&B	MATCHED	30'H X
PU	-	PYRUS USSURIENSIS 'MORDAK' - PRAIRIE GEM FLOWERING PEAR	2.5" CAL.	B&B	MATCHED	25'H X

PLANT LIST - SHRUBS / GROUNDCOVERS									
KEY	TOTAL NO.	BOTANICAL - COMMON NAME	SIZE	ТҮРЕ	REMARKS				
		<u>SHRUBS</u>							
НН	-	HEMEROCALLIS X 'STELLA DE ORO' - STELLA DE ORO DWARF DAYLILLY	1 GAL.	CONT.	MATCHED				
LS	-	LAVANDULA STOECHAS 'LARKMAN HAZEL' - HAZEL SPANISH LAVENDER	2 GAL.	CONT.	MATCHED				
MC	-	MAHONIA AQUIFOLIUM 'COMPACTA' - COMPACT OREGON GRAPE	2 GAL.	CONT.	MATCHED				
PE	-	PHYSOCARPUS OPULIFOLIUS 'SEWARD' - SUMMER WINE NINEBARK	5 GAL.	CONT.	MATCHED				
SN	-	SPIRAEA NIPPONICA 'SNOWMOUND' - SNOWMOUND SPIREA	2 GAL.	CONT.	MATCHED				
		GROUNDCOVERS							
MR	-	MAHONIA REPENS - CREEPING MAHONIA	1 GAL.	CONT.	MATCHED				
		ORNAMENTAL GRASSES							
CA	_	CALAMAGROSTIS X ACUTIFLORA 'KARL FOERSTER' - FEATHER REED GRASS	2 GAL.	CONT.	MATCHED				
HS	-	HELICTOTRICHON SEMPERVIRENS - BLUE OAT GRASS	2 GAL.	CONT.	MATCHED				
PH	-	PENNISETUM ALOPECUROIDES 'HAMELN' - DWARF FOUNTAIN GRASS	2 GAL.	CONT.	MATCHED				
		TURF GRASS							
* * * * * *	_	SOD - NOT IN CONTRACT - PER TARGET DEVELOPMENT							

- CONTRACTOR TO VERIFY LOCATION OF ALL UTILITIES PRIOR TO INITIATION OF ANY DEMOLITION OR CONSTRUCTION OPERATIONS.
- ANY DAMAGE TO EXISTING UTILITIES ON SITE OR ADJACENT PROPERTY SHALL BE CONTRACTOR'S RESPONSIBILITY. 3. ALL PLANT MATERIAL SHALL CONFORM TO THE AMERICAN ASSOCIATION OF NURSERYMAN'S; AMERICAN STANDARD FOR NURSERY STOCK, ANSI Z60.1-2004. FOR ADDITIONAL PLANT REQUIREMENTS.
- ALL PLANT MATERIAL SHALL BE INSTALLED AS PER DETAILS. CONTRACTOR SHALL VERIFY ALL QUANTITIES. IN THE CASE OF A DISCREPANCY BETWEEN THE PLANT SCHEDULE AND PLAN, THE PLAN LOCATIONS SHALL DICTATE COUNT.
- 6. CONTRACTOR SHALL COORDINATE PLANTING WITH IRRIGATION CONTRACTOR.
- 7. NO SUBSTITUTIONS WILL BE ALLOWED WITHOUT THE WRITTEN CONSENT OF THE LANDSCAPE ARCHITECT.
- 8. THE TOP SOIL LAYER OF ALL TURF AREAS SHALL RECEIVE (4") OF TOPSOIL MIX (COMPOST MIXED WITH NATIVE SOIL AT A RATE OF 25% COMPOST TO NATIVE SOIL).
- 9. ALL PLANTING BEDS SHALL HAVE AN 18" DEPTH OF TOPSOIL MIX (COMPOST MIXED WITH NATIVE SOIL AT A RATE OF 25% COMPOST TO NATIVE SOIL).
- 10. ALL SHRUB BEDS SHALL RECEIVE A MIN. OF 3" DEPTH OF "TUSCAN PATHWAY". BY WITTKOPF OR EQUAL.
- 11. SHRUB BED EDGING SHALL BE 6" X 6" EXTRUDED CONCRETE. IT SHALL SEPARATE ALL TURF AREAS FROM PLANTING BED LOCATIONS. SEE PLANS FOR SPECIFIC LOCATIONS.
- 12. ALL PLANTS AND PLANT STAKES SHALL BE SET PLUMB UNLESS OTHERWISE NOTED. 13. ALL ROOT WRAPPING MATERIAL MADE OF SYNTHETICS SHALL BE REMOVED AT THE TIME OF PLANTING.
- 14. NO BARE ROOT STOCK SHALL BE USED UNLESS OTHERWISE NOTED IN CONTRACT DOCUMENTS.
- 15. CONTRACTOR IS RESPONSIBLE FOR LOCATING PROPERTY LINES AND WORKING WITHIN THE PROPERTY BOUNDARY AND PROJECT 16. IN THE EVENT OF A DISCREPANCY, NOTIFY THE LANDSCAPE ARCHITECT IMMEDIATELY.

 \leq 0

S

Drawn by:

UTILITY STATEMENT

LOCATION OF EXISTING UNDERGROUND UTILITIES

HAVE BEEN TAKEN FROM DRAWINGS AND FIELD


LOCATES SUPPLIED BY THE APPROPRIATE

UTILITY COMPANIES. UTILITY LOCATIONS SHOWN ON THIS DRAWING ARE APPROXIMATE ONLY. PRIOR TO BEGINNING ANY CONSTRUCTION, THE CONTRACTOR SHALL VERIFY THE EXACT LOCATION OF EACH UTILITY




LANDSCAPE PLANTING PLAN

Date: Nov. 27, 2013

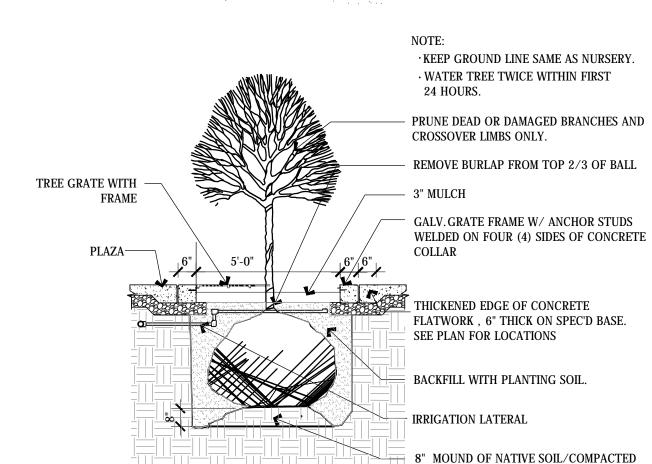


TREE WELL DETAIL

SCALE: 3/8" = 1'-0"

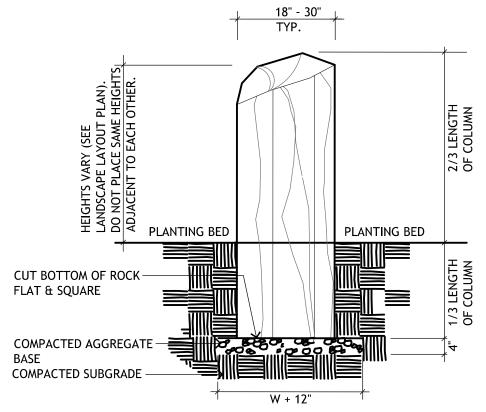


LOCATE COLUMNS PER PLAN. COLUMNS TO BE SET SO THEY ARE VERTICAL. COLUMNS PLACE AT A SLANT WILL NOT BE ACCEPTED. COMPACT AGGREGATE BASE AND SUBGRADE TO 95% RELATIVE COMPACTION.

8 | COLUMNAR BASALT DETAIL SCALE: NTS

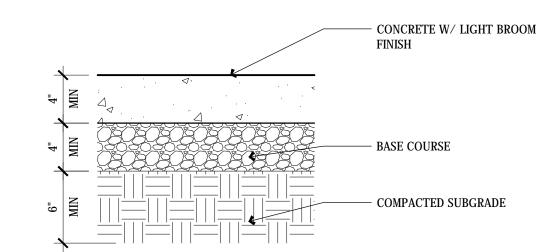


10 CONCRETE FLATWORK SCALE: 1 1/2" = 1'-0"

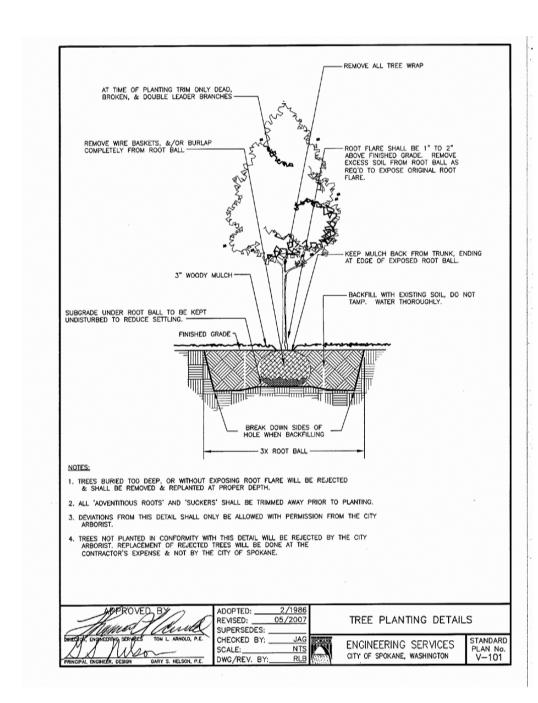

DECIDUOUS TREE PLANTING

1. NOTIFY LANDSCAPE ARCHITECT WHEN PLACING BOULDERS FOR APPROVAL OF ROCK AND PLACEMENT. LOCAL GRANITE BOULDER 3'-4' DIA. DO 2. PLACE BOULDERS PRIOR TO INSTALLATION OF NOT SCAR OR DAMAGE LOCATE AS PER IRRIGATION SYSTEM. PLANS. WHEN PLACING BOULDERS, BURY 1/4 TO 1/3 OF BOULDER BELOW PLANTING BED GRADE. - SAW BOTTOM SIDE OF BOULDER FLAT & PLACE WHERE SHOWN ON PLAZA. COMPACT SUBGRADE UNDER BOULDER AS REQUIRED. CONCRETE FLATWORK/PLAZA

BOULDER IN FLATWORK

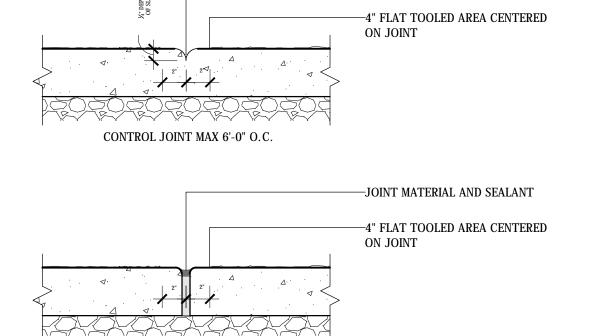


TOOL JOINT WITH GROOVER/


JOINTER

EXPANSION AND CONTROL JOINT SCALE: NTS

EXPANSION JOINT MAX 30'-0" O.C.

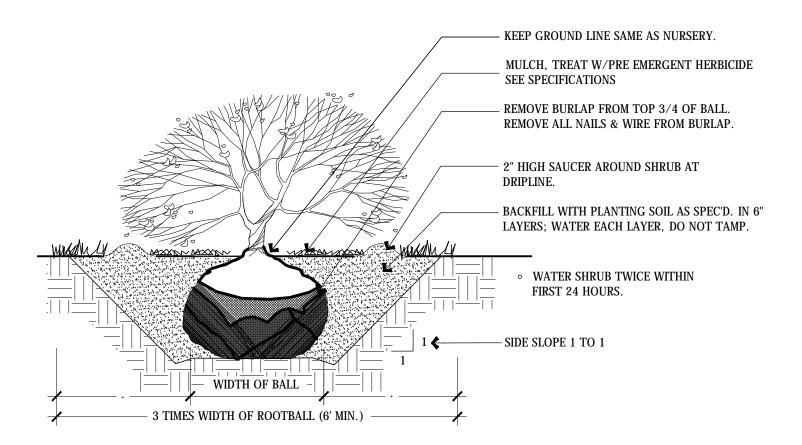


3 SHRUB PLANTING DETAIL

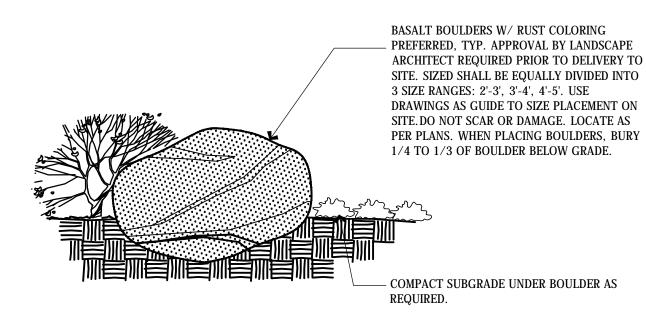

6 BOULDER PLACEMENT DETAIL SCALE: NTS

NOT USED SCALE: NTS

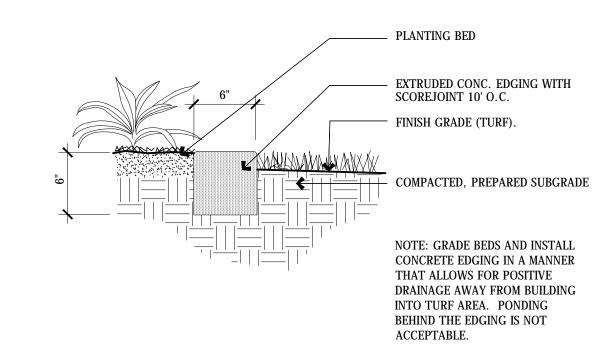

EXTRUDED CONCRETE EDGING

Construction Notes

LANDSCAPE:

A. TOPSOIL AND FINE GRADING REQUIREMENTS:

1) Grading contractor must stockpile existing topsoil clean and debris free suitable for reuse.

2) Contractor must submit representative samples of the reserved topsoil, and soil in which the landscaping is to be installed, to a certified soil and plant laboratory for analysis. Take a minimum of two samples each from landscape areas adjacent to all four sides of building(s); The soil and plant laboratory report must provide recommendations for fertilizer and soil amendments that may be required to ensure healthy growth of turf and plant materials to be installed in the respective areas from which the soil samples were taken. Provide two copies of the report to the project landscape architect.

3) Grading contractor must spread minimum 6-inch topsoil layer to finish site grade, and 12-inch topsoil layer in sidewalk planters. Topsoil

a) Meet requirements of ASTM D5268;

b) Contain no more than 5% deleterious material by weight. c) Contain not less than 80% material by weight that will pass a #10 sieve; and

d) Be free of clods, rocks, or debris greater than 1-inch diameter.

4) Landscape contractor must perform fine grading and soil amendments to the topsoil and/or approved import soil for all lawn and landscape areas as recommended by the soil analysis. Fine grading must:

a) Be within one-tenth of a foot of grades shown on the Site Construction Documents Grading Plan; b) Transition smoothly between differing gradients.

5) If suitable topsoil is not available on site, imported topsoil shall meet specifications and shall be amended to meet recommendations from the certified soil and plant lab analysis.

6) Grades behind curbs for areas to receive mulch must be held 3 inches below top of curb and 2 inches below top of curb for sod. In well-draining soils island, and planter grades must be slightly concave sloping downward at not less than 5% and no greater than 20% from perimeter toward the middle. In poorly draining soils, island and planter grades must be slightly mounded sloping downward at not less than 5%, and no greater than 20%, from middle toward the perimeter.

B. PLANTING PITS:

1) Width of all planting pits must be two times the diameter of the root ball, or container of the plant being installed. Depth of all planting pits must be from the bottom of the root ball to the root flare, or container of the plant being installed, and must maintain a firm setting bed in the bottom of the planting pit to avoid settling;

2) Soil used in planting pits must be free of all construction materials, concrete, and rocks in excess of 1 inch diameter, and consist of 50% of the soil removed and 50% suitable amended soil or topsoil;

3) Place soil firmly in the planting pit around the root ball creating a shallow saucer of approximately 2 inches deep to hold water around

4) Install each plant with the crown of the root ball set at the same grade at which it was grown. Top of finish grade must be at trunk

5) Water plants thoroughly upon installation. Backfill any settling of soil around root ball to re-establish initial grade and saucer.

C. PLANT MATERIALS:

1) Plant material must comply with the latest edition of the American Standard for Nursery Stock,

a) SITE LANDSCAPING REQUIREMENTS:

(i) Field collected plants must not be used.

(ii) Thorn or fruit bearing trees or shrubs must not be used immediately adjacent to pedestrian areas including parking lot islands.

(iii) Double stake trees as shown on plans to ensure an initial plumb position. Contractor shall install plastic chain-lock tree ties, no wire ties shall be used. Wood staking must not contain chromated copper arsenate (CCA).

(iv) Do not wrap tree trunks. b) PERIMETER LANDSCAPING:

(i) Install shade trees to define site and adhere to local screening and landscape requirements. (ii) Ensure that sight lines to building signs and pylon signs are not hindered by landscape materials at mature growth. Maintain visibility of building and site signs from all street and drive intersections. (iii) See planting plan for tree caliper.

(vi) Planting beds mulch must be clean, non-dyed, toxic free, bark fines, and free of disease and weed materials. Install to a uniform minimum 3-inch depth covering the root ball areas of all trees and shrubs. Pine straw, crushed rock, and pea gravel or similar materials are not acceptable as ground cover. Avoid placing mulch over utility boxes, sewer clean-outs, in-ground lights, etc.

LANDSCAPE DETAILS


 \sim

 \blacksquare

S

Z $\mathbf{\Omega}$

Drawn by:

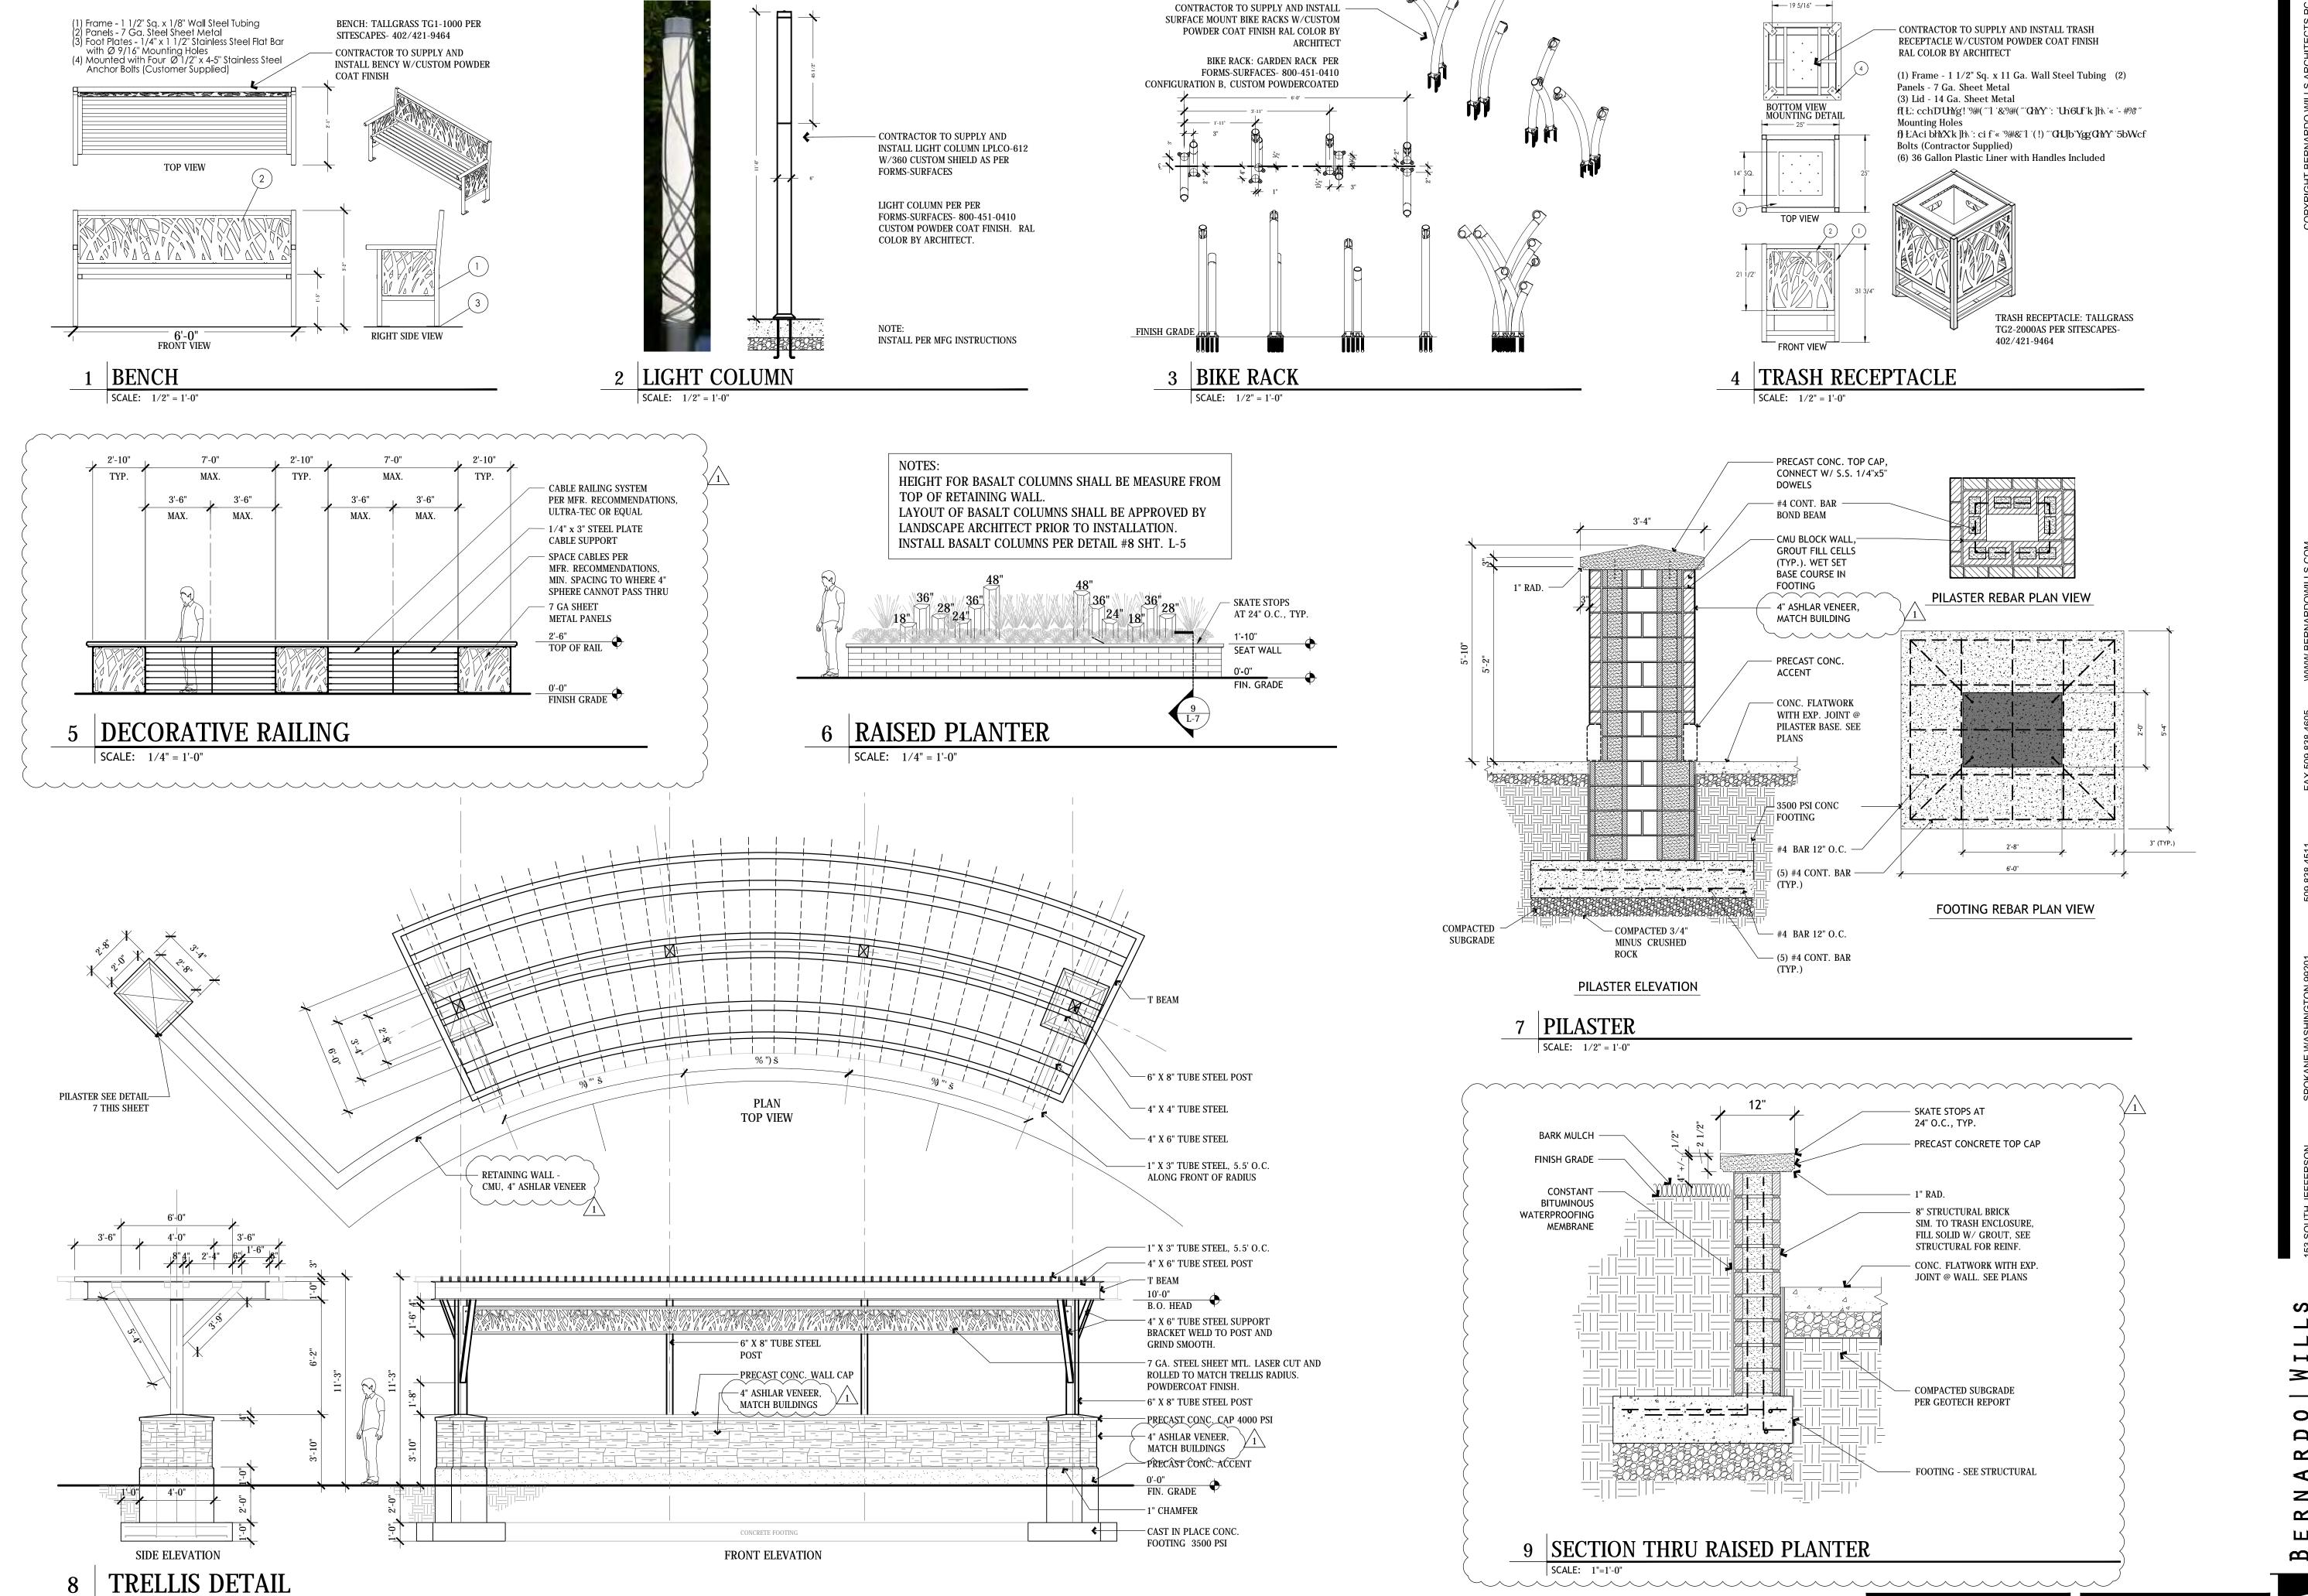

SCALE: 1/4" = 1'-0"

UNDERGROUND SERVICE ALERT Drawn by: ONE-CALL NUMBER CALL TWO BUSINESS DAYS BEFORE YOU DIG

UTILITY STATEMENT
LOCATION OF EXISTING UNDERGROUND
UTILITIES HAVE BEEN TAKEN FROM

CONTRACTOR SHALL VERIFY THE EXACT LOCATION OF EACH UTILITY.


DRAWINGS AND FIELD LOCATES SUPPLIED Y THE APPROPRIATE UTILITY COMPANIES. UTILITY LOCATIONS SHOWN ON THIS DRAWING ARE APPROXIMATE ONLY. PRIOR TO BEGINNING ANY CONSTRUCTION, THE


Project No: 13-172 Date: Nov. 27, 2013

LANDSCAPE SITE DETAILS


 \sim

(MARK)

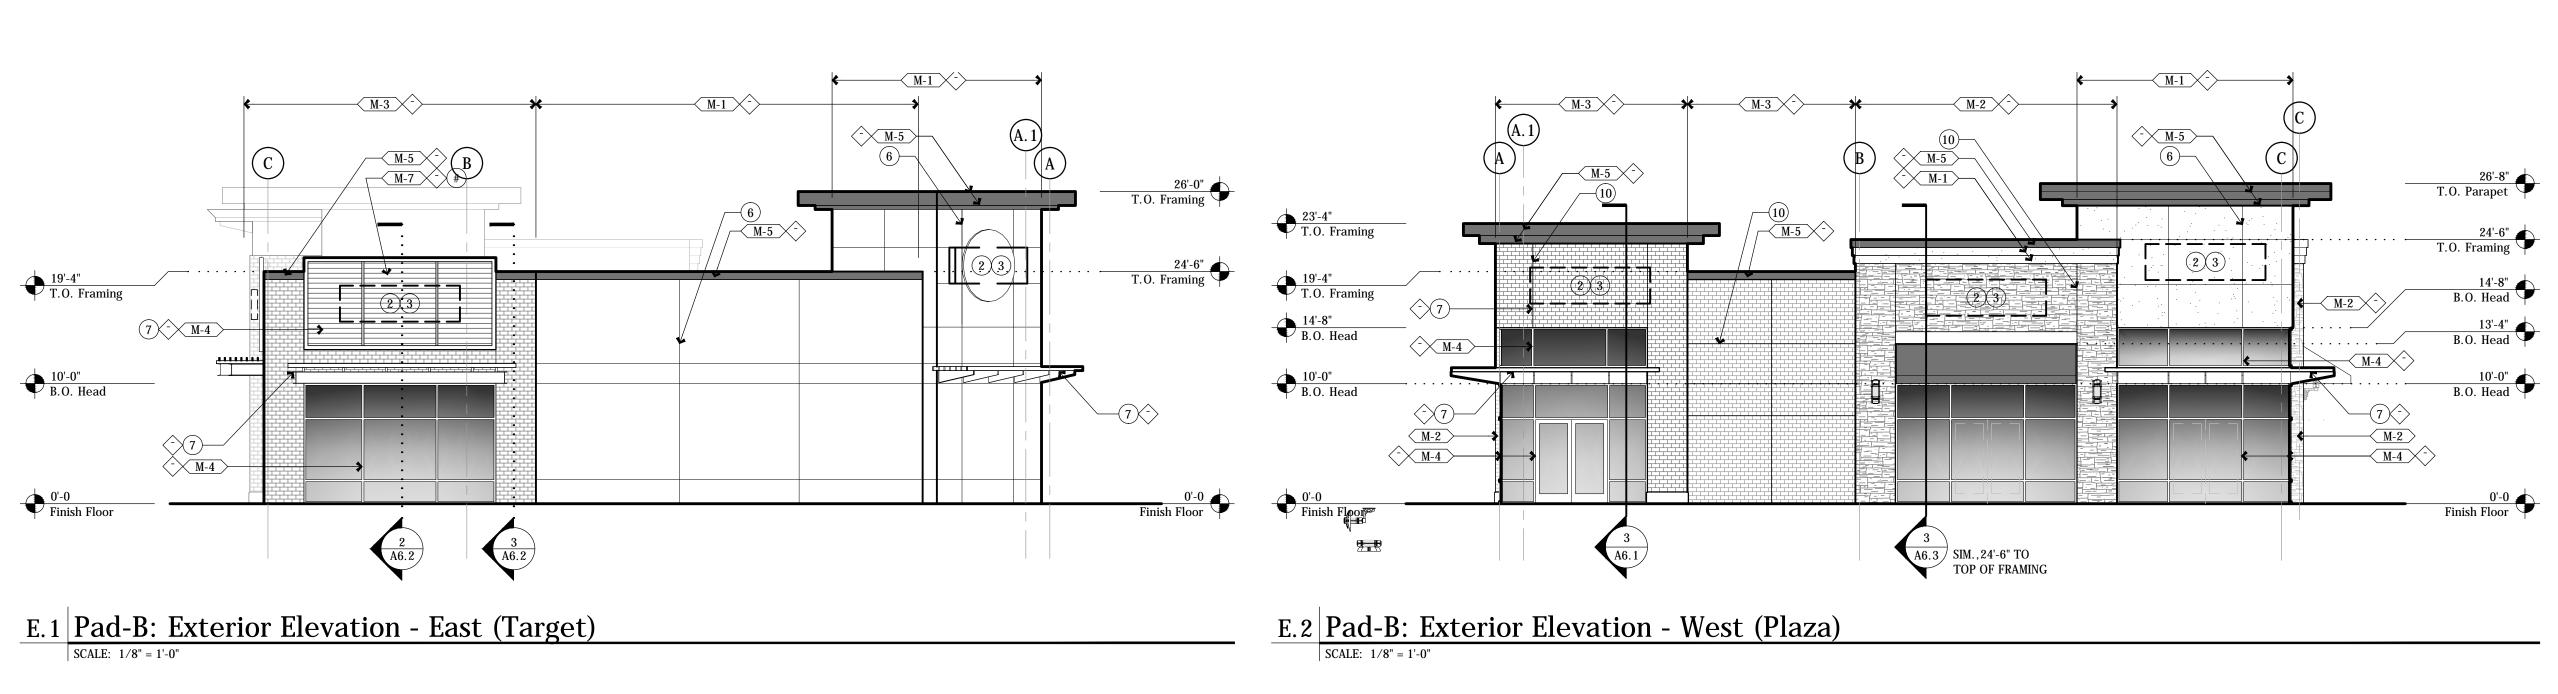

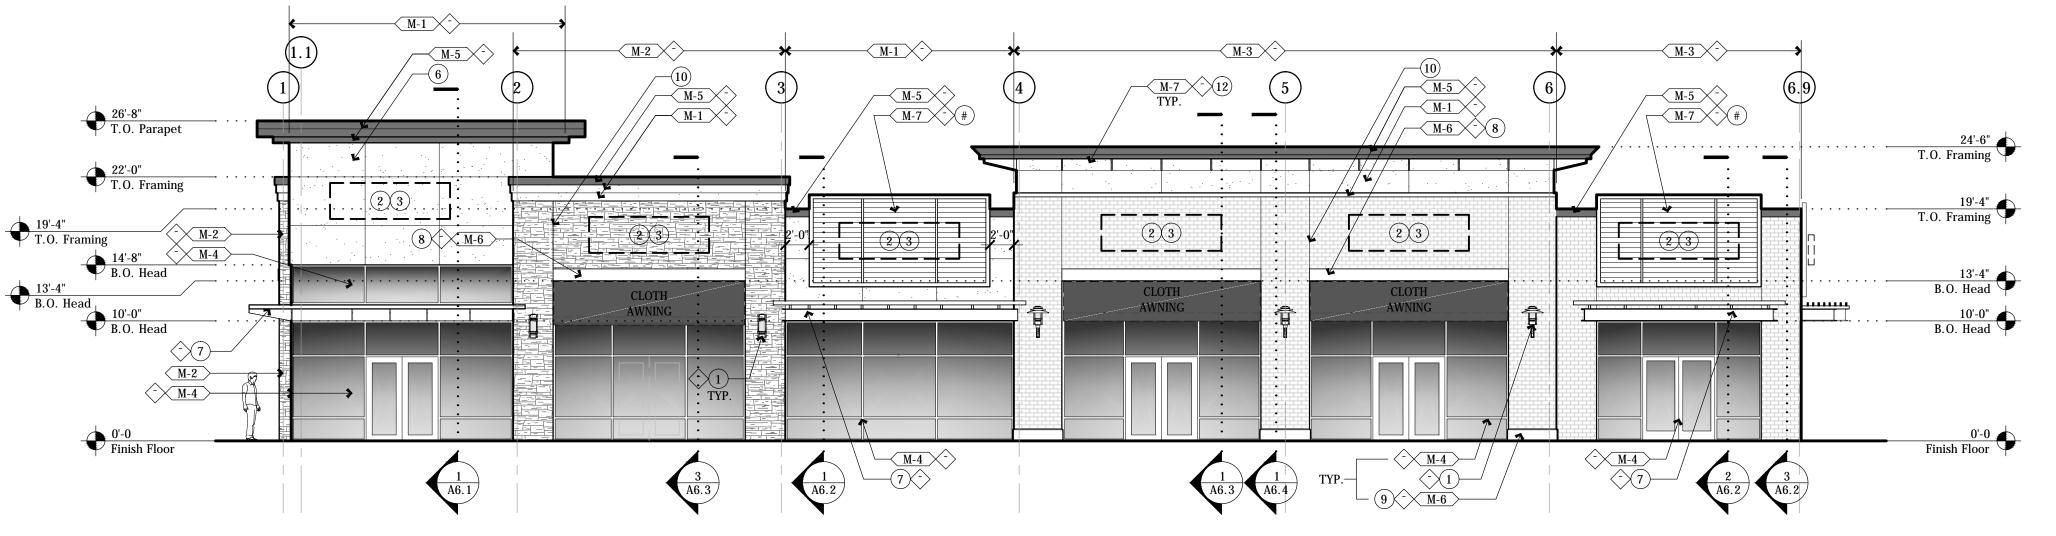

E.3 Pad-B: Exterior Elevation - South (Front)

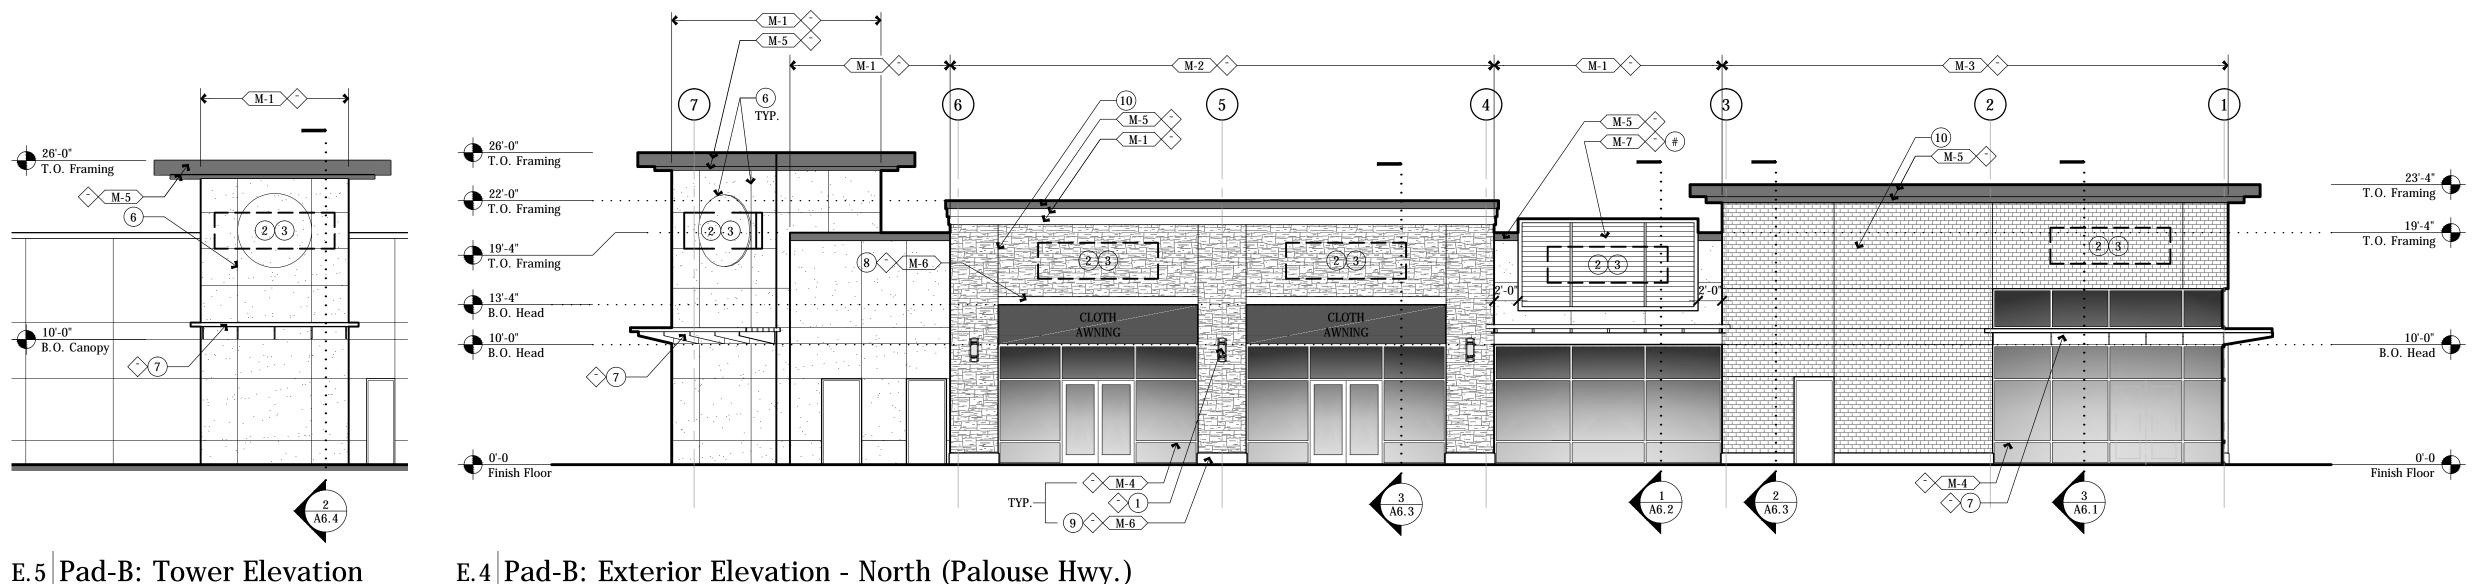

G. BRICK 02

F. BRICK 01

H. CMU-01 (SMOOTH FACE)

I. CMU-02 (ASHLAR) J. CLOTH AWNINGS: TBD

K. PREFINISHED METAL COLOR 01

ELEVATION NOTES:

4. OPEN STEEL CANOPY. SEE STRUCTURAL.

LETTERING FONT, STROKE & COLOR

6. 3/4" E.I.F.S. 'V' GROOVE

7. 1-INCH EIFS ACCENT BAND

8. PRE-CAST CONC. ACCENT

9. PRE-CAST CONC. SILL

10. 1/2" BRICK REVEAL

STRUCTURAL

M-3 4x4x8 BRICK VENEER

M-6 CONCRETE

M-7 FABRICATED STEEL

M-5 PREFINISHED METAL COPING

12. OUTRIGGER

2. TENANT SIGNAGE (N.I.C., UNDER SEPARATE PERMIT). FURNISH

3. SIGN MOUNTING BRACKETS, SEE DETAIL __/AX.X. CENTER ON STOREFRONT DOOR

5. 6" WHITE VINYL ADDRESS LETTERING CENTERED ABOVE DOOR

11. OPEN STEEL ARCHITECTURAL/SIGNAGE ELEMENT, SEE

EXTERIOR MATERIALS

M-1 EXTERIOR INSULATION & FINISH SYSTEM

M-2 MANUFACTURED ASHLAR STONE VENEER

M-4 PREFINISHED ALUM STOREFRONT SYSTEM

B. SYNTHETIC STUCCO SYSTEM COLOR 02

C. SYNTHETIC STUCCO SYSTEM COLOR 03

D. SYNTHETIC STUCCO SYSTEM COLOR 04

E. SYNTHETIC STUCCO SYSTEM COLOR 05

EXTERIOR COLORS & FINISHES MARK

& INSTALL EXTERIOR RATED J-BOX, & WIRING IN CONCEALED

1. LIGHT FIXTURE, SEE ELECTRICAL

L. PREFINISHED METAL COLOR 02 M. CONCRETE

E.4 Pad-B: Exterior Elevation - North (Palouse Hwy.) SCALE: 1/8" = 1'-0"

SCALE: 1/8" = 1'-0"

