


CONSTRUCTION IMPROVEMENTS

LATAH GLEN RESIDENTIAL COMMUNITY

SECTION 36, TOWNSHIP 25 NORTH, RANGE 42 EAST, W.M., CITY OF SPOKANE, SPOKANE COUNTY, WASHINGTON

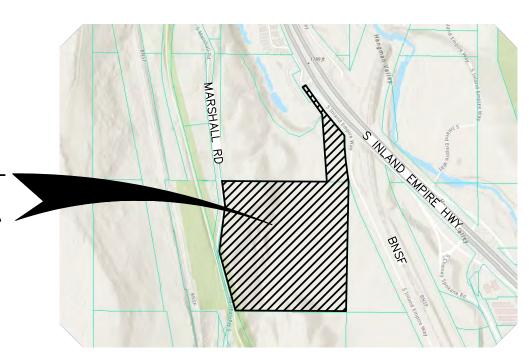

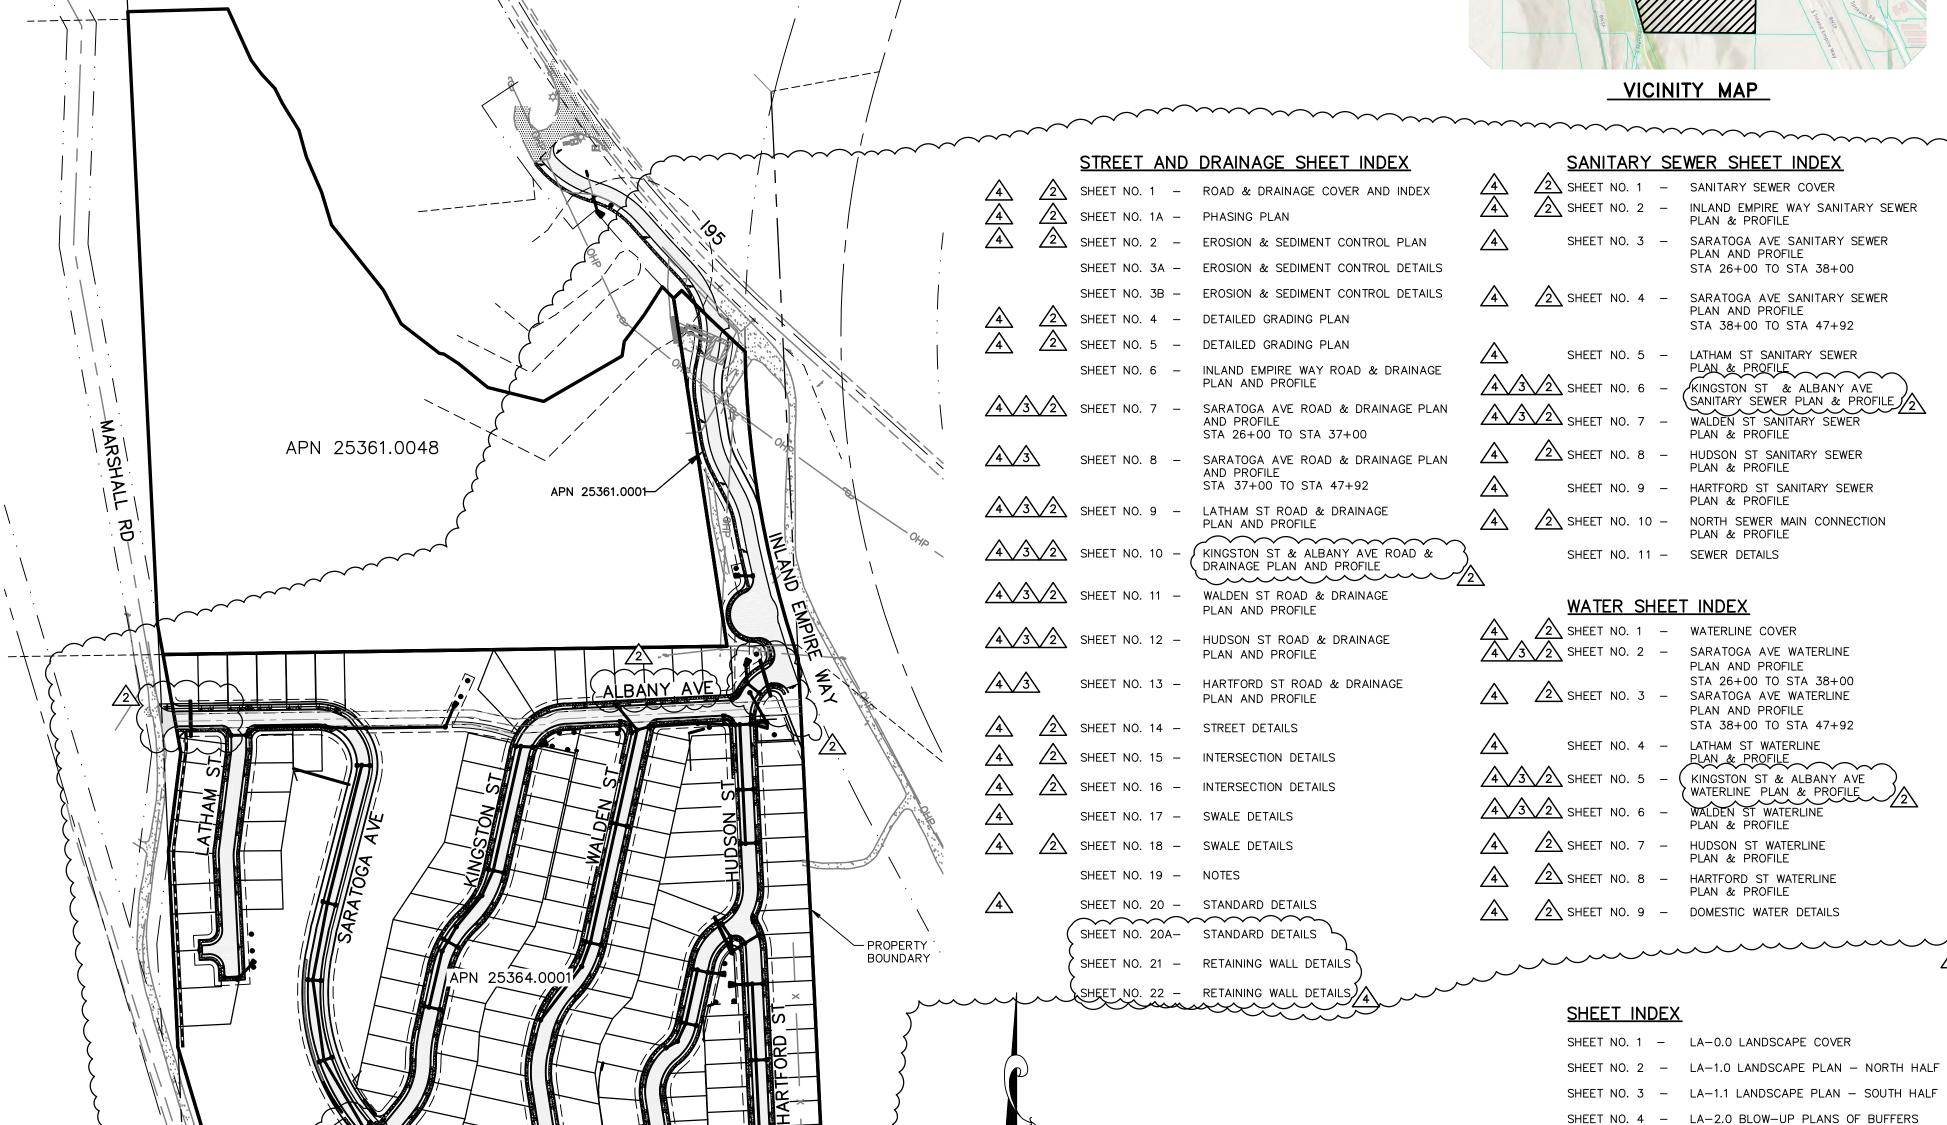


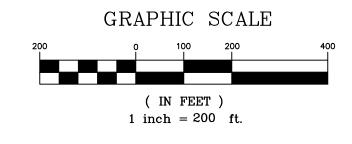

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SHEET NO. 5 - LA-2.1 BLOW-UP PLANS OF SHRUB AREAS

SHEET NO. 6 - LA-3.0 STANDARD DETAIL AND NOTES

SHEET NO. 7 - CITY OF SPOKANE DETAILS AND NOTES

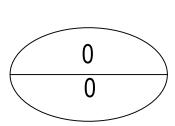				REVISIONS	N	NAVD88	= EST	ABLISHE	D f	FROM	GPS
					NAVD88	ELEV.	:1843.87	100'	0'	100'	200'
,	5/14/25	LC	19-342	GENERAL REVISION /3	СВМ ИС) •					
	10/10/24	LC	19-342	GENERAL REVISION (2)	J 02111 110	•			[IN FE	
				ASI #1 CONTRACTOR QUESTIONS /1] N/	AVD88	DATUM	3CA		IIN I L	'
	DATE	BY	PROJECT	DESCRIPTION							

_	RK LOCATION: 5/8" REBAR WITH PLASTIC CAP AT THE SOUTHEAST PROPERTY CORNER			
			BY	DATES
SCALE	HORIZONTAL SCALE (22 x 34)	DRAWN:	LMC	3/3/2023
SUALE	VERTICAL SCALE (22 x 34)	APPROVED:	JDS	01/19/2024
				•

CITY OF SPOKANE, WASHINGTON
DEPARTMENT OF ENGINEERING SERVICES 808
WEST SPOKANE FALLS BLVD. SPOKANE,
WASHINGTON 99201-3343 (509) 625-6700

PROJECT NAME: LATAH GLEN RESIDENTIAL COMMUNITY

SEGMENT LIMITS: TYPE OF IMPRO

SEGMENT LIMITS:	TYPE OF IMPROVEMENT:	STREET	
COVER & INDEX	PROJECT NO.	PLAN NO.	
APN 25361.0001 & 25364.0001	2023517 2023518		
PROJECT LIMITS: LATAH GLEN RESIDENTIAL	2023519 2023520	36-25N-42E	
CALL BEFORE YOU	DIG 1-800-424-5555	5	


GENERAL NOTES


- 1. THE CONTRACTOR SHALL BE RESPONSIBLE FOR OBTAINING ALL NECESSARY PERMITS FROM ALL APPLICABLE AGENCIES. THE CONTRACTOR SHALL NOTIFY THE CITY OF SPOKANE PUBLIC WORKS INSPECTOR AT LEAST 48 HOURS PRIOR TO THE START OF ANY EARTH DISTURBING ACTIVITY, OR CONSTRUCTION ON ANY AND ALL SEWER AND WATER IMPROVEMENTS.
- 2. THE CONTRACTOR SHALL COORDINATE AND COOPERATE WITH THE CITY OF SPOKANE AND ALL UTILITY COMPANIES INVOLVED WITH REGARD TO RELOCATIONS OR ADJUSTMENTS OF EXISTING UTILITIES DURING CONSTRUCTION AND TO ASSURE THAT THE WORK IS ACCOMPLISHED IN A TIMELY FASHION AND WITH A MINIMUM DISRUPTION OF SERVICE. THE CONTRACTOR SHALL BE RESPONSIBLE FOR CONTACTING ALL PARTIES AFFECTED BY ANY DISRUPTION OF ANY UTILITY SERVICE.
- 3. THE CONTRACTOR SHALL HAVE ONE (1) SIGNED COPY OF THE APPROVED PLANS, ONE (1) COPY OF THE APPROPRIATE STANDARDS AND SPECIFICATIONS, AND A COPY OF ANY PERMITS AND EXTENSION AGREEMENTS NEEDED FOR THE JOB ON—SITE AT ALL TIMES.
- 4. IF, DURING THE CONSTRUCTION PROCESS, CONDITIONS ARE ENCOUNTERED BY THE CONTRACTOR, HIS SUBCONTRACTORS, OR OTHER AFFECTED PARTIES, WHICH COULD INDICATE A SITUATION THAT IS NOT IDENTIFIED IN THE PLANS OR SPECIFICATIONS, THE CONTRACTOR SHALL CONTACT THE ENGINEER IMMEDIATELY.
- 5. THE CONTRACTOR SHALL SUBMIT A TRAFFIC CONTROL PLAN IN ACCORDANCE WITH M.U.T.C.D. TO THE APPROPRIATE RIGHT—OF—WAY AUTHORITY (CITY, COUNTY, OR STATE) FOR APPROVAL PRIOR TO ANY CONSTRUCTION ACTIVITIES WITHIN, OR AFFECTING, THE RIGHT—OF—WAY. THE CONTRACTOR SHALL BE RESPONSIBLE FOR PROVIDING ANY AND ALL TRAFFIC CONTROL DEVICES AS MAY BE REQUIRED BY THE CONSTRUCTION ACTIVITIES.
- 6. THE CONTRACTOR SHALL BE RESPONSIBLE FOR KEEPING ROADWAYS FREE AND CLEAR OF ALL CONSTRUCTION DEBRIS AND DIRT TRACKED FROM THE SITE.
- 7. THE CONTRACTOR SHALL BE RESPONSIBLE FOR RECORDING AS—BUILT INFORMATION ON A SET OF RECORD DRAWINGS KEPT AT THE CONSTRUCTION SITE, AND MADE AVAILABLE TO THE CITY OF SPOKANE PUBLIC WORKS INSPECTOR AT ALL TIMES.
- 8. ALL STRUCTURAL EROSION CONTROL MEASURES SHALL BE INSTALLED, AT THE LIMITS OF CONSTRUCTION, PRIOR TO ANY OTHER GROUND—DISTURBING ACTIVITY. ALL EROSION CONTROL MEASURES SHALL BE MAINTAINED IN GOOD REPAIR BY THE CONTRACTOR, UNTIL SUCH TIME AS THE ENTIRE DISTURBED AREAS ARE STABILIZED WITH HARD SURFACE OR LANDSCAPING.
- 9. ALL WORK WITHIN THE PUBLIC RIGHT-OF-WAY IS SUBJECT TO THE JURISDICTION OF SPOKANE COUNTY.
- 10. ALL OPERATIONS CONDUCTED ON THE PREMISES, INCLUDING THE WARMING UP, REPAIR, ARRIVAL, DEPARTURE OR RUNNING OF TRUCKS, EARTHMOVING EQUIPMENT, CONSTRUCTION EQUIPMENT AND ANY OTHER ASSOCIATED EQUIPMENT SHALL GENERALLY BE LIMITED TO THE PERIOD BETWEEN 7:00 A.M. AND 10:00 P.M. WEEKDAYS, 9:00AM AND 10:00PM WEEKENDS, UNLESS OTHERWISE APPROVED BY THE COUNTY.
- 11. NO REVISIONS SHALL BE MADE TO THESE PLANS WITHOUT THE APPROVAL OF THE CITY ENGINEER AND NOTIFICATION OF THE ENGINEER OF RECORD.
- 12. STATIONING AND OFFSET IS BASED ON STATIONING FOR THE REFERENCED STREET ALIGNMENT.
- 13. EXISTING UTILITIES CONFLICTING WITH PROPOSED IMPROVEMENTS SHALL BE RELOCATED AS NEED PRIOR TO CONSTRUCTION. COORDINATE WITH APPLICABLE UTILITY COMPANY.
- 14. RESTRAINTS SHALL BE INSTALLED ON ALL PRESSURE PIPELINES IN ACCORDANCE WITH CITY OF SPOKANE STANDARDS. REFER TO RESTRAINED JOINT TABLE ON THESE PLANS.
- 15. INSTALL TREE PROTECTION AT THE WEST EDGE OF THIS PROPERTY TO PROTECT ALL EXISTING TREES IN THE PUBLIC RIGHT OF WAY ALONG MARSHALL ROAD PER CITY OF SPOKANE TREE PROTECTION SPECIFICATIONS AND DETAIL PRIOR TO ANY MORE EXCAVATION WORK FOR THE WALL ALONG THIS AREA. FENCING TO REMAIN INTACT THROUGHOUT ALL PHASES OF DEMOLITION AND CONSTRUCTION.
- 16. THE GENERAL CONTRACTOR IS RESPONSIBLE TO ENSURE THE ABOVE REQUIREMENTS ARE MET. THE CITY MAY SEEK RESTITUTION AT TREBLE THE APPRAISED TREE VALUE FOR DAMAGES TO ANY TREES IN THE PUBLIC RIGHT OF WAY DUE TO CONSTRUCTION ACTIVITIES/EQUIPMENT AND FOR ANY RIGHT OF WAY TREES THAT ARE REMOVED WITHOUT UF PERMISSION STREET BROPERTORM DRAINAGE NOTES
- 1. REFER TO CONSTRUCTION NOTES AND DETAILS SHOWN ON DETAIL SHEET.
- 2. REFER TO LANDSCAPE DOCUMENTS FOR ADDITIONAL INFORMATION REGARDING PLANTINGS, IRRIGATION SYSTEM, SITE FURNITURE, LANDSCAPE BERMS, STEPS, AND LANDSCAPE WALLS.
- 3. REFER TO ARCHITECTURAL DOCUMENTS FOR ADDITIONAL INFORMATION REGARDING ANY STEPS IN FINISH FLOOR, BASEMENT ELEVATION, AND EXTERIOR DOOR LOCATIONS. COORDINATE ARCHITECTURAL ELEVATIONS WITH SITE GRADING.
- 4. MAINTAIN AT LEAST 3 FEET OF COVER OVER STORM DRAIN PIPES, UNLESS DUCTILE IRON. FOR DUCTILE IRON MAINTAIN AT LEAST 1 FOOT OF COVER.
- 5. SPOT ELEVATIONS REPRESENT FINISH SURFACE GRADES.
- 6. LOCATIONS OF EXISTING UTILITIES SHOWN ON THE PLANS ARE APPROXIMATE. THE CONTRACTOR SHALL BE RESPONSIBLE FOR LOCATING ALL UNDERGROUND AND OVERHEAD UTILITIES AND STRUCTURES. CONTRACTOR TO PERFORM NECESSARY FIELD VERIFICATION, INCLUDING SUBSURFACE EXPLORATION, FOR ALL EXISTING CONDITIONS TO BE INCLUDED IN CONTRACTOR BID. ANY CONFLICTING UTILITIES SHALL BE RELOCATED PRIOR TO CONSTRUCTION OF PROPOSED IMPROVEMENTS.
- 7. ADJUST ALL EXISTING UTILITY COVERS TO FINISHED GRADE AS NECESSARY.
- 8. ALL MATERIALS, WORKMANSHIP, TESTING AND CONSTRUCTION SHALL BE IN CONFORMANCE WITH THE WASHINGTON STATE STANDARD SPECIFICATIONS FOR ROAD, BRIDGE, AND MUNICIPAL CONSTRUCTION, THE CITY OF SPOKANE STANDARDS, AND THE CITY OF SPOKANE SPECIAL PROVISIONS FOR PRIVATE CONTRACTS.
- 9. ALL APPROVALS AND PERMITS REQUIRED BY THE CITY OF SPOKANE SHALL BE OBTAINED BY THE CONTRACTOR PRIOR TO THE START OF CONSTRUCTION. AN OBSTRUCTION PERMIT IS REQUIRED FOR ALL WORK WITHIN THE CITY RIGHT—OF—WAY. IF APPLICABLE, A TRAFFIC CONTROL PLAN, (INCLUDING PEDESTRIAN TRAFFIC CONTROL FOR SIDEWALK CLOSURES) WILL BE REQUIRED WITH THE OBSTRUCTION PERMIT APPLICATION.
- 10. THE CONTRACTOR SHALL PLACE MARKING TAPE IN THE EXCAVATION TRENCH AT MID-DEPTH LOCATION FOR ALL UNDERGROUND SIDE SERVICE INSTALLATIONS FOR THE PURPOSE OF ALERTING ANY FUTURE EXCAVATION IN THE SPECIFIC AREA.
- 11. NO REVISIONS SHALL BE MADE TO THE PLANS WITHOUT APPROVAL FROM THE CITY OF SPOKANE AND THE DESIGN ENGINEER OF RECORD.
- 12. STORMWATER FACILITIES, INCLUDING DRYWELLS, CB'S, PIPES, AND INFILTRATION GALLERIES, MUST BE CONSTRUCTED UNDER SUPERVISION OF THE WASTEWATER MANAGEMENT DIVISION. STORMWATER TREATMENT FACILITIES (208 SWALES) SHALL BE INSPECTED PRIOR TO PLACEMENT OF TOPSOIL, PLANTINGS, OR GRASS. THE CONTRACTOR SHALL CONTACT THE WASTEWATER MAINTENANCE DIVISION OFFICE AT (509) 625-7905 OR (509) 625-7912 IN ORDER TO ARRANGE A MUTUALLY AGREEABLE INSPECTION SCHEDULE.
- 13. ALL SIDEWALKS, CURBS, AND DRIVEWAY APPROACHES ADJACENT TO THE PROPERTY WILL BE REVIEWED AT THE END OF THE PROJECT WHEN A CERTIFICATE OF OCCUPANCY IS REQUESTED. IF ANY ARE FOUND TO BE BROKEN, HEAVED, SUNKEN, OR MISSING, THEY MUST BE REPAIRED/REPLACED WHETHER THE DAMAGE WAS EXISTING OR CAUSED BY CONSTRUCTION. IF YOU WOULD LIKE A SIDEWALK INSPECTION PRIOR TO REQUESTING OCCUPANCY, PLEASE CONTACT THE CITY OF SPOKANE AT (509) 625-6300 TO ARRANGE A SITE VISIT.
- 14. PROPERTY LINES OF SUBJECT PROPERTY HAVE BEEN VERIFIED BY A BOUNDARY SURVEY
- 15. CONTRACTOR TO REMOVE AND LEGALLY DISPOSE ALL EXISTING TREES THAT CONFLICT WITH PROPOSED IMPROVEMENTS.
- 16. PROVIDE POSITIVE DRAINAGE AWAY FROM BUILDINGS AND STRUCTURES.
- 17. CONTRACTOR IS RESPONSIBLE FOR SIGN REMOVAL, MAINTENANCE, AND NEW SIGN INSTALLATION DURING CONSTRUCTION.
- 18. REFER TO TABLE 6-1 IN THE SPOKANE REGIONAL STORMWATER MANUAL FOR TREATMENT SOIL CRITERIA.
- 19. ALL PAVEMENT CUTS MUST CONFORM TO THE SPOKANE REGIONAL PAVEMENT CUT POLICY.
- 20. SEE CITY OF SPOKANE STANDARD PLAN NO. A-5 ON SHEET 20 FOR CITY STANDARDS ON WATER/SEWER CROSSINGS
- 21. CITY OF SPOKANE HYDRANT PERMIT PROGRAM REQUIRES AN RPBA AND FLOW METER ASSEMBLY FOR ALL FIRE HYDRANT WATER USAGE IF NEEDED FOR CONSTRUCTION PHASE OF THE PROJECT (E.G. DUST CONTROL, ETC.). THIS HYDRANT PROGRAM REQUIRES A PERMIT FEE, CONSUMPTION BILLING, AND DEPOSIT FOR THE RPBA & METER ASSEMBLY. PLEASE CALL 311 OR CITY WATER DEPT. AT 509-625-7800 FOR MORE INFO.

STREET AND DRAINAGE IMPROVEMENTS

LATAH GLEN RESIDENTIAL COMMUNITY

SECTION 36, TOWNSHIP 25 NORTH, RANGE 42 EAST, W.M., CITY OF SPOKANE, SPOKANE COUNTY, WASHINGTON

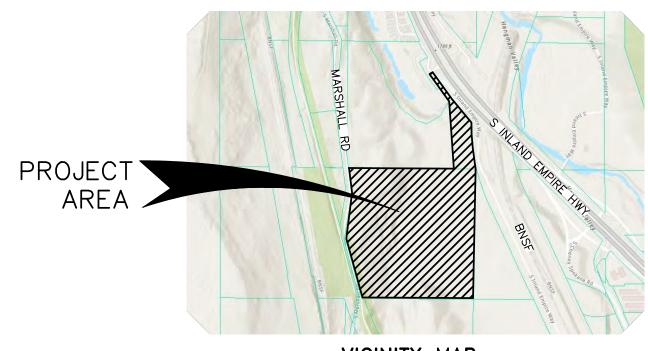

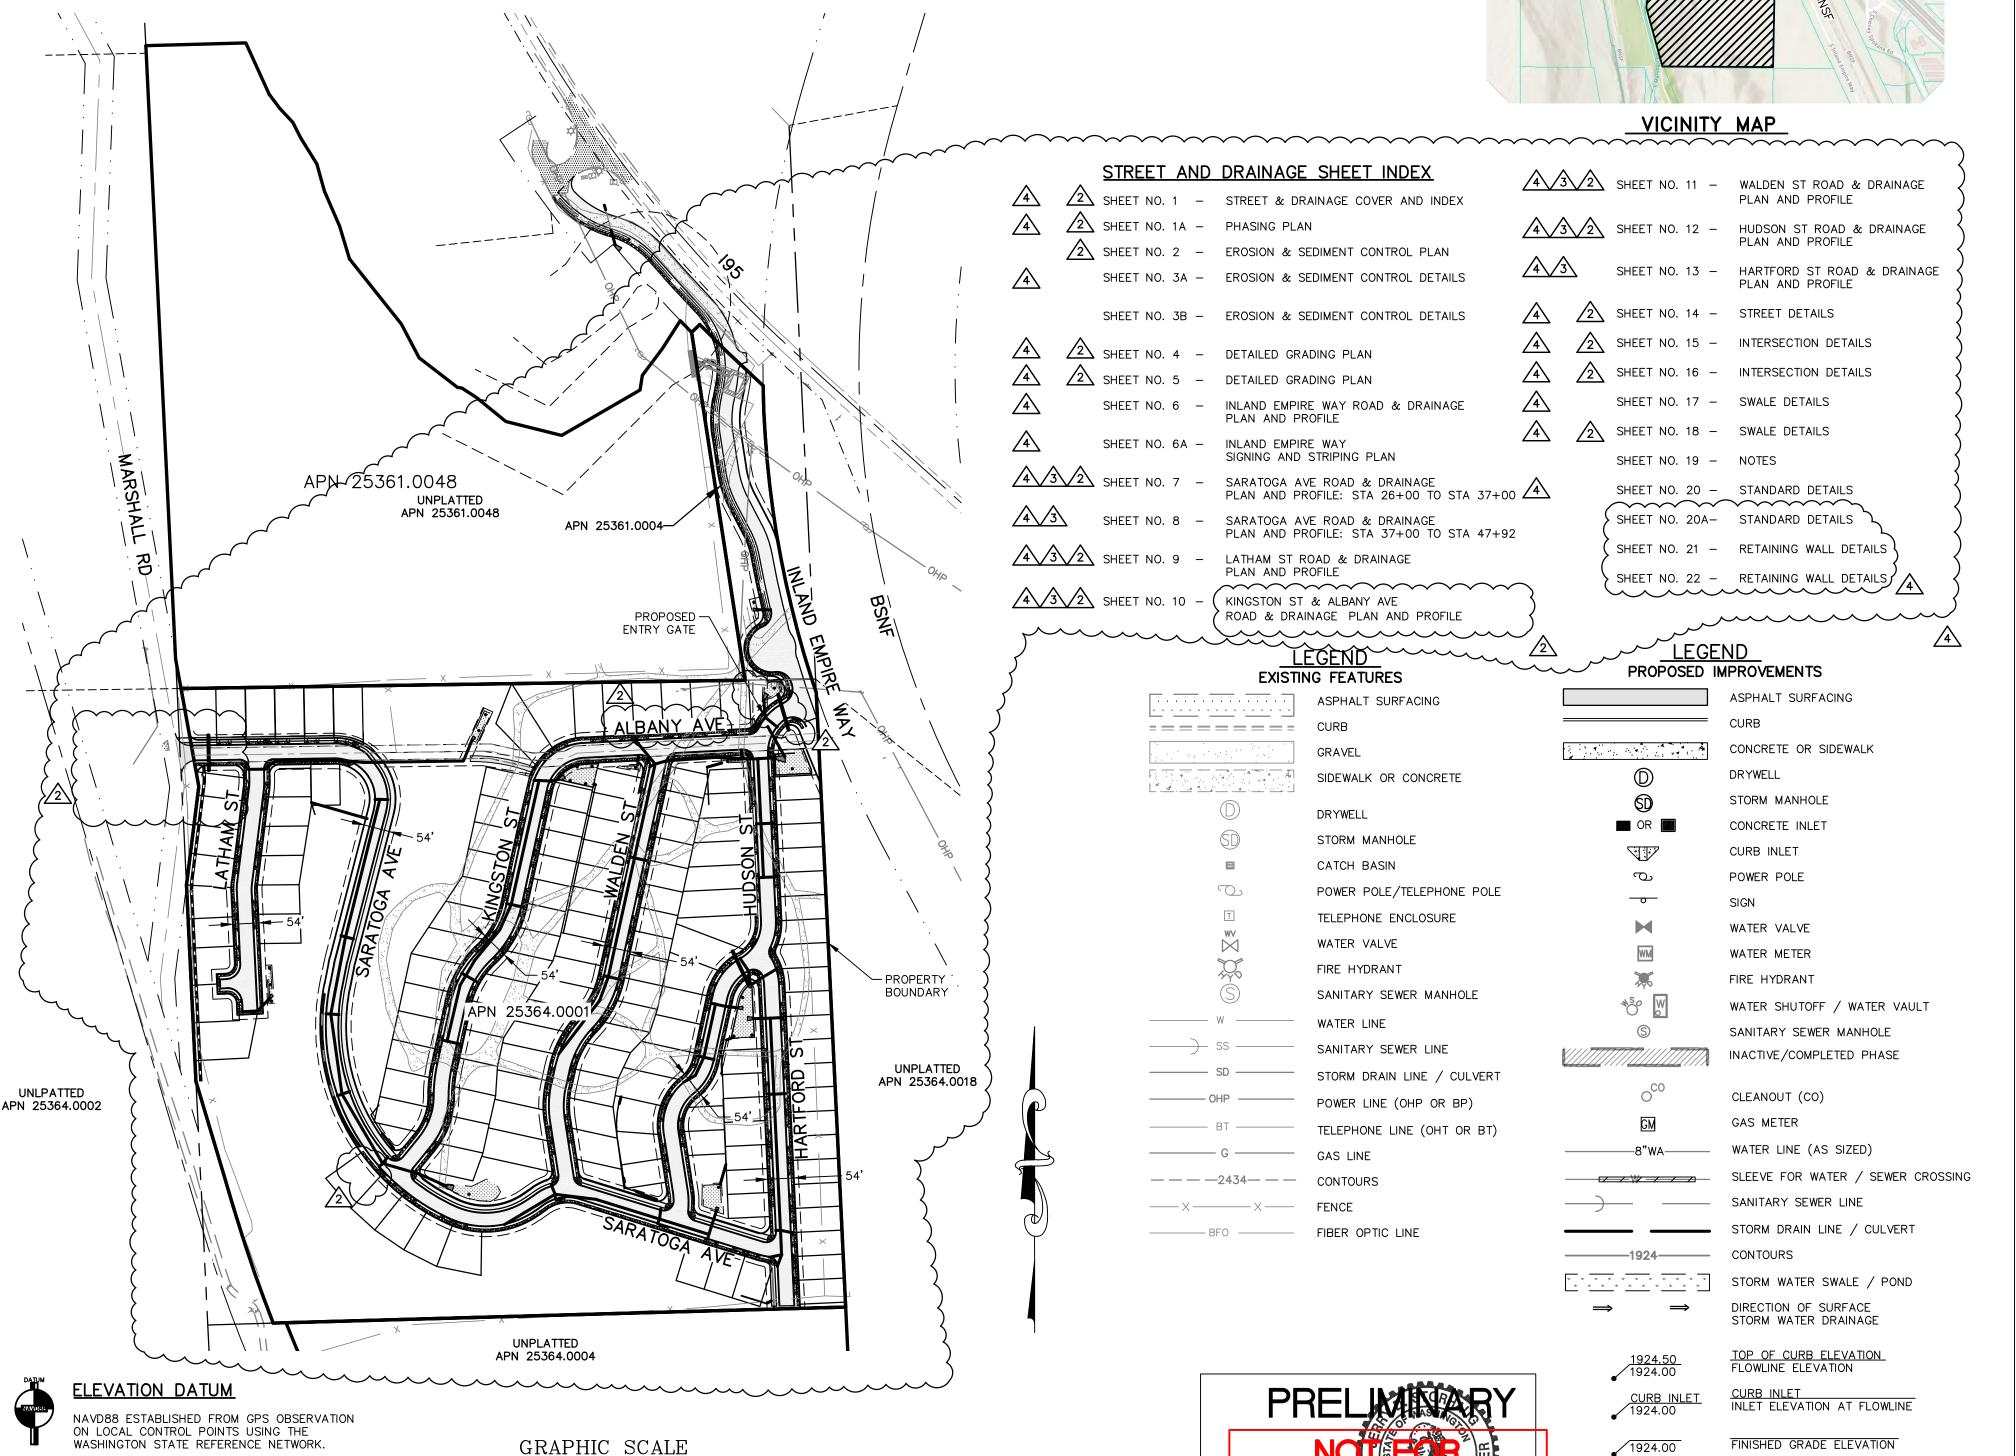

>				landscape ard	chitecture surveying	DATE. 0/11/24	}
{	REVISIONS NAVD88	= ESTABLISHED FROM GPS		SE#19-342	510 east third avenue spokane, wa 99202 p 509.242.1000 f 509.242.1001	PROJECT NAME: LATAH GLEN RESIDENTIAL CC	DMMUNITY
}		100' 0' 100' 20	BENCH MARK LOCATION: 5/8" REBAR WITH PLASTIC CAP	CONTANT	CITY OF SPOKANE, WASHINGTON	SEGMENT LIMITS:	TYPE OF IMPROVEMENT: SITE/DRAINAGE
}	NAVD88 ELEV. :	1843.87	PLS 48373 AT THE SOUTHEAST PROPERTY CORNER	DEP	PARTMENT OF ENGINEERING SERVICES 808	STREET & DRAINAGE COVER AND INDEX	PROJECT NO. PLAN NO.
>	5/14/25 LC 19-342 GENERAL REVISION /3 CBM NO. : 10/10/24 LC 19-342 GENERAL REVISION /2	SCALE IN FEET	HORIZONITAL SCALE (22 × 34)	DRAWN: IMC 3/3/2023	WEST SPOKANE FALLS BLVD. SPOKANE,	APN 25361.0001 & 25364.0001	2022540/2022520
>	4/10/24 LC 19-342 ASI #1 CONTRACTOR QUESTIONS /1 NAVD88 [DATE BY PROJECT DESCRIPTION	ATUM SOALL III I LLI	VERTICAL SCALE (22 x 34)	APPROVED: JDS 01/19/2024	WASHINGTON 99201-3343 (509) 625-6700	PROJECT LIMITS: LATAH GLEN RESIDENTIAL	2023519/2023520 36-25N-42E
(•	,			CALL BEFORE Y	OU DIG 1-800-424-5555

(IN FEET)

1 inch = 200 ft.


SITE TBM


3" BRASS CAP. WA DNR

APN: 25364.0001

ELEVATION: 1822.53

LOCATED NEAR THE NORTHEAST CORNER OF

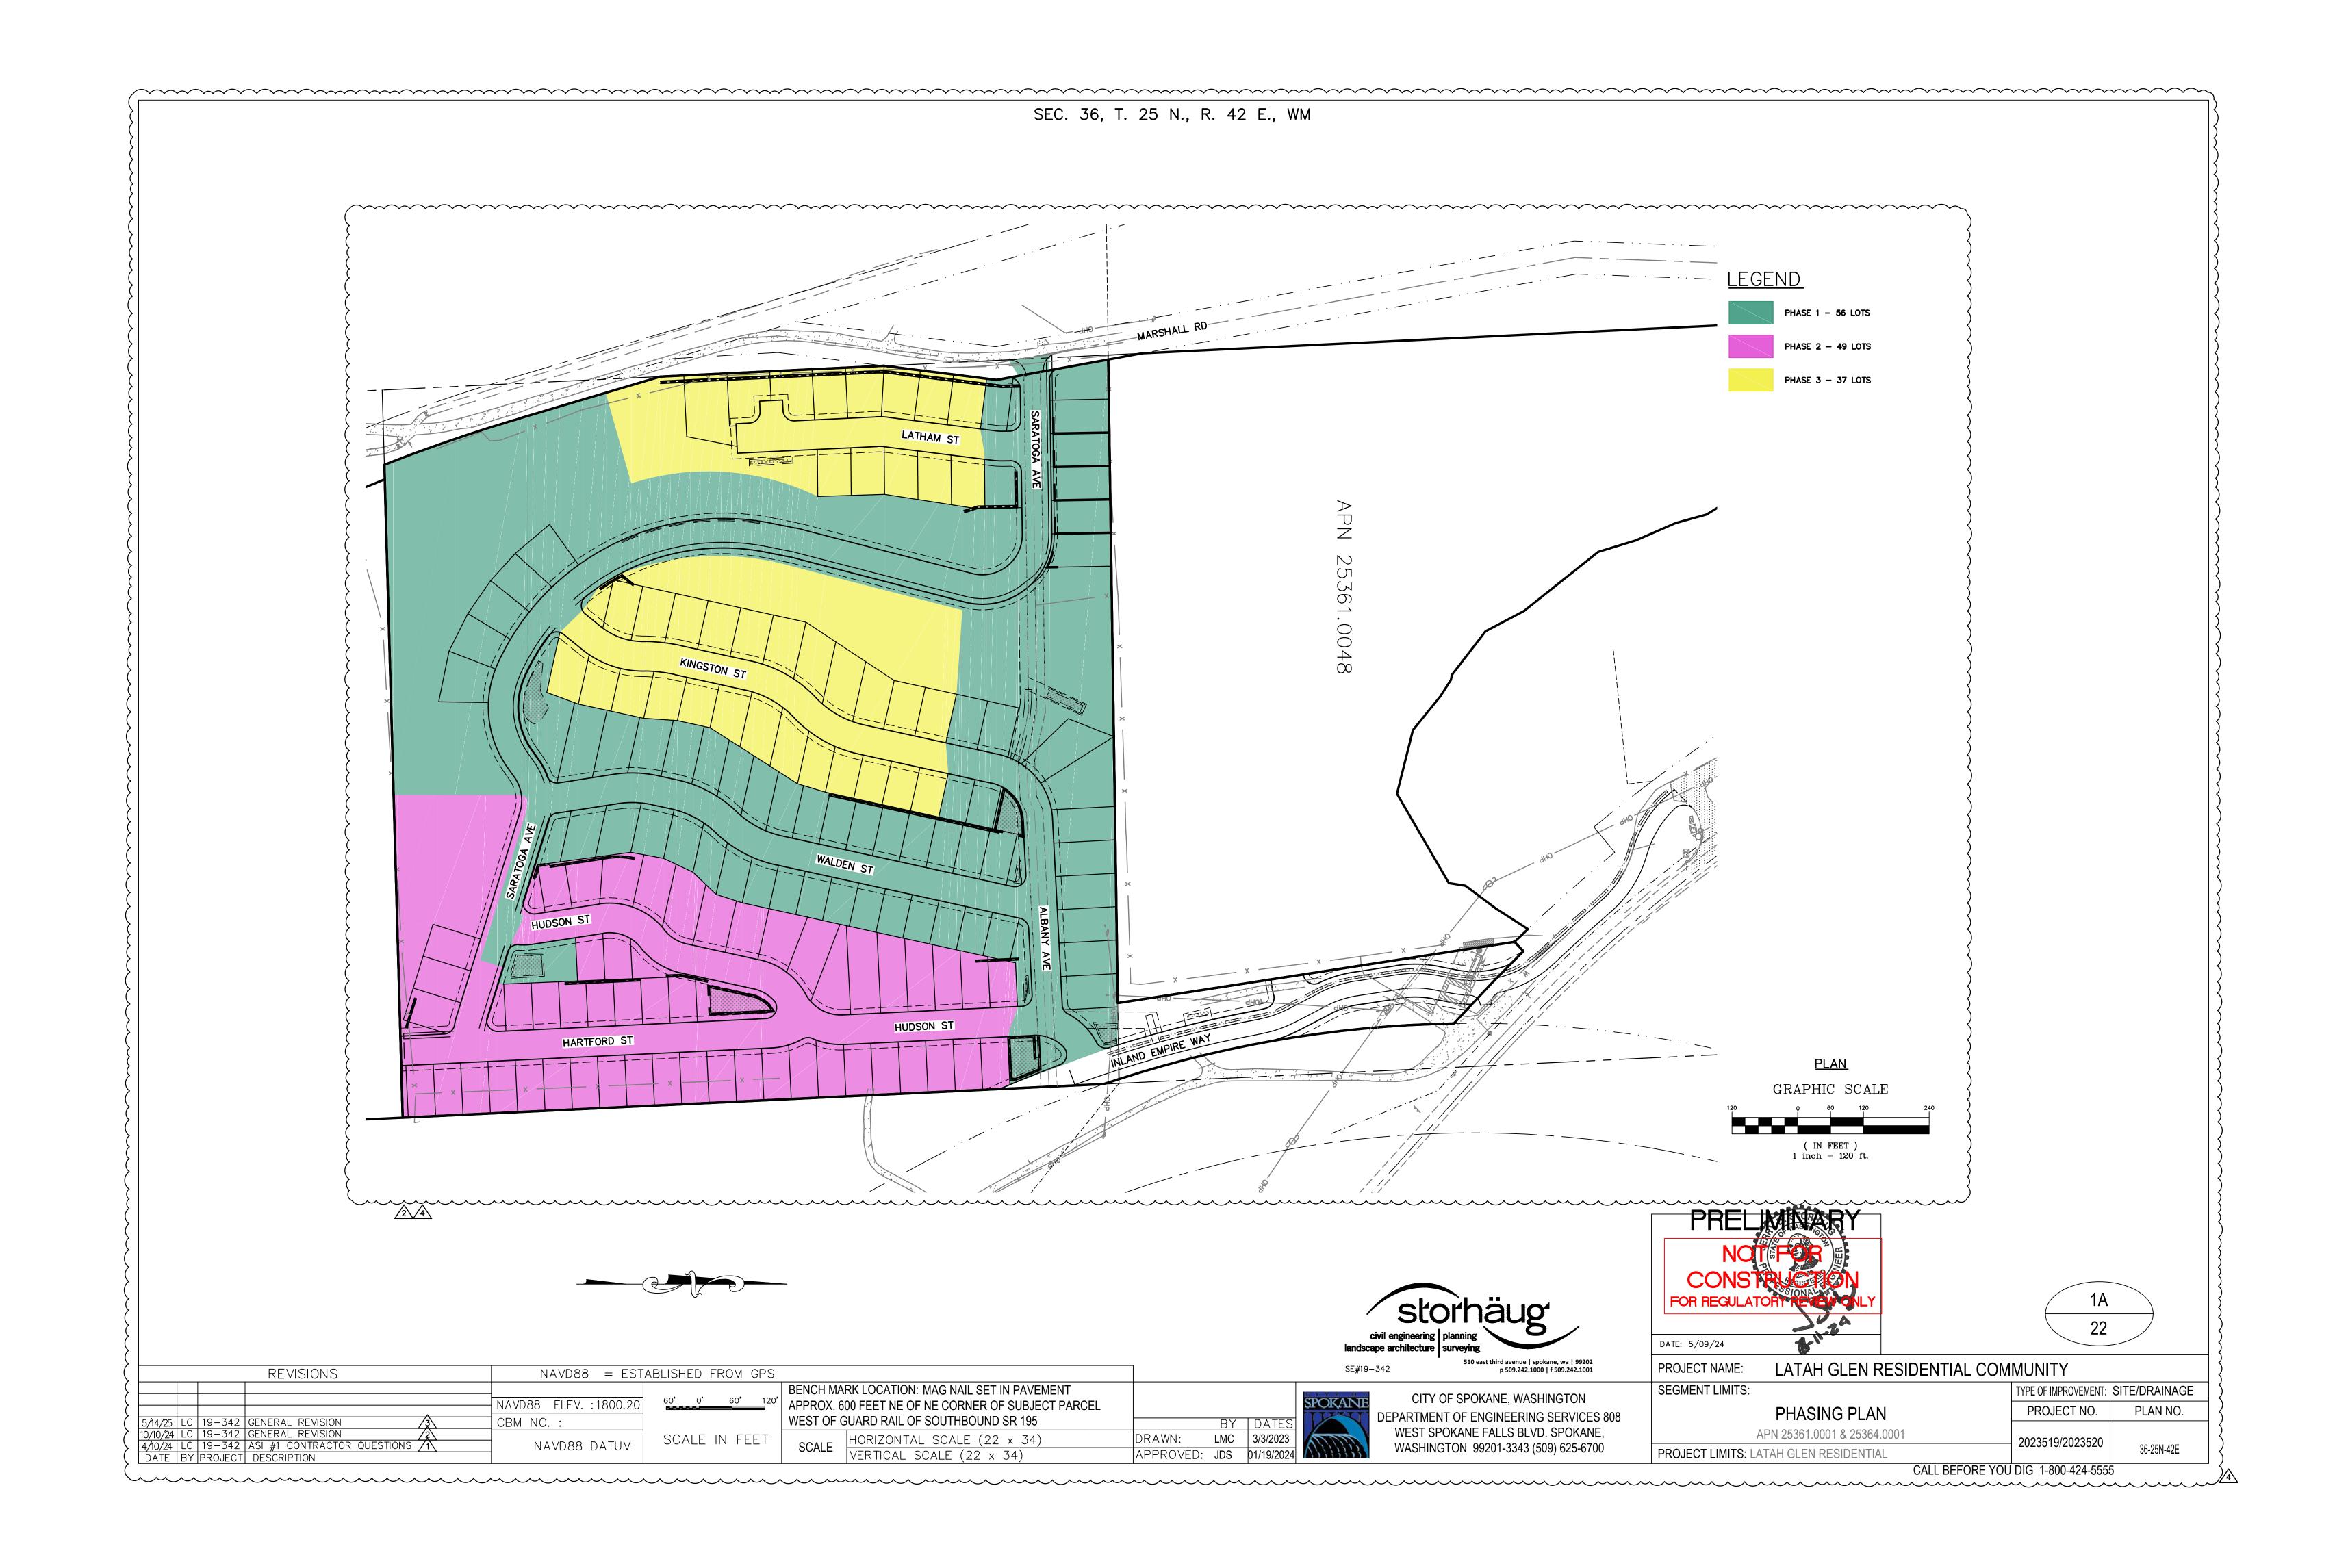

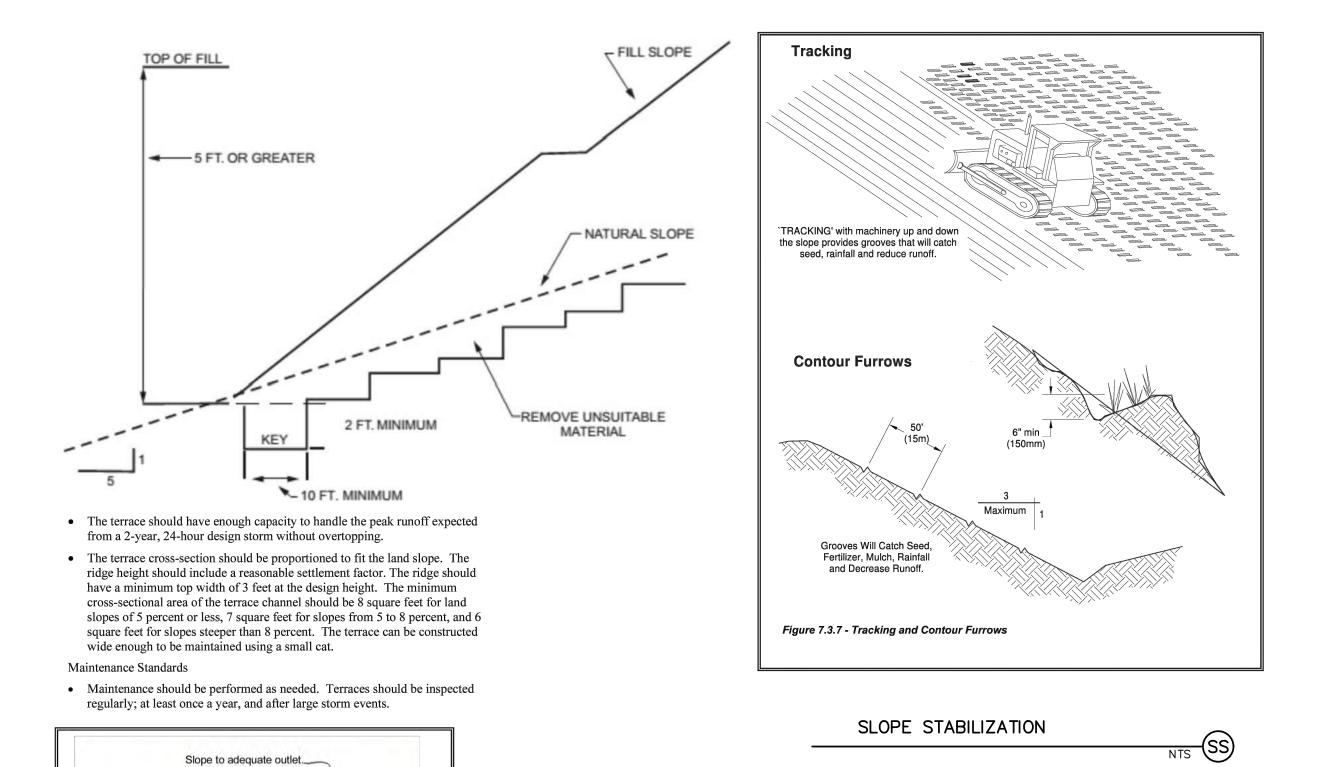

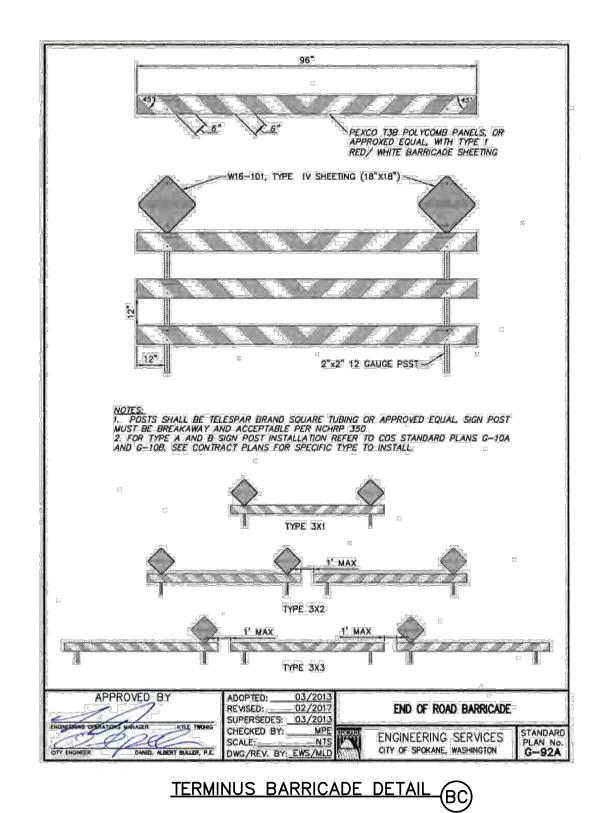


Figure 7.3.8 - Gradient Terraces TERRACED SLOPE



DATE: 6/11/24 PROJECT NAME: LATAH GLEN RESIDENTIAL COMMUNITY

3B

REVISIONS NAVD88 = ESTABLISHED FROM GPSNAVD88 ELEV.:1843.87 5/14/25 LC 19-342 GENERAL REVISION
10/10/24 LC 19-342 GENERAL REVISION
2
4/10/24 LC 19-342 ASI #1 CONTRACTOR QUESTIONS
1
DATE BY PROJECT DESCRIPTION CBM NO. SCALE IN FEET

NAVD88 DATUM

BENCH MARK LOCATION: 5/8" REBAR WITH PLASTIC CAP PLS 48373 AT THE SOUTHEAST PROPERTY CORNER BY DATES HORIZONTAL SCALE (22 x 34)
VERTICAL SCALE (22 x 34) LMC 3/3/2023 DRAWN: APPROVED: JDS 01/19/2024

CITY OF SPOKANE, WASHINGTON DEPARTMENT OF ENGINEERING SERVICES 808 WEST SPOKANE FALLS BLVD. SPOKANE, WASHINGTON 99201-3343 (509) 625-6700

SEGMENT LIMITS: EROSION CONTROL NOTES AND DETAILS

PROJECT LIMITS: LATAH GLEN RESIDENTIAL

TYPE OF IMPROVEMENT: SITE/DRAINAGE PROJECT NO. PLAN NO. 2023519/2023520 36-25N-42E

STANDARD NOTES: A. THE FILTER FABRIC FENCE SHALL BE PURCHASED IN A CONTINUOUS ROLL CUT TO THE LENGTH OF THE BARRIER TO AVOID USE OF JOINTS. WHEN JOINTS ARE NECESSARY, OVERLAP FILTER CLOTH AND SECURELY FASTEN BOTH ENDS TO THE POST. B. POSTS SHALL BE SPACED A MAXIMUM OF 6 FEET APART AND DRIVEN SECURELY INTO THE GROUND A MINIMUM OF 30 INCHES (WHERE PHYSICALLY POSSIBLE). . A TRENCH SHALL BE EXCAVATED APPROXIMATELY 8 INCHES WIDE AND 12 INCHES DEEP ALONG THE LINE OF POSTS AND UP-SLOPE FROM THE BARRIER. THE TRENCH SHALL BE CONSTRUCTED TO FOLLOW THE CONTOURS. D. WHEN SLIT FILM FILTER FABRIC IS USED, A WIRE MESH SUPPORT FENCE SHALL BE FASTENED SECURELY TO THE UP-SLOPE SIDE OF THE POSTS USING HEAVY-DUTY WIRE STAPLES AT LEAST 1 INCH LONG, TIE WIRES OR HOG RINGS. THE WIRE SHALL EXTEND INTO HE TRENCH A MINIMUM OF 4 INCHES AND SHALL NOT EXTEND MORE THAN 36 INCHES ABOVE THE ORIGINAL GROUND SURFACE. SLIT FILM FILTER FABRIC SHALL BE WIRED TO THE FENCE, AND 20 INCHES OF THE FABRIC SHALL EXTEND INTO THE TRENCH. THE FABRIC SHALL NOT EXTEND MORE THAN 36 INCHES ABOVE THE ORIGINAL GROUND SURFACE. FILTER FABRIC SHALL NOT BE STAPLED TO EXISTING TREES. OTHER TYPES OF FABRIC MAY BE STAPLED TO THE FENCE.

WHEN EXTRA-STRENGTH OR MONOFILAMENT FABRIC AND CLOSER POST SPACING ARE USED, THE WIRE MESH SEPPORT FENCE MAY BE ELIMINATED. IN SUCH A CASE, E FILTER FABRIC IS STAPLED OR WIRED DIRECTLY TO THE POSTS WITH ALL OTHER PROVISIONS OF STANDARD NOTE "E" APPLYING. EXTRA CARE SHOULD BE USED WHEN JOINING OR OVERLAPPING THESE STIFFER FABRICS.

G. LOCAL GOVERNMENTS MAY SPECIFY THE USE OF PROPERLY COMPACTED NATIVE MATERIALS. IN MANY INSTANCES, THIS MAY BE THE PREFERRED ALTERNATIVE BECAUSE THE SOIL FORMS A MORE CONTINUOUS CONTACT WITH THE TRENCH BELOW.

A TEMPORARY SEDIMENT BARRIER CONSISTING OF A FILTER FABRIC STRETCHED ACROSS AND ATTACHED TO SUPPORTING POSTS AND ENTRENCHED. THE FILTER FENCE IS CONSTRUCTED OF STAKES AND SYNTHETIC FILTER FABRIC WITH A RIGID WIRE FENCE BACKING WHERE NECESSARY FOR SUPPORT.

PURPOSE: 1. TO INTERCEPT AND DETAIN SMALL AMOUNTS OF SEDIMENT UNDER SHEET FLOW CONDITIONS FROM DISTURBED AREAS DURING CONSTRUCTION OPERATIONS IN ORDER TO PREVENT SEDIMENT FROM LEAVING THE SITE.

2. TO DECREASE THE VELOCITY OF SHEET FLOWS. CONDITIONS WHERE PRACTICE APPLIES: FILTER FENCES MUST BE PROVIDED JUST UPSTREAM OF THE POINT(S) OF DISCHARGE OF RUNOFF FROM A SITE, BEFORE THE FLOW BECOMES CONCENTRATED. THEY MAY ALSO BE REQUIRED:

BELOW DISTURBED AREAS WHERE RUNOFF MAY OCCUR IN THE FORM OF SHEET AND RILL EROSION; WHEREVER RUNOFF HAS THE POTENTIAL TO IMPACT DOWNSTREAM

2. PERPENDICULAR TO MINOR SWALES OR DITCH LINES FROM CONTRIBUTING DRAINAGE AREAS UP TO ONE ACRE

3. CONTRACTOR SHALL COORDINATE WITH DESIGN ENGINEER FOR ACTUAL PLACEMENT LOCATIONS. MAINTENANCE: THE FILTER FENCE AND INLET PROTECTIONS SHALL BE MAINTAINED IN A CONDITION WHICH WILL PREVENT TRACKING OR FLOW OF MUD AND SEDIMENT OFF OF THE CONSTRUCTION SITE. THIS MAY REQUIRE PERIODIC CLEANING WHEN SEDIMENT BUILD UP IS SIX INCHES OR ONE-THIRD OF THE FENCE OR INLET PROTECTION'S ORIGINAL HEIGHT.

2" BY 2" WOODEN POSTS. —

STANDARD OR BETTER OR

WIRE MESH SUPPORT FENCE-

FILTER FABRIC MATERIAL

DATE BY PROJECT DESCRIPTION


FOR SLIT FILM FABRICS.

EQUIVALENT.

FILTER FENCE

TILTER FABRIC-

MATERIAL

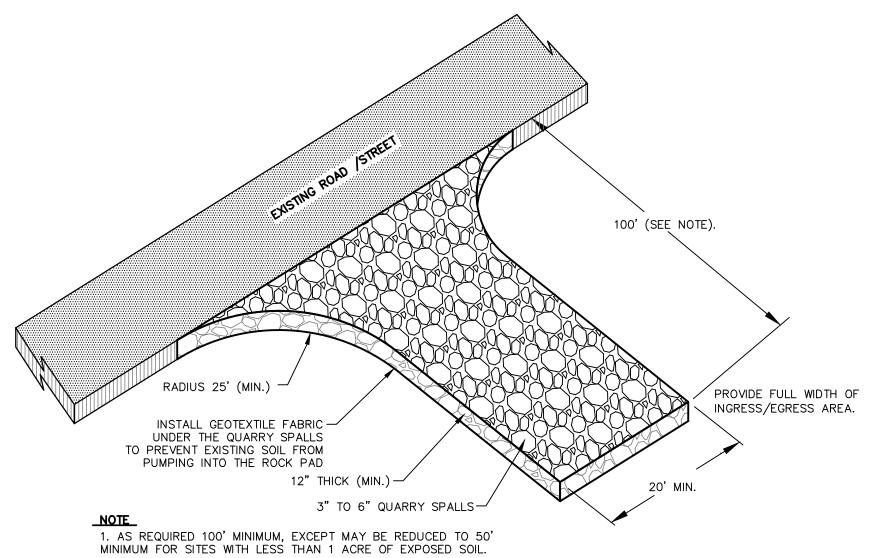

DEFINITION: A TEMPORARY STONE-STABILIZED PAD LOCATED AT POINTS OF

VEHICULAR INGRESS AND EGRESS ON A CONSTRUCTION SITE.

FILTER FABRIC -

BURIED FILTER FABRIC

SEE SECTION

FOR INLET

FILTER

STAKE-

STORM DRAIN STRUCTURE -

WITH FRAME AND GRATE

PURPOSE: TO REDUCE THE AMOUNT OF MUD, DIRT, ROCK, ETC. TRANSPORTED ONTO PUBLIC ROADS BY MOTOR VEHICLES OR RUNOFF BY CONSTRUCTING A STABILIZED PAD OF ROCK SPALLS AT ENTRANCES TO CONSTRUCTION SITES AND WASHING OF TIRES DURING EGRESS

CONDITIONS WHERE PRACTICE APPLIES: WHEREVER TRAFFIC WILL BE LEAVING A CONSTRUCTION SITE AND MOVING DIRECTLY ONTO A PUBLIC ROAD OR OTHER PAVED

MAINTENANCE: THE ENTRANCE SHALL BE MAINTAINED IN A CONDITION WHICH WILL PREVENT TRACKING OR FLOW OF MUD ONTO PUBLIC RIGHT-OF-WAY. THIS MAY REQUIRE PERIODIC TOP DRESSING WITH 2-INCH STONES, AS CONDITIONS DEMAND, AND REPAIR AND/OR CLEANOUT OF ANY STRUCTURES USED TO TRAP SEDIMENT. ALL MATERIALS SPILLED, DROPPED, WASHED OR TRACKED FROM VEHICLES ONTO ROADWAYS OR INTO STORM DRAINS MUST BE REMOVED.

TIRE WASH: TIRE WASH IS RECOMMENDED DUE TO ONSITE SOILS. THE TIRE WASH SHALL BE REQUIRED BY THE CITY IF IT IS FOUND THAT ANY OF THE FOLLOWING ITEMS ARE NOT BEING DONE

1. THE ROCK CONSTRUCTION EXIT IS NOT BUILT TO THE EASTERN WASHINGTON STORM WATER MANUAL STANDARDS. 2. THE ROCK CONSTRUCTION ENTRANCE IS NOT MAINTAINED PER THE EASTERN WASHINGTON STORM WATER MANUAL STANDARDS. 3. ANY MATERIAL TRACKED OFF THE SITE IN NOT CLEANED UP REGULARLY

THE CITY MAY AT IT'S DISCRETION REQUIRE THE TIRE WASH AREA TO BE INSTALLED IF IT FEELS THAT IT IS IN THE BEST INTEREST OF THE CITY OR THE NEIGHBORS TO

STABILIZED CONSTRUCTION EXIT/

FILTERED WATER

-WASHED GRAVEL

FILTER FABRIC

1. ALL DRYWELLS, INLETS, CATCH BASIN AND

ANY OTHER STORMDRAIN FIXTURES WITH GRATED INLETS SHALL BE PROTECTED.

2. PROTECTION SHALL REMAIN IN PLACE

3. SEDIMENT MUST BE REMOVED WHEN IT REACHES 6" OR 1 OF THE HEIGHT OF THE

UNTIL VEGETATION IS ESTABLISHED.

SECTION

_ _ _ _ _ _

NOTE:

TEMPORARY INLET PROTECTION (IP

SEC. 36, T. 25 N., R. 42 E., WM

USE THE FOLLOWING SEEDING SPECIFICATIONS WHEREVER SOIL IS DISTURBED:

PROVIDE FRESH, CLEAN NEW CROP SEED COMPLYING WITH TOLERANCE FOR PURITY AND GERMINATION ESTABLISHED BY OFFICIAL SEED ANALYSTS OF NORTH AMERICA. PROVIDE SEED MIXTURE COMPOSED OF GRASS SPECIES AND PERCENTAGES AS FOLLOWS:

20 PERCENT ELKA PERENNIAL RYE

20 PERCENT DURAR HARD FESCUE 45 PERCENT COVAR SHEEP /FESCUE

15 PERCENT REUBENS CANADIAN BLUEGRASS

PROVIDE MIXTURE COMPOSED OF GRASS SEED AND FERTILIZER IN PERCENTAGES AS FOLLOWS:

GRASS SEED MIXTURE: 90 LBS. PER ACRE FERTILIZER: 16:16:16 TIMED RELEASE COMPOSITION, 300 LBS. PER ACRE

ALL SEEDING OF SLOPES SHALL BE DONE IN ACCORDANCE WITH CITY OF SPOKANE VALLEY STANDARDS.

CONTRACTOR SHALL IRRIGATE SEEDED AREAS UNTIL SEED HAS GERMINATED AND HAS BEEN ACCEPTED BY OWNER.


SEEDING SPECIFICATION

OVISION OF A ROUGH SOIL SURFACE WITH HORIZONTAL DEPRESSIONS CREATED BY OPERATING A TILLER OR OTHER SUITABLE EQUIPMENT ON THE CONTOUR OR BY LEAVING SLOPES IN A ROUGHED CONDITION BY NOT FINE GRADING THEM.

TO AID IN ESTABLISHMENT OF VEGETATIVE COVER, REDUCE RUNOFF VELOCITY, INCREASE INFILTRATION, AND PROVIDE FOR SEDIMENT TRAPPING.

CONDITIONS WHERE PRACTICE APPLIES:

ALL SLOPES STEEPER THAN 4:1 IN BOTH CUT AND FILL REQUIRE SURFACE ROUGHENING WITH DOZER TRACKING. IN ADDITION SLOPES STEEPER THAN 30:1 IN BOTH CUT AND FILL REQUIRE SURFACE ROUGHENING WITH EITHER STAIR—STEP GRADING, GROOVING, FURROWING, OR TRACKING. COMPLETE SURFACE ROUGHENING PER IDEQ CATALOG OF BEST MANAGEMENT PRACTICES VOLUME 2, BMP 84.

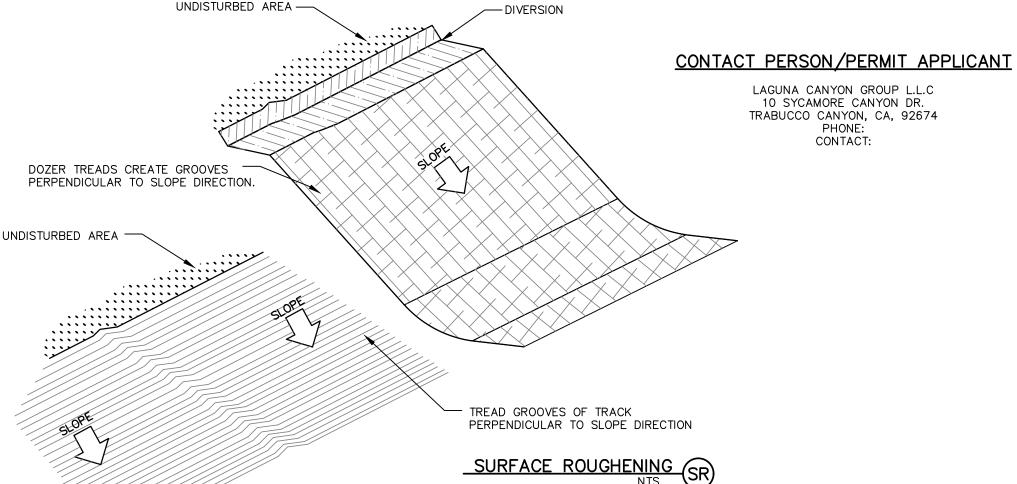

DEFINITION: A TEMPORARY PREFABRICATED CONCRETE WASHOUT CONTAINER OR SELF-INSTALLED STRUCTURE (ABOVE OR BELOW GRADE), APPROVED BY THE ENGINEER, USED TO DETAIN CONCRETE WASTE.

PURPOSE: TO PREVENT OR REDUCE THE DISCHARGE OF POLLUTANTS TO STORMWATER FROM CONCRETE WASTE BY CONDUCTING WASHOUT OFFSITE OR PERFORMING ONSITE WASHOUT IN A DESIGNATED AREA TO PREVENT POLLUTANTS FROM ENTERING SURFACE WATERS OR GROUNDWATER.

CONDITIONS WHERE PRACTICE APPLIES: WHENEVER CONCRETE IS USED AS A CONSTRUCTION MATERIAL AND IT IS NOT POSSIBLE TO DISPOSE OF ALL CONCRETE WASTEWATER AND WASHOUT OFFSITE.

MAINTENANCE: THE CONCRETE WASHOUT FACILITY SHALL BE INSPECTED FOR CAPACITY AND LEAKAGE PRIOR TO THE COMMENCEMENT OF CONCRETE WORK AND DAILY THEREAFTER WASHOUT FACILITIES MUST BE CLEANED, OR NEW FACILITIES PROVIDED AND READY FOR USE ONCE THE WASHOUT BECOMES 75% FULL.

1. CONCRETE TRUCK CHUTES, PUMPS, AND INTERNALS SHALL BE WASHED OUT ONLY INTO FORMED AREAS AWAITING INSTALLATION OF CONCRETE OR ASPHALT.

2. UN-USED CONCRETE REMAINING IN THE TRUCK AND PUMP SHALL BE RETURNED TO THE ORIGINATING BATCH PLANT FOR RECYCLING

3. HAND TOOLS INCLUDING, BUT NOT LIMITED TO, SCREEDS, SHOVELS, RAKES, FLOATS, AND TROWELS SHALL BE WASHED OFF ONLY INTO FORMED AREAS AWAITING INSTALLATION OF CONCRETE OR ASPHALT.

4. EQUIPMENT THAT CANNOT BE EASILY MOVED, SUCH AS CONCRETE PAVERS, SHALL ONLY BE WASHED IN AREAS THAT NO NOT DIRECTLY DRAIN TO NATURAL OR CONSTRUCTED STORMWATER CONVEYANCES.

5. WHEN NO FORMED AREAS ARE AVAILABLE, WASHWATER AND LEFTOVER PRODUCT SHALL BE CONTAINED IN A LINED CONTAINER. CONTAINED CONCRETE SHALL BE DISPOSED OF IN A MANNER THAT DOES NOT VIOLATE GROUNDWATER OR SURFACE WATER QUALITY STANDARDS.

CONCRETE WASHOUT NOTES



510 east third avenue | spokane, wa | 99202 p 509.242.1000 | f 509.242.1001 CITY OF SPOKANE, WASHINGTON

DEPARTMENT OF ENGINEERING SERVICES 808 WEST SPOKANE FALLS BLVD. SPOKANE, WASHINGTON 99201-3343 (509) 625-6700

PROJECT / SITE DESCRIPTION

THE PROPOSED PROJECT INCLUDES ROAD AND UTILITY CONSTRUCTION WITH ASSOCIATED STORM DRAINAGE FACILITIES FOR A PROPOSED RESIDENTIAL SUBDIVISION.

ESC MEASURES

PROTECT EXISTING AND PROPOSED STORM WATER MANAGEMENT FACILITIES FROM SEDIMENTATION DURING CONSTRUCTION ACTIVITIES. FILTER FENCES SHALL BE USED TO AID IN CONTAINING ANY SEDIMENT ON THE SITE DURING GRADING AND CONSTRUCTION. STABILIZED CONSTRUCTION EXITS SHALL BE USED AT POINTS OF INGRESS AND EGRESS FOR CONSTRUCTION VEHICLES. INLET PROTECTION SHALL BE USED AT ALL STORM WATER INLETS AND DRYWELLS. PROVIDE DUST CONTROL DURING DRY SEASON.

REFER TO PLAN VIEW ON THIS SHEET FOR APPROXIMATE LOCATION OF THE ABOVE ITEMS.

ALL DISTURBED AREAS SHALL BE SEEDED OR LANDSCAPED PER THE LANDSCAPE PLAN.

EROSION AND SEDIMENT CONTROL MEASURES SHALL CONFORM TO THE CITY OF HAYDEN CODE AND THE STATE OF IDAHO CATALOG OF STORM WATER BEST MANAGEMENT PRACTICES FOR IDAHO CITIES AND COUNTIES PREPARED BY THE WATERSHED AND AQUIFER PROTECTION BUREAU OF THE IDAHO DIVISION OF ENVIRONMENTAL QUALITY.

EROSION CONTROL MEASURES IN ADDITION TO THOSE INDICATED AS PART OF THIS PLAN MAY BE REQUIRED IF THE CITY ENGINEER DETERMINES INDICATED MEASURES ARE INADEQUATE.

PERIODIC MAINTENANCE OF EROSION CONTROL MEASURES IS REQUIRED UNTIL PERMANENT DRAINAGE FACILITIES ARE OPERATIONAL AND SUFFICIENT VEGETATION IS ESTABLISHED.

CONTRACTOR SHALL PROVIDE DUST CONTROL DURING CONSTRUCTION.

CONTRACTOR IS RESPONSIBLE FOR PREPARATION OPF STORM WATER POLLUTION PREVENTION PLAN (SWPPP), NOTICE OF INTENT, AND IMPLEMENTATION OF PERMIT.

EXISTING CONDITIONS


THE PROJECT SITE IS AN UNDEVELOPED SITE WITH SOME TREES AND GRAVEL.

- 1. THE FOLLOWING CONSTRUCTION SEQUENCE SHALL BE FOLLOWED IN ORDER TO BEST MINIMIZE THE POTENTIAL FOR EROSION AND SEDIMENTATION CONTROL PROBLEMS:
- 1.a. CLEAR AND GRUB SUFFICIENTLY FOR INSTALLATION OF TEMPORARY ESC BMPS; 1.b. INSTALL TEMPORARY ESC BMPS, CONSTRUCTING SEDIMENT TRAPPING BMPS AS ONE OF THE FIRST
- STEPS PRIOR TO GRADING 1.c. CLEAR, GRUB AND ROUGH GRADE FOR ROADS, TEMPORARY ACCESS POINTS AND UTILITY LOCATIONS;
- 1.d. STABILIZE ROADWAY APPROACHES AND TEMPORARY ACCESS POINTS WITH THE APPROPRIATE CONSTRUCTION ENTRY BMP;
- 1.e. CLEAR, GRUB AND GRADE INDIVIDUAL LOTS OR GROUPS OF LOTS;
 1.f. TEMPORARILY STABILIZE, THROUGH RE-VEGETATION OR OTHER APPROPRIATE BMPS, LOTS OR GROUPS
- OF LOTS IN SITUATIONS WHERE SUBSTANTIAL CUT OR FILL SLOPES ARE A RESULT OF THE SITE
- 1.g. CONSTRUCT ROADS, BUILDINGS, PERMANENT STORMWATER FACILITIES (I.E. INLETS, PONDS, UIC
- 1.h. PROTECT ALL PERMANENT STORMWATER FACILITIES UTILIZING THE APPROPRIATE BMPS; 1.i. INSTALL PERMANENT ESC CONTROLS, WHEN APPLICABLE; AND, REMOVE TEMPORARY ESC CONTROLS WHEN:
- i.j.a. PERMANENT ESC CONTROLS, WHEN APPLICABLE, HAVE BEEN COMPLETELY INSTALLED;
- ALL LAND-DISTURBING ACTIVITIES THAT HAVE THE POTENTIAL TO CAUSE EROSION OR SEDIMENTATION PROBLEMS HAVE CEASED; AND,
- VEGETATION HAD BEEN ESTABLISHED IN THE AREAS NOTED AS REQUIRING VEGETATION ON THE ACCEPTED ESC PLAN ON FILE WITH THE LOCAL JURISDICTION.
- 2. INSPECT ALL ROADWAYS, AT THE END OF EACH DAY, ADJACENT TO THE CONSTRUCTION ACCESS ROUTE. IF IT IS EVIDENT THAT SEDIMENT HAS BEEN TRACKED OFF SITE AND/OR BEYOND THE ROADWAY
- APPROACH, CLEANING IS REQUIRED. 3. IF SEDIMENT REMOVAL IS NECESSARY PRIOR TO STREET WASHING, IT SHALL BE REMOVED BY SHOVELING
- OR PICKUP SWEEPING AND TRANSPORTED TO A CONTROLLED SEDIMENT DISPOSAL AREA. 4. IF STREET WASHING IS REQUIRED TO CLEAN SEDIMENT TRACKED OFF SITE, ONCE SEDIMENT HAS BEEN REMOVED, STREET WASH WASTEWATER SHALL BE CONTROLLED BY PUMPING BACK ON-SITE OR
- OTHERWISE PREVENTED FROM DISCHARGING INTO SYSTEMS TRIBUTARY TO WATERS OF THE STATE.
- RESTORE CONSTRUCTION ACCESS ROUTE EQUAL TO OR BETTER THAN THE PRE-CONSTRUCTION
- 6. RETAIN THE DUFF LAYER, NATIVE TOPSOIL, AND NATURAL VEGETATION IN AN UNDISTURBED STATE TO THE MAXIMUM EXTENT PRACTICAL. 7. INSPECT SEDIMENT CONTROL BMPS WEEKLY AT A MINIMUM, DAILY DURING A STORM EVENT, AND AFTER
- ANY DISCHARGE FROM THE SITE (STORMWATER OR NON-STORMWATER). THE INSPECTION FREQUENCY MAY BE REDUCED TO ONCE A MONTH IF THE SITE IS STABILIZED AND INACTIVE
- 8. CONTROL FUGITIVE DUST FROM CONSTRUCTION ACTIVITY IN ACCORDANCE WITH THE STATE AND/OR LOCAL AIR QUALITY CONTROL AUTHORITIES WITH JURISDICTION OVER THE PROJECT AREA.
- 9. STABILIZE EXPOSED UNWORKED SOILS (INCLUDING STOCKPILES), WHETHER AT FINAL GRADE OR NOT, WITHIN 10 DAYS DURING THE REGIONAL DRY SEASON (JULY 1 THROUGH SEPTEMBER 30) AND WITHIN 5 DAYS DURING THE REGIONAL WET SEASON (OCTOBER 1 THROUGH JUNE 30). SOILS MUST BE STABILIZED AT THE END OF A SHIFT BEFORE A HOLIDAY WEEKEND IF NEEDED BASED ON THE WEATHER FORECAST. THIS TIME LIMIT MAY ONLY BE ADJUSTED BY A LOCAL JURISDICTION WITH A "QUALIFIED LOCAL
- PROGRAM," IF IT CAN BE DEMONSTRATED THAT THE RECENT PRECIPITATION JUSTIFIES A DIFFERENT STANDARD AND MEETS THE REQUIREMENTS SET FOURTH IN THE CONSTRUCTION STORMWATER GENERAL 10. PROTECT INLETS, DRYWELLS, CATCH BASINS AND OTHER STORMWATER MANAGEMENT FACILITIES FROM
- SEDIMENT, WHETHER OR NOT FACILITIES ARE OPERABLE.
- 11. KEEP ROADS ADJACENT TO INLETS CLEAN. 12. INSPECT INLETS WEEKLY AT A MINIMUM AND DAILY DURING STORM EVENTS.
- 13. CONSTRUCT STORMWATER CONTROL FACILITIES (DETENTION/RETENTION STORAGE POND OR SWALES) BEFORE GRADING BEGINS. THESE FACILITIES SHALL BE OPÉRATIONAL BEFORE THE CONSTRUCTION ÓF IMPERVIOUS SITE IMPROVEMENTS.
- 14. STOCKPILE MATERIALS (SUCH AS TOPSOIL) ON SITE, KEEPING OFF OF ROADWAY AND SIDEWALKS. 15. COVER, CONTAIN AND PROTECT ALL CHEMICALS, LIQUID PRODUCTS, PETROLEUM PRODUCT, AND NONINERT WASTES PRESENT ON SITE FROM VANDALISM (SEE CHAPTER 173-304 WAC FOR THE DEFINITION OF INERT WASTE). USE SECONDARY CONTAINMENT FOR ON-SITE FUELING TANKS.
- 16. CONDUCT MAINTENANCE AND REPAIR OF HEAVY EQUIPMENT AND VEHICLES INVOLVING OIL CHANGES, HYDRAULIC SYSTEM REPAIRS, SOLVENT AND DEGREASING OPERATIONS, FUEL TANK DRAIN DOWN AND REMOVAL, AND OTHER ACTIVITIES THAT MAY RESULT IN DISCHARGE OR SPILLAGE OF POLLUTANTS TO THE GROUND OR INTO STORMWATER RUNOFF USING SPILL PREVENTION MEASURES, SUCH AS DRIP PANS. CLEAN ALL CONTAMINATED SURFACES IMMEDIATELY FOLLOWING ANY DISCHARGE OR SPILL INCIDENT. IF RAINING OVER EQUIPMENT OR VEHICLE, PERFORM EMERGENCY REPAIRS ON SITE USING TEMPORARY
- 17. CONDUCT APPLICATION OF AGRICULTURAL CHEMICALS, INCLUDING FERTILIZERS AND PESTICIDES, IN SUCH A MANNER, AND AT APPLICATION RATES, THAT INHIBITS THE LOSS OF CHEMICALS INTO STORMWATER RUNOFF FACILITIES. AMEND MANUFACTURER'S RECOMMENDED APPLICATION RATES AND PROCEDURES TO MEET THIS REQUIREMENT, IF NECESSARY.
- 18. INSPECT ON A REGULAR BASIS (AT A MINIMUM WEEKLY, AND DAILY DURING/AFTER A RUNOFF PRODUCING STORM EVENT) AND MAINTAIN ALL EROSION AND SEDIMENT CONTROL BMPS TO ENSURE SUCCESSFUL PERFORMANCE OF THE BMPS. NOTE THAT INLET PROTECTION DEVICES SHALL BE CLEANED OR REMOVED
- AND REPLACE BEFORE SIX INCHES OF SEDIMENT CAN ACCUMULATE. 19. REMOVE TEMPORARY ESC BMPS WITHIN 30 DAYS AFTER THE TEMPORARY BMPS ARE NO LONGER NEEDED. PERMANENTLY STABILIZE AREAS THAT ARE DISTURBED DURING THE REMOVAL PROCESS.
- 20. BMP'S SHALL BE IN ACCORDANCE WITH CHAPTER 7 OF THE STORMWATER MANAGEMENT MANUAL FOR EASTERN WASHINGTON.

ESC STANDARD NOTES



PLASTIC BENEATH THE VEHICLE.

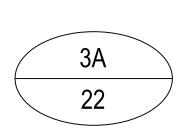

36-25N-42E

LATAH GLEN RESIDENTIAL COMMUNITY PROJECT NAME:

SEGMENT LIMITS:


EROSION CONTROL NOTES AND DETAILS

TYPE OF IMPROVEMENT: SITE/DRAINAGE PROJECT NO. PLAN NO.

2023519/2023520

PROJECT LIMITS: LATAH GLEN RESIDENTIAL

CALL BEFORE YOU DIG 1-800-424-5555

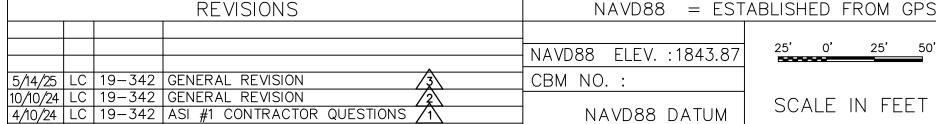

NAVD88 ELEV. :1843.87 SCALE IN FEET NAVD88 DATUM

BENCH MARK LOCATION: 5/8" REBAR WITH PLASTIC CAP PLS 48373 AT THE SOUTHEAST PROPERTY CORNER HORIZONTAL SCALE (22 x 34) VERTICAL SCALE (22 x 34)

TOP OF GRATE

LMC 3/3/2023 DRAWN: JDS 01/19/2024

CURB INLET -

IS ACHIEVED

PLAN

DETAIL

3/4-INCH GRAVEL


/4-INCH MESH


OR BURLAP


PLACE FILTER FABRIC UNDER


GRATE UNTIL FINAL STABILIZATION


WADDLE (TYP.) -

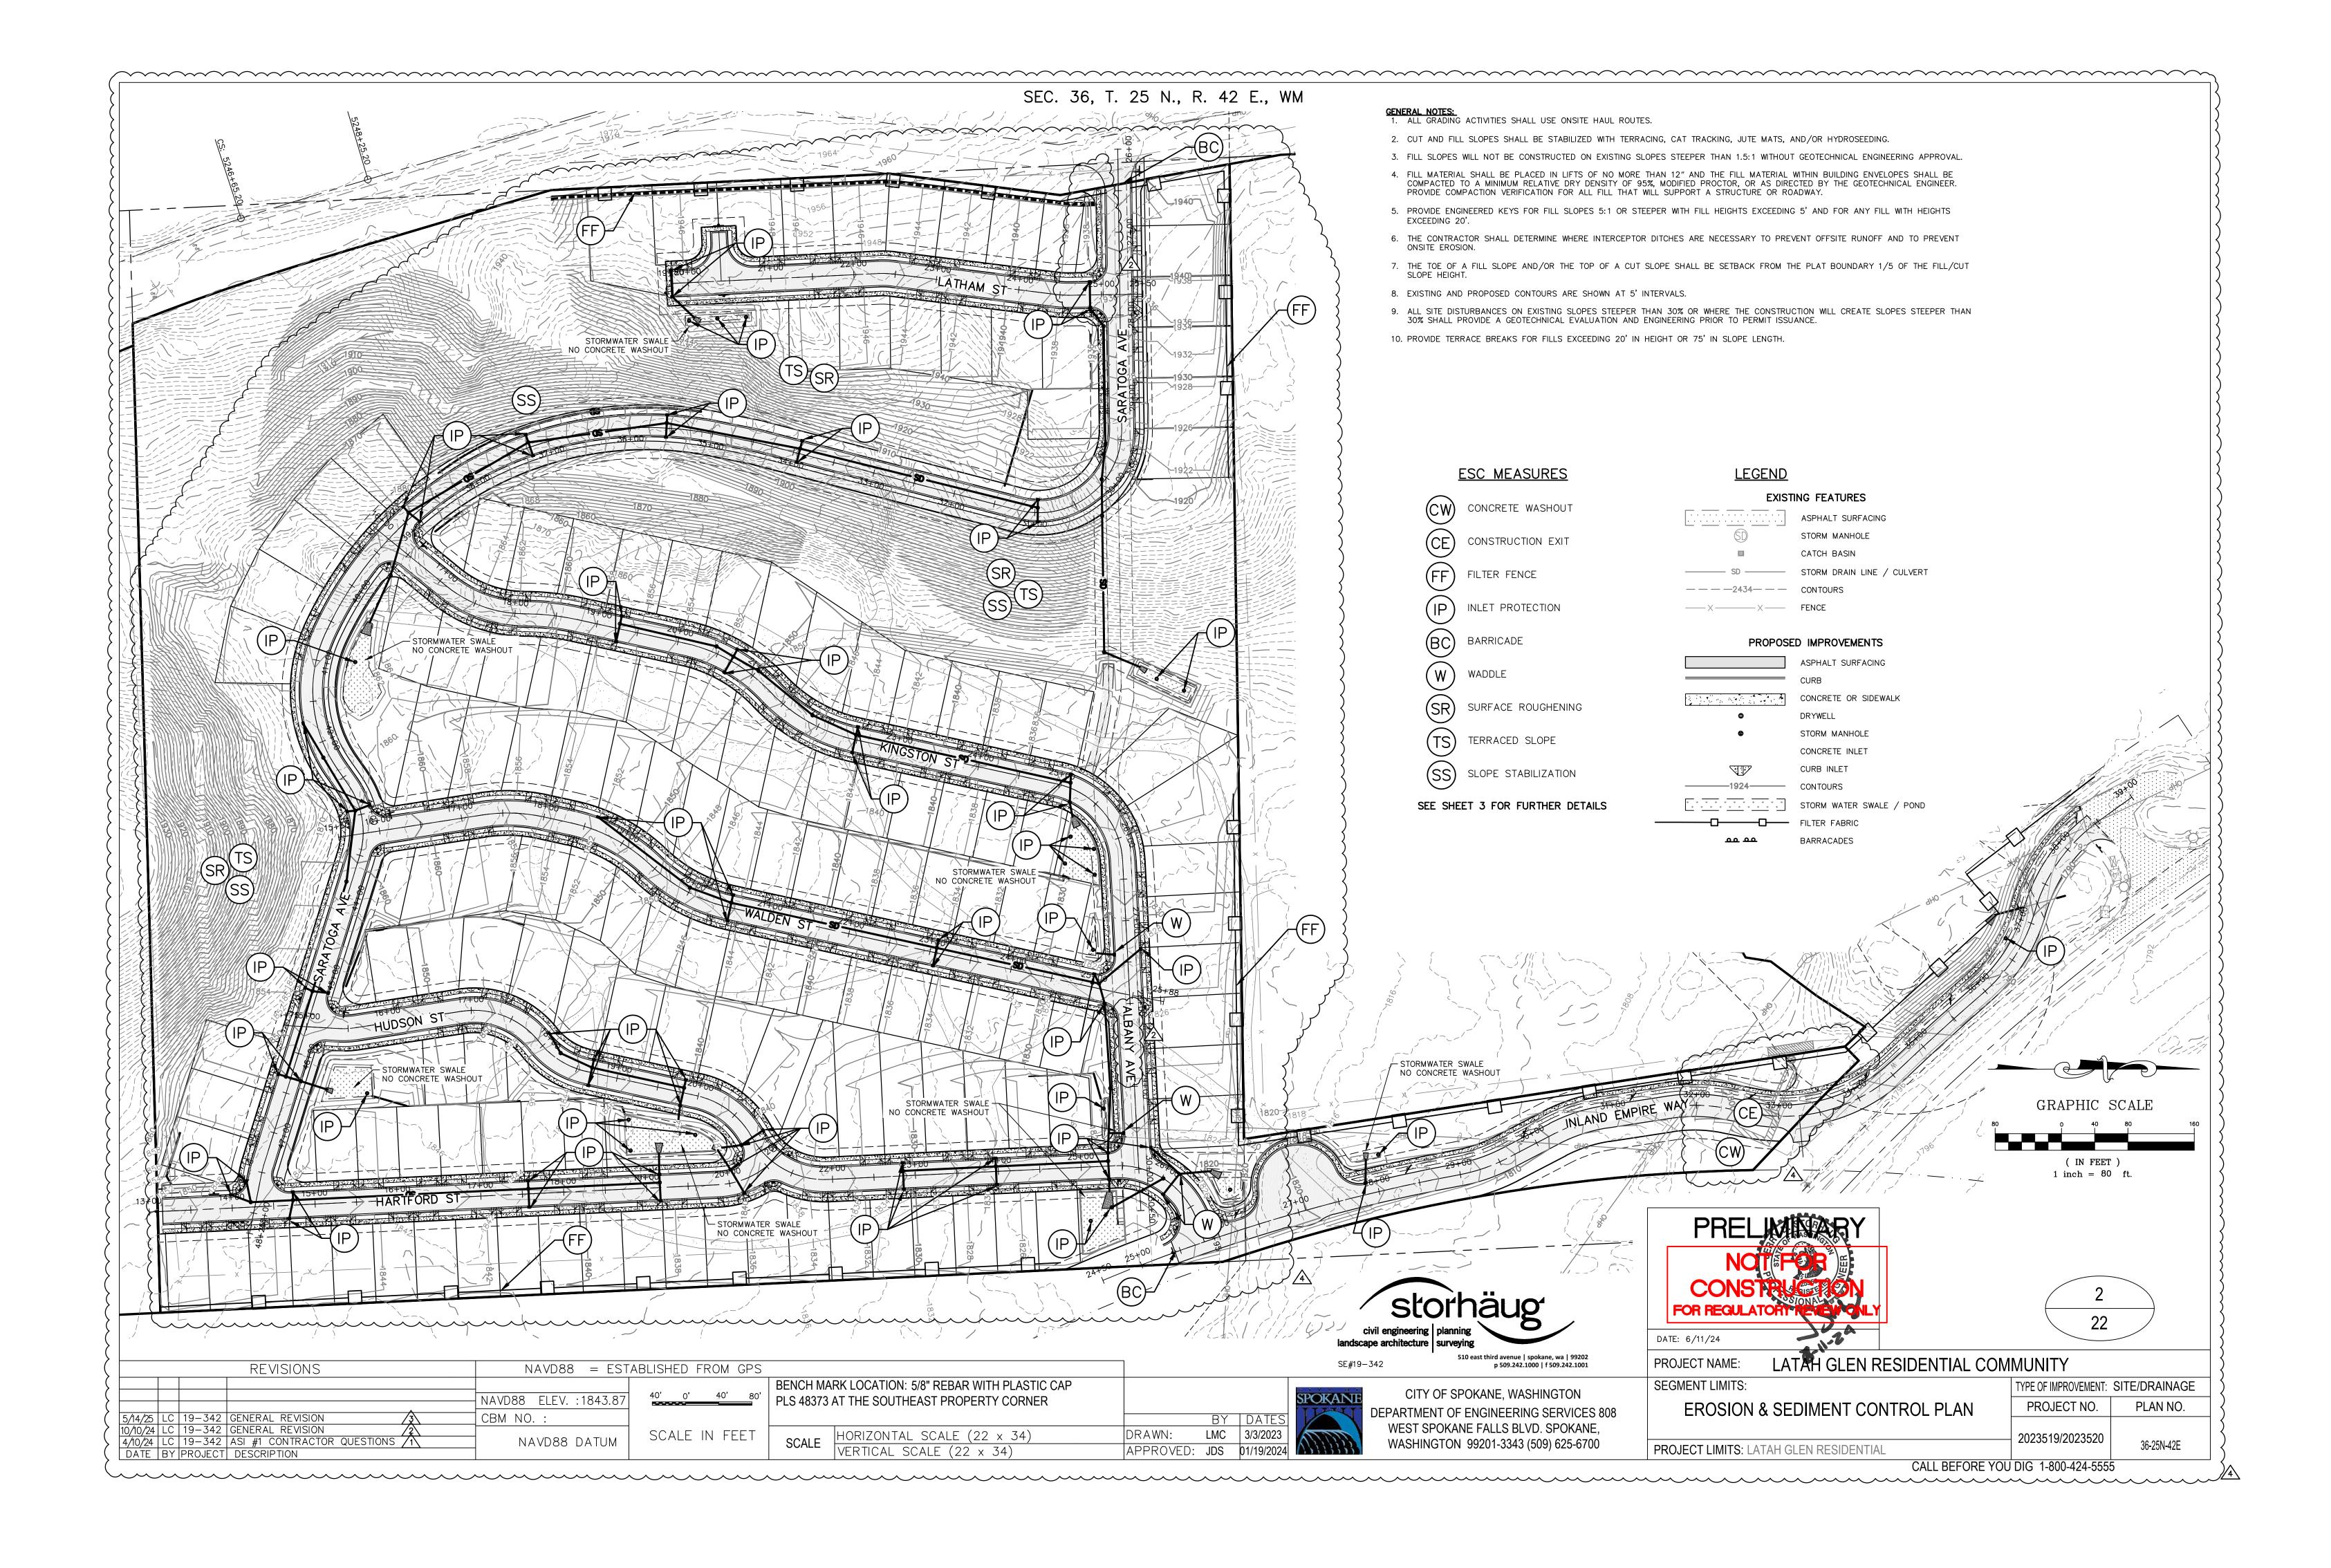


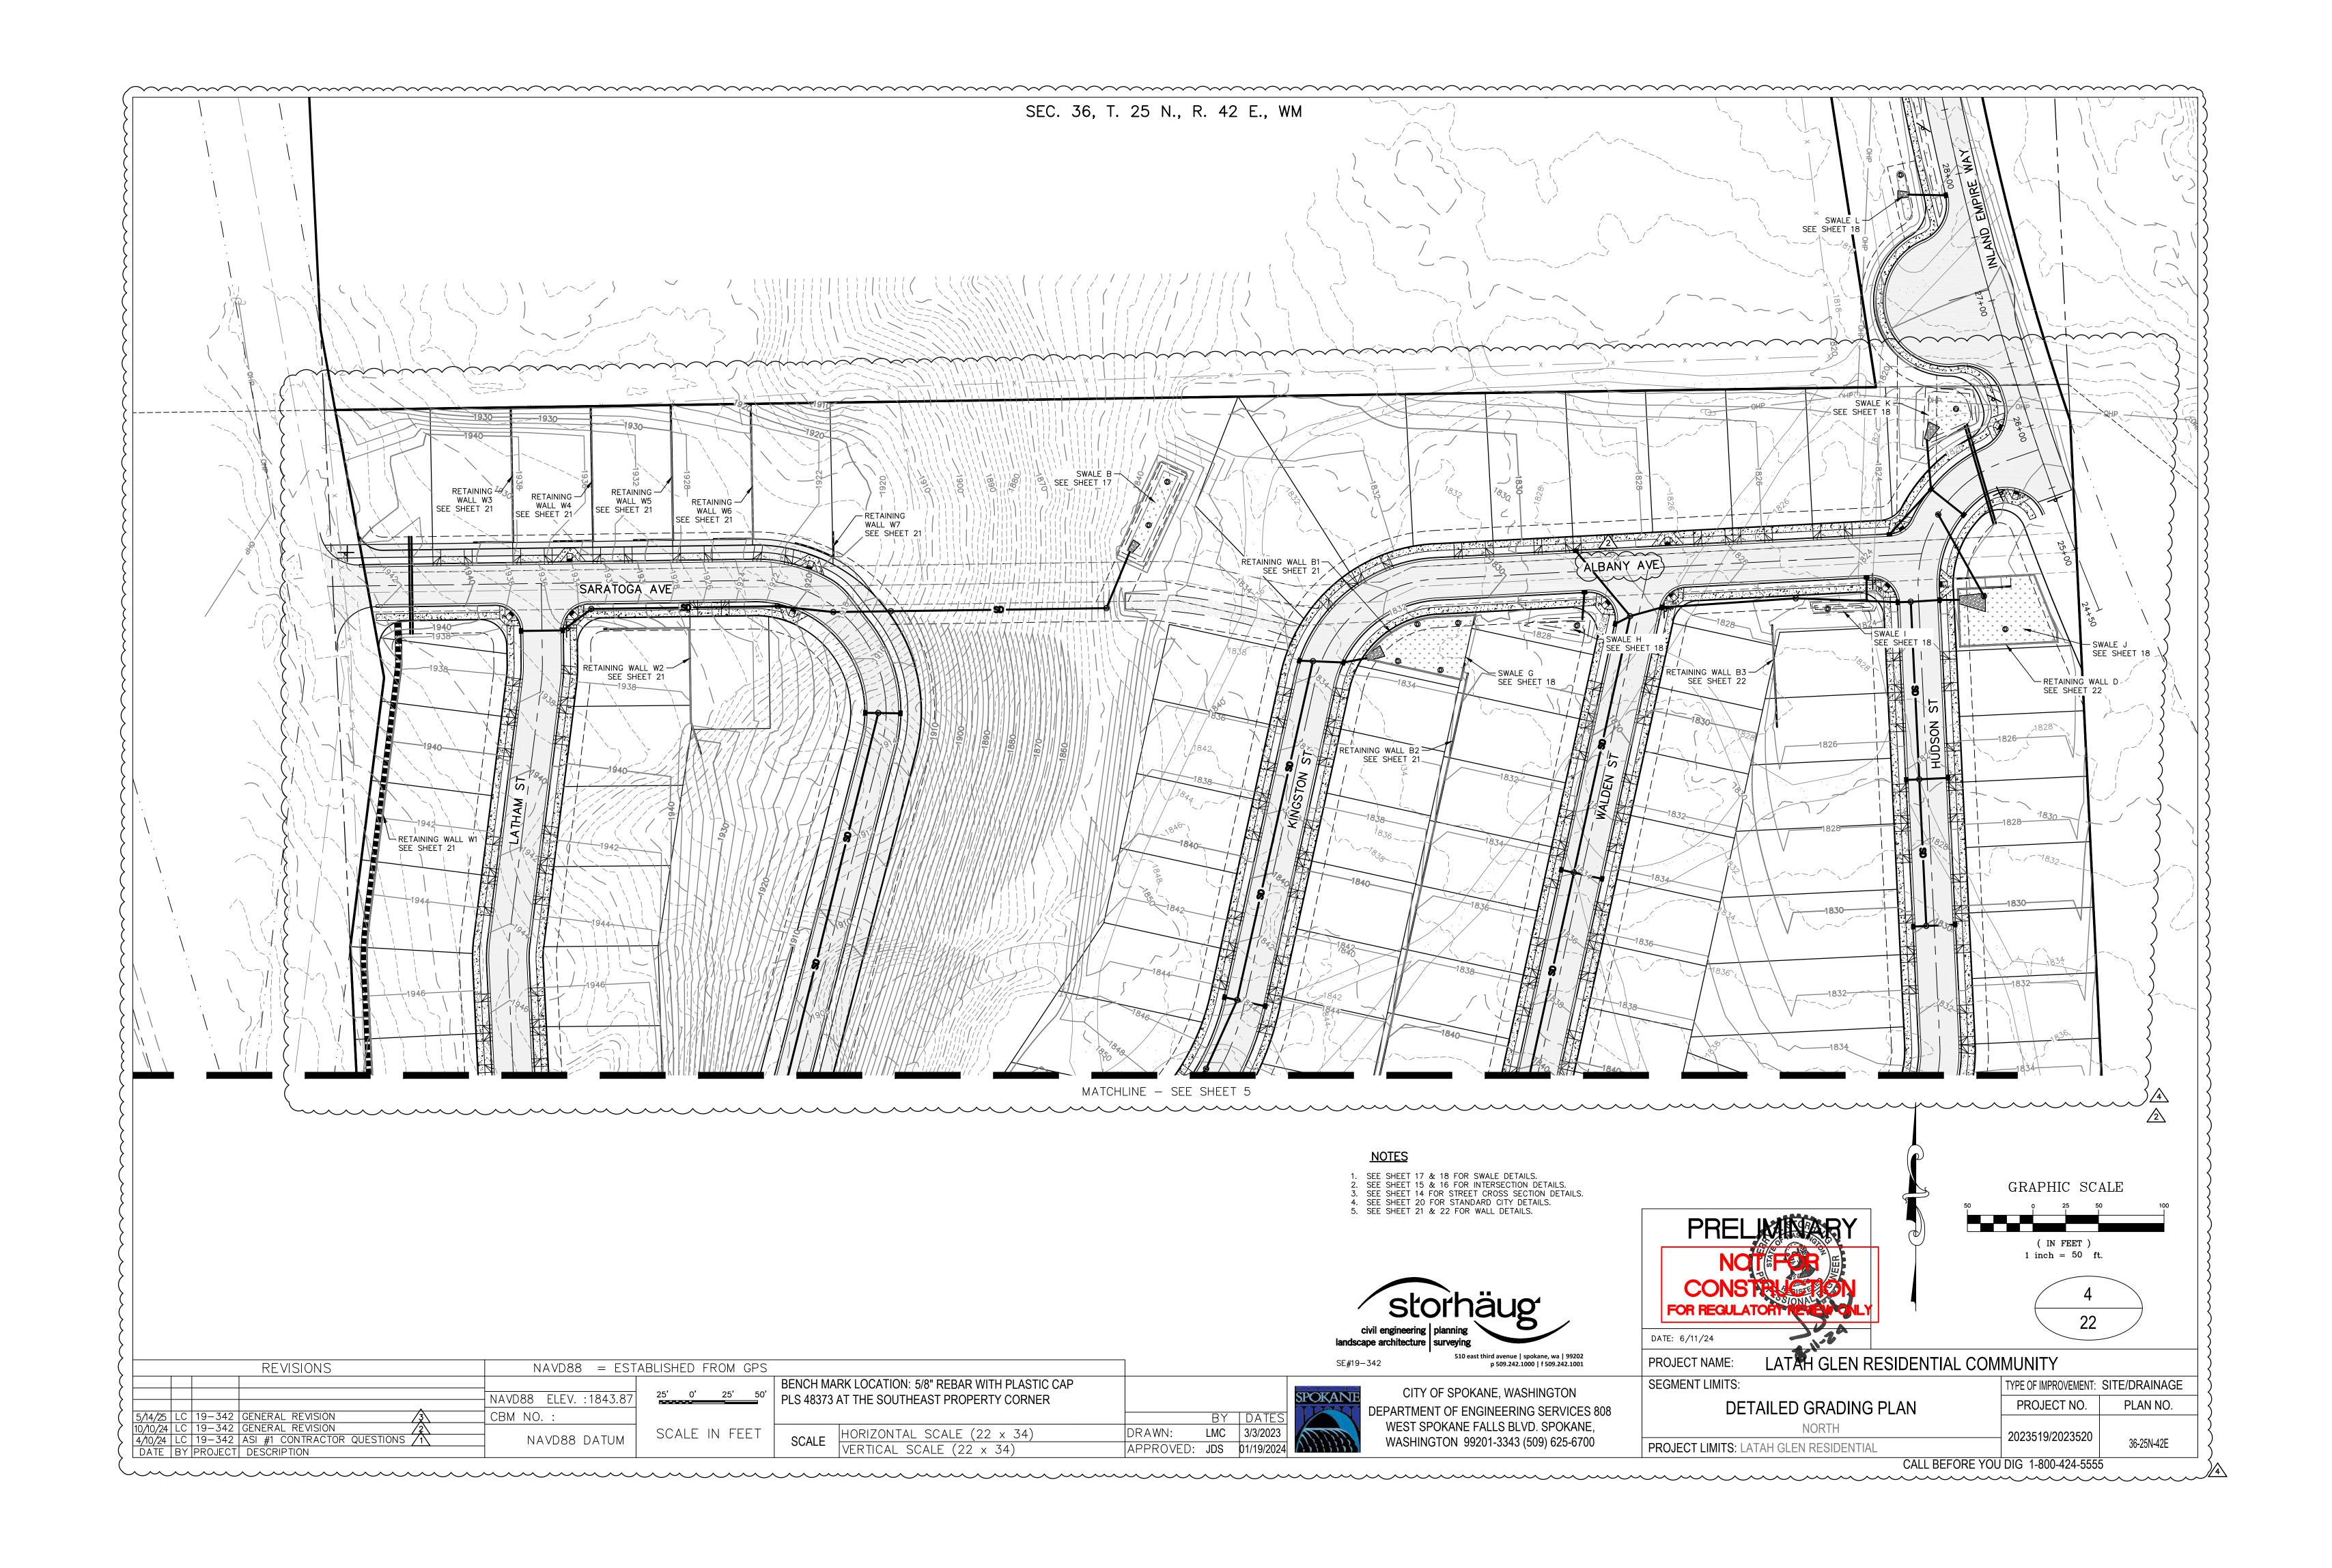


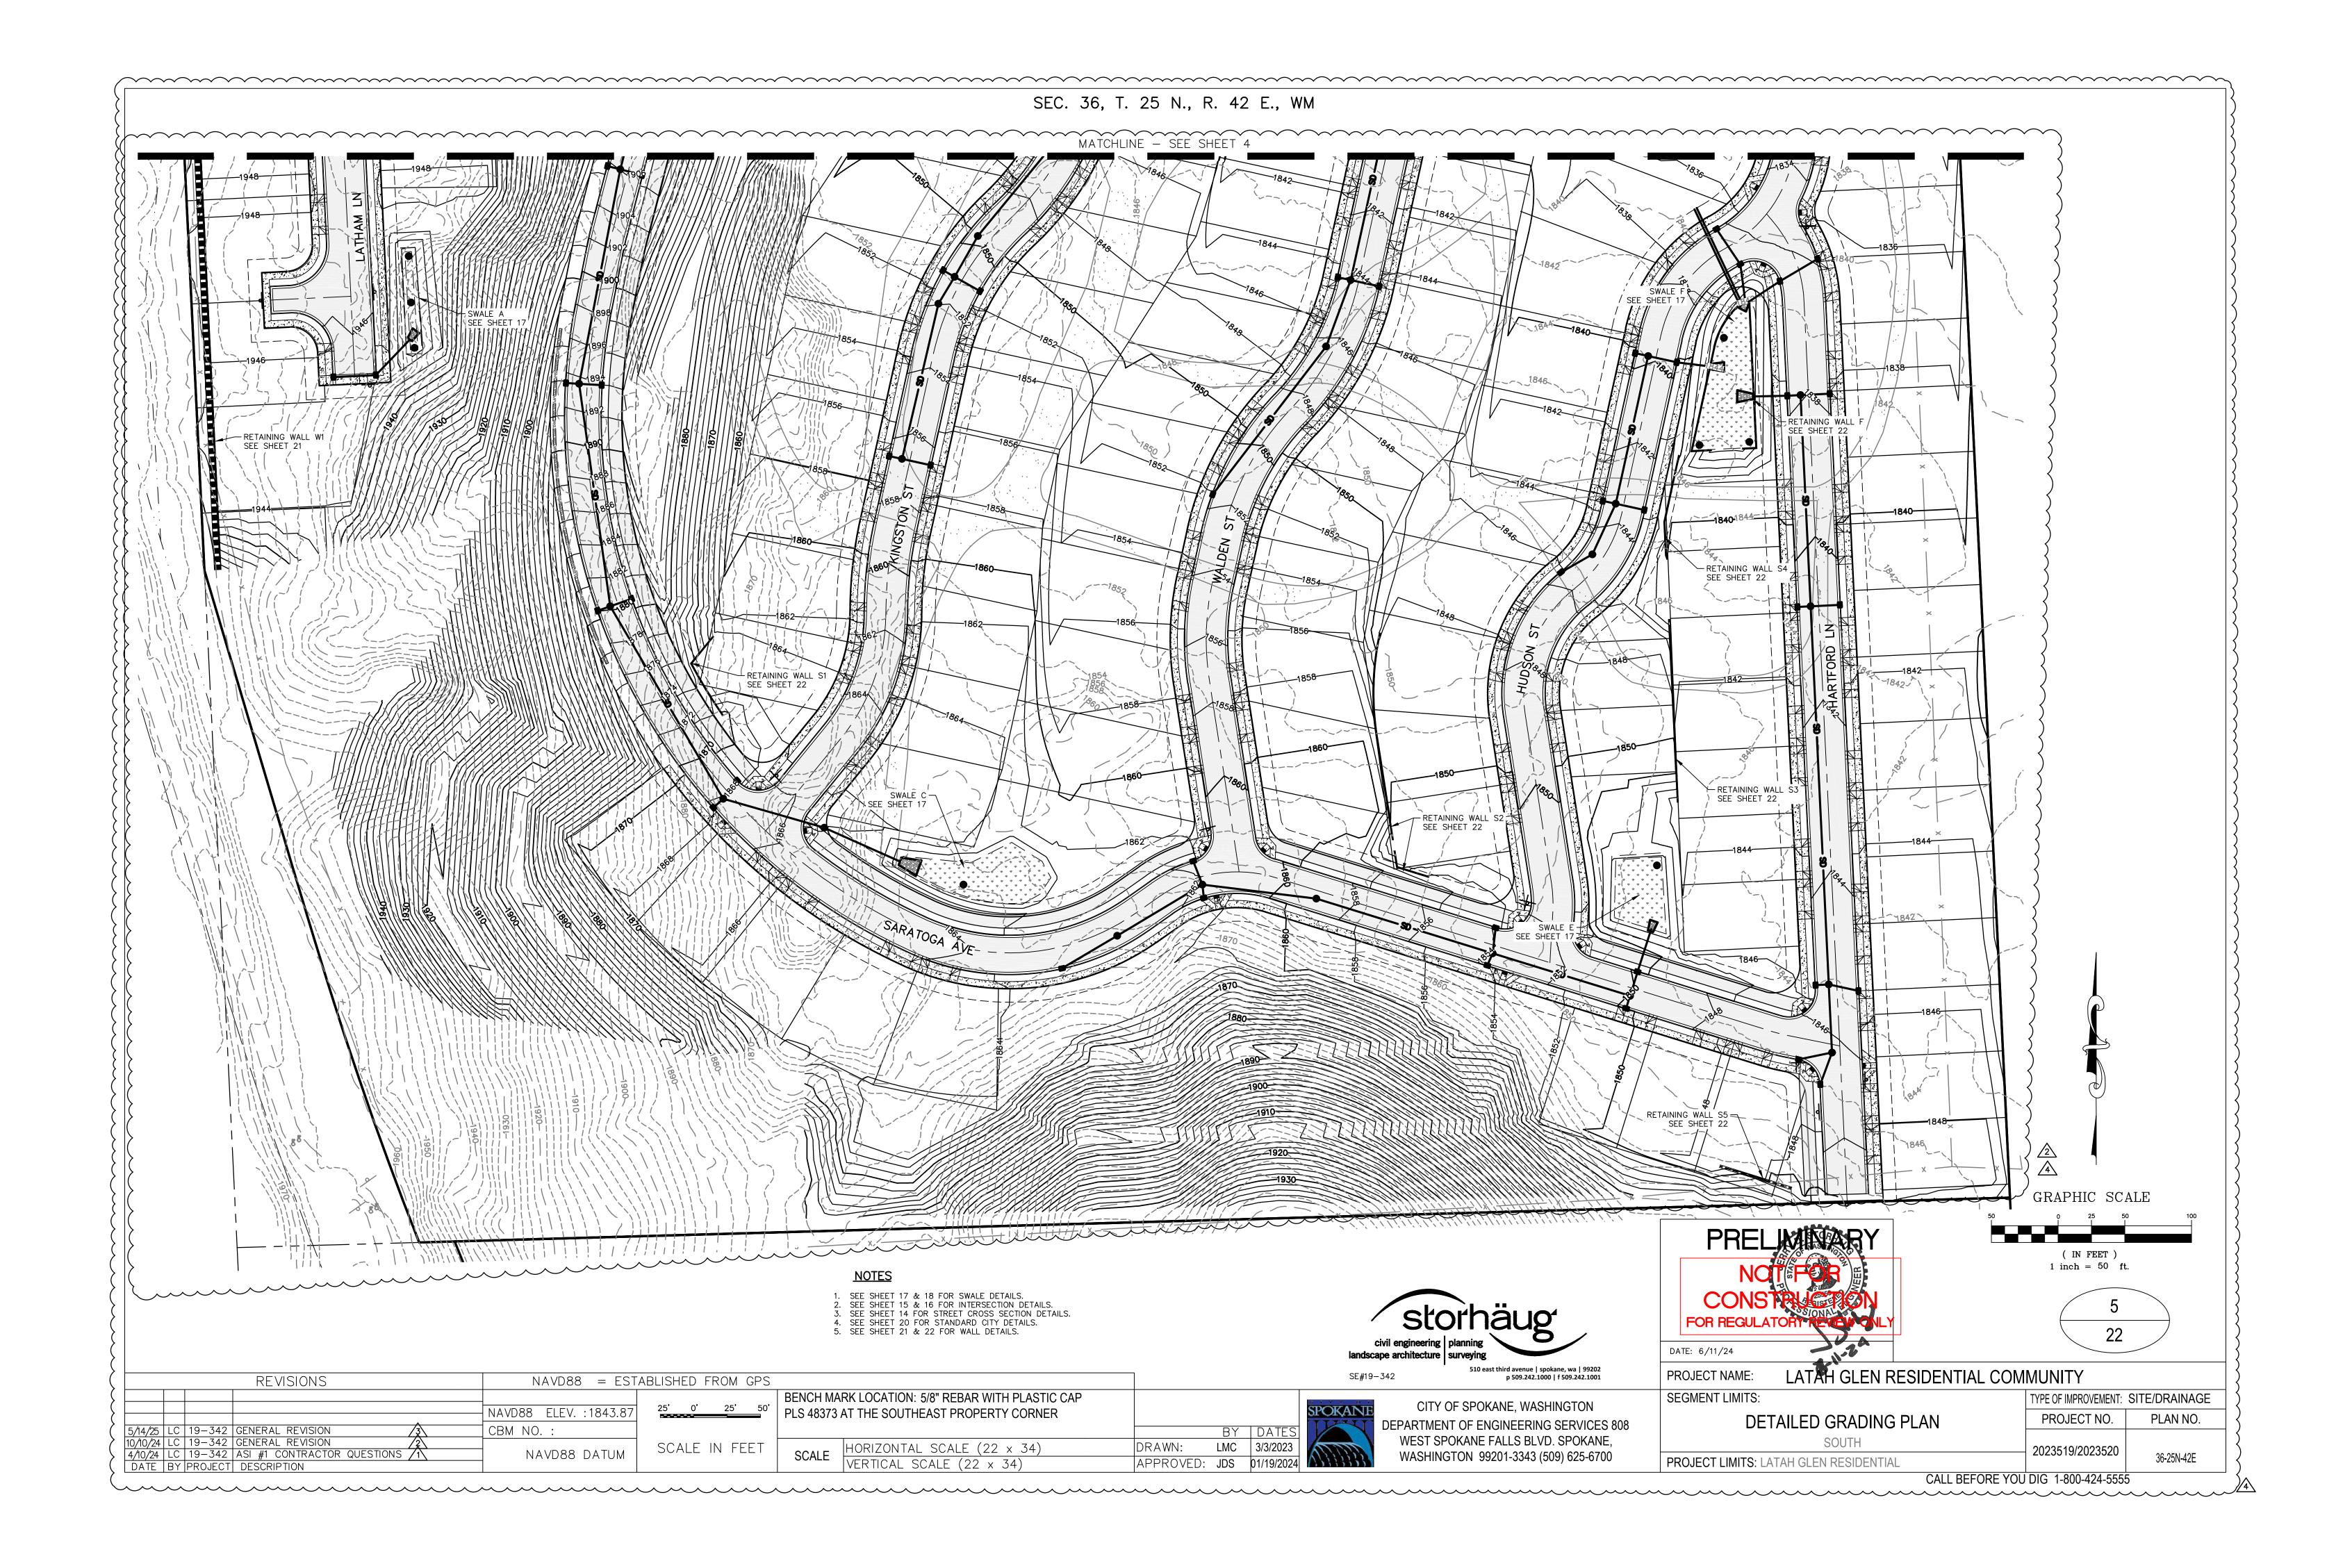


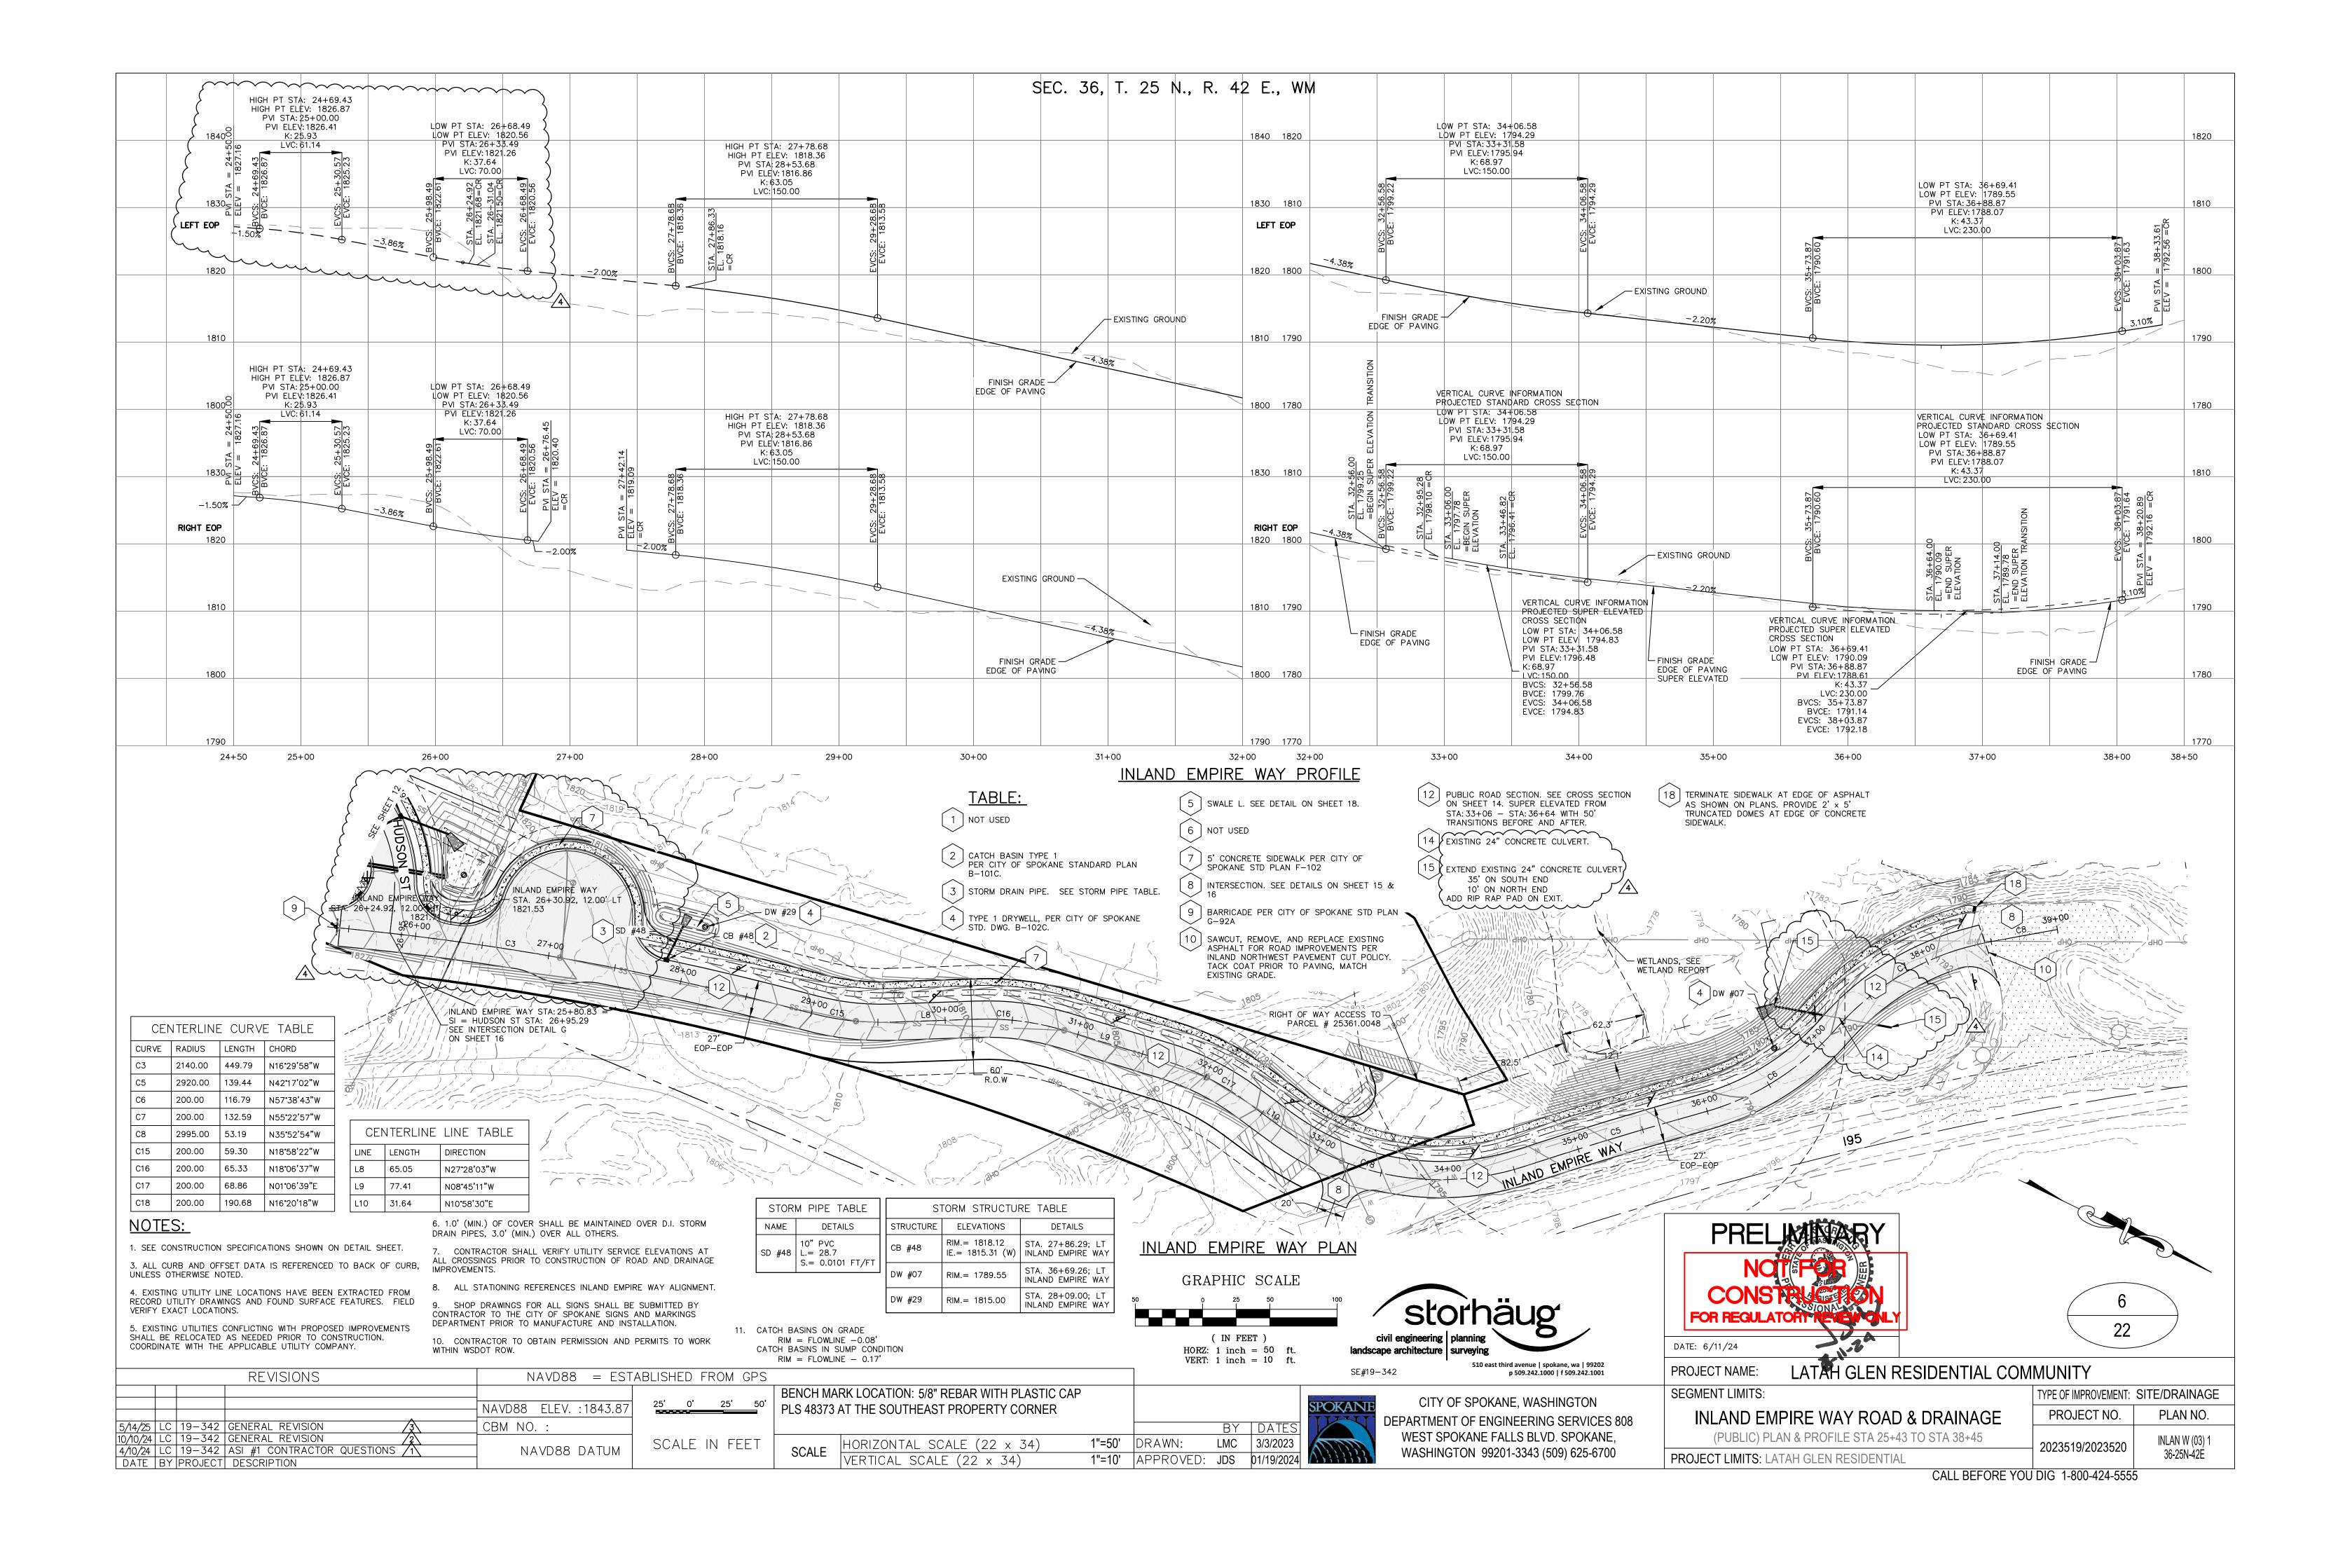


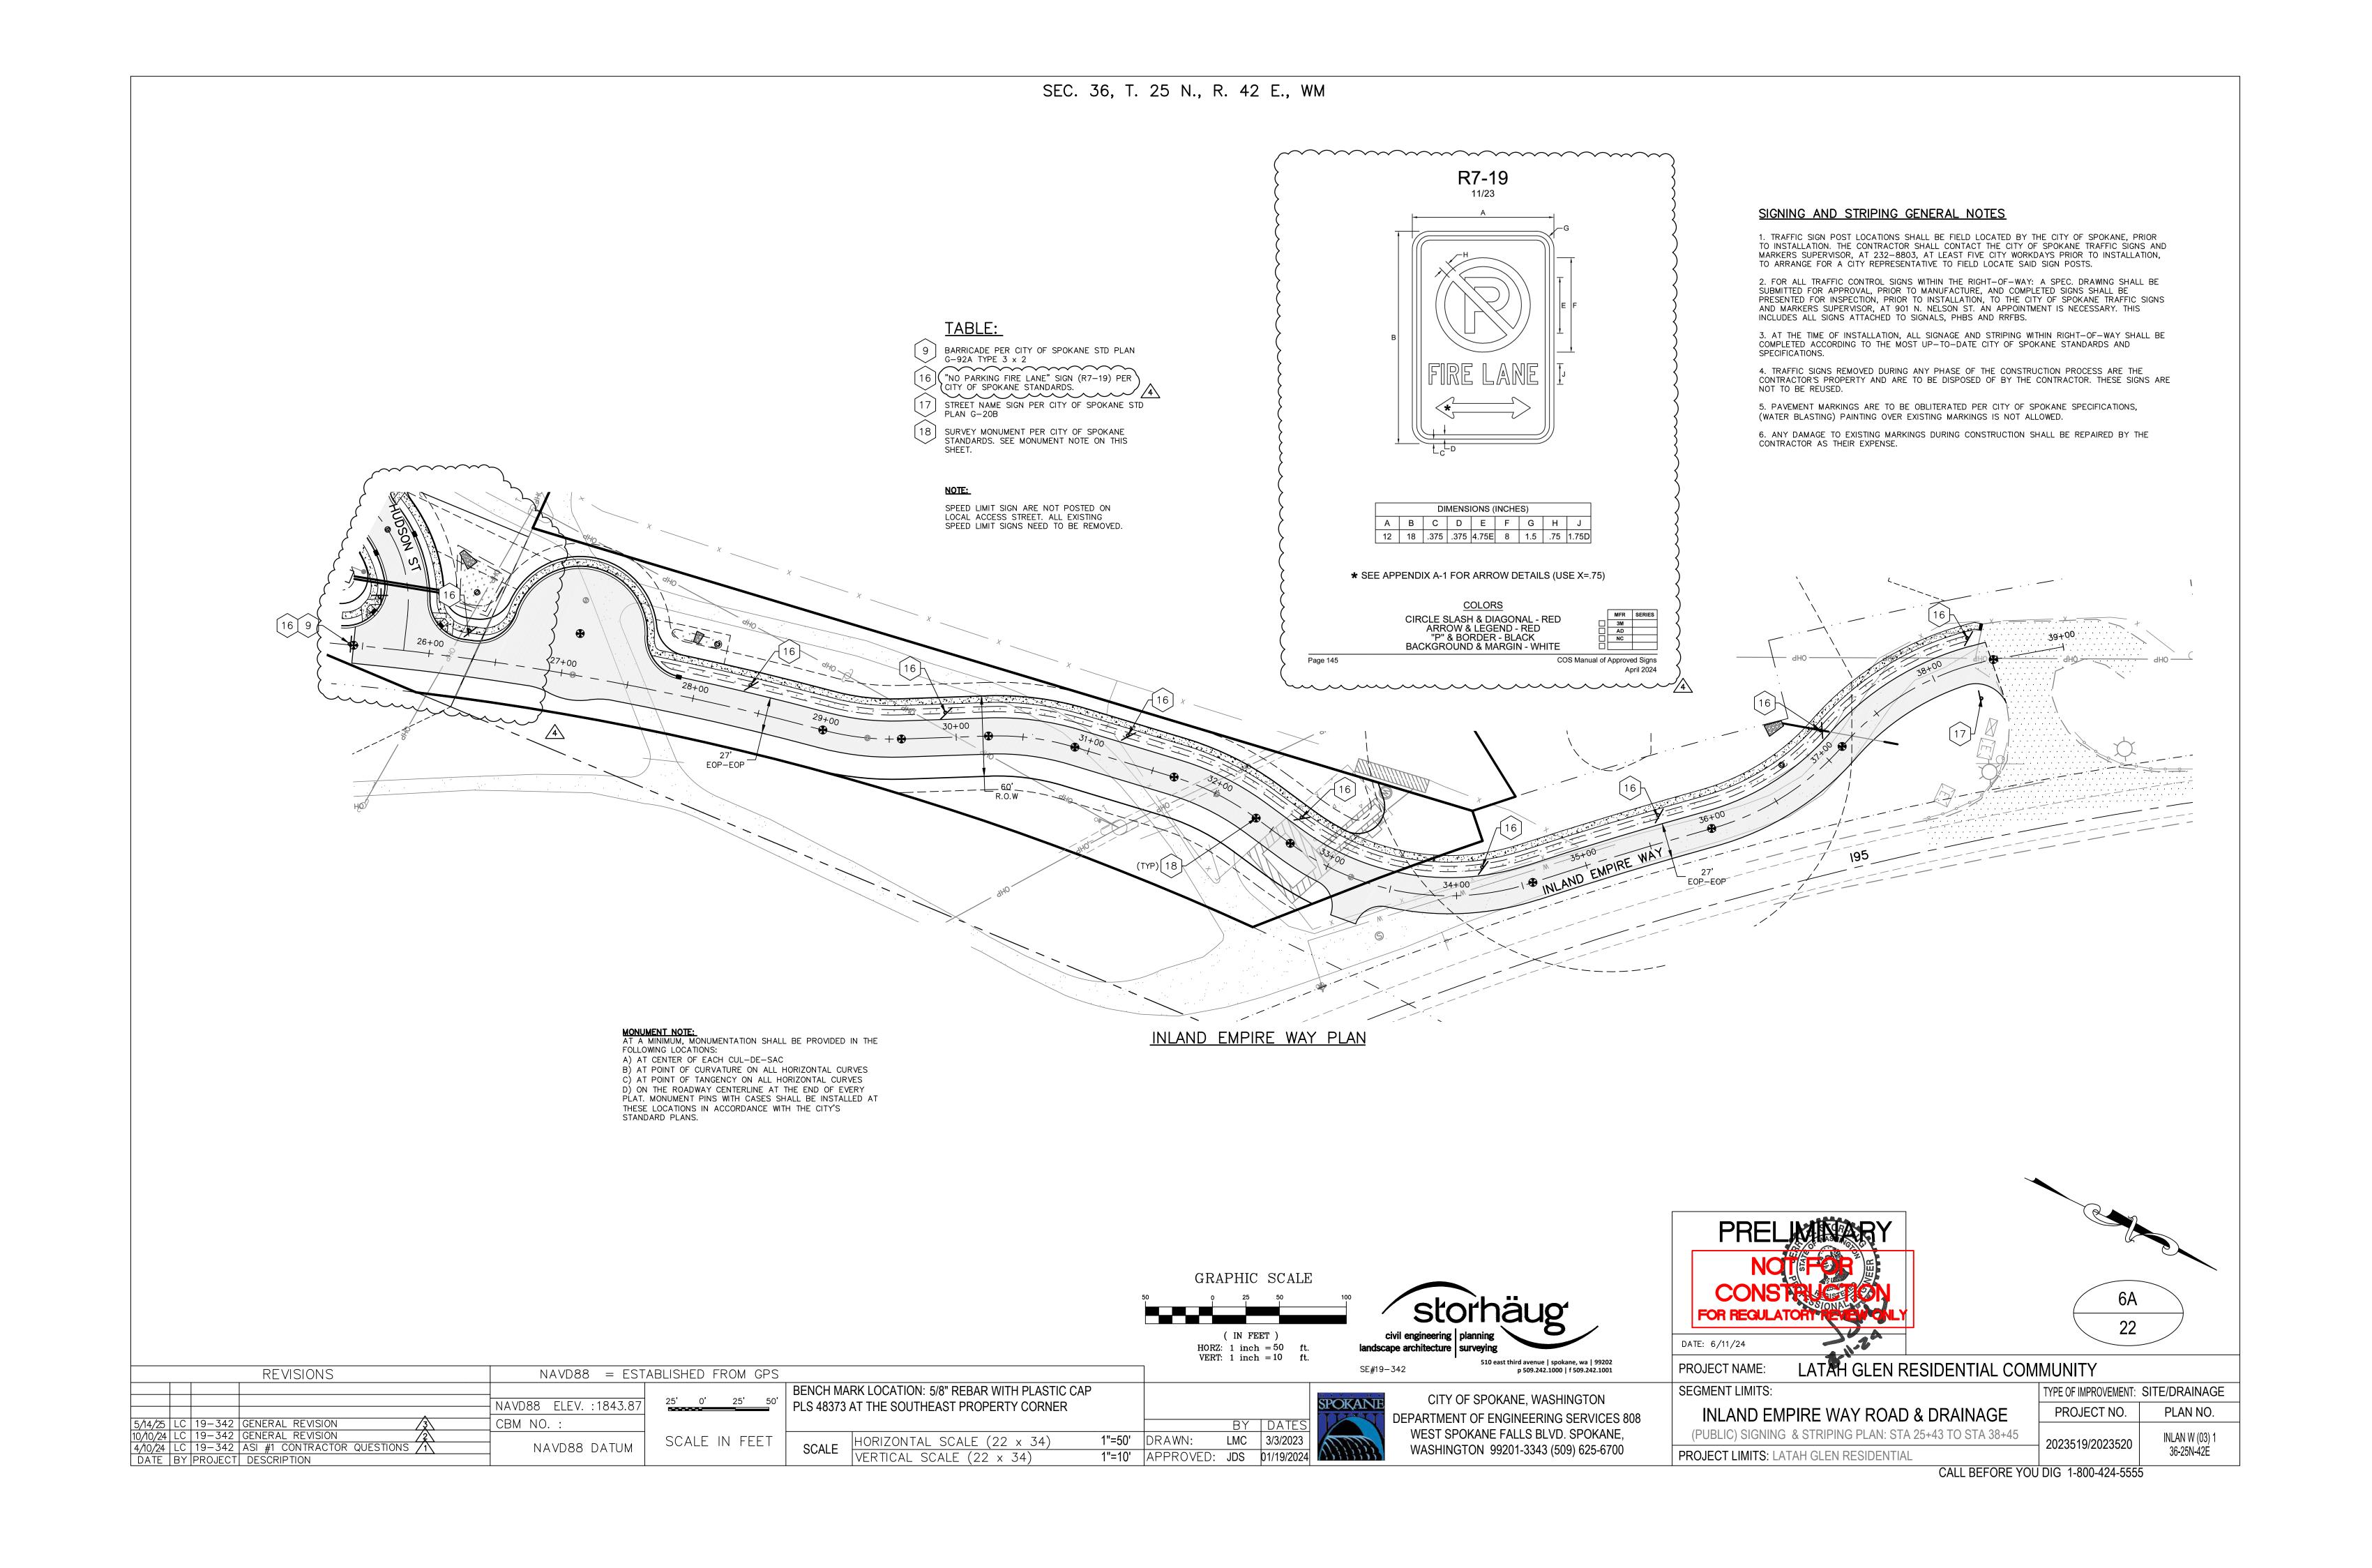


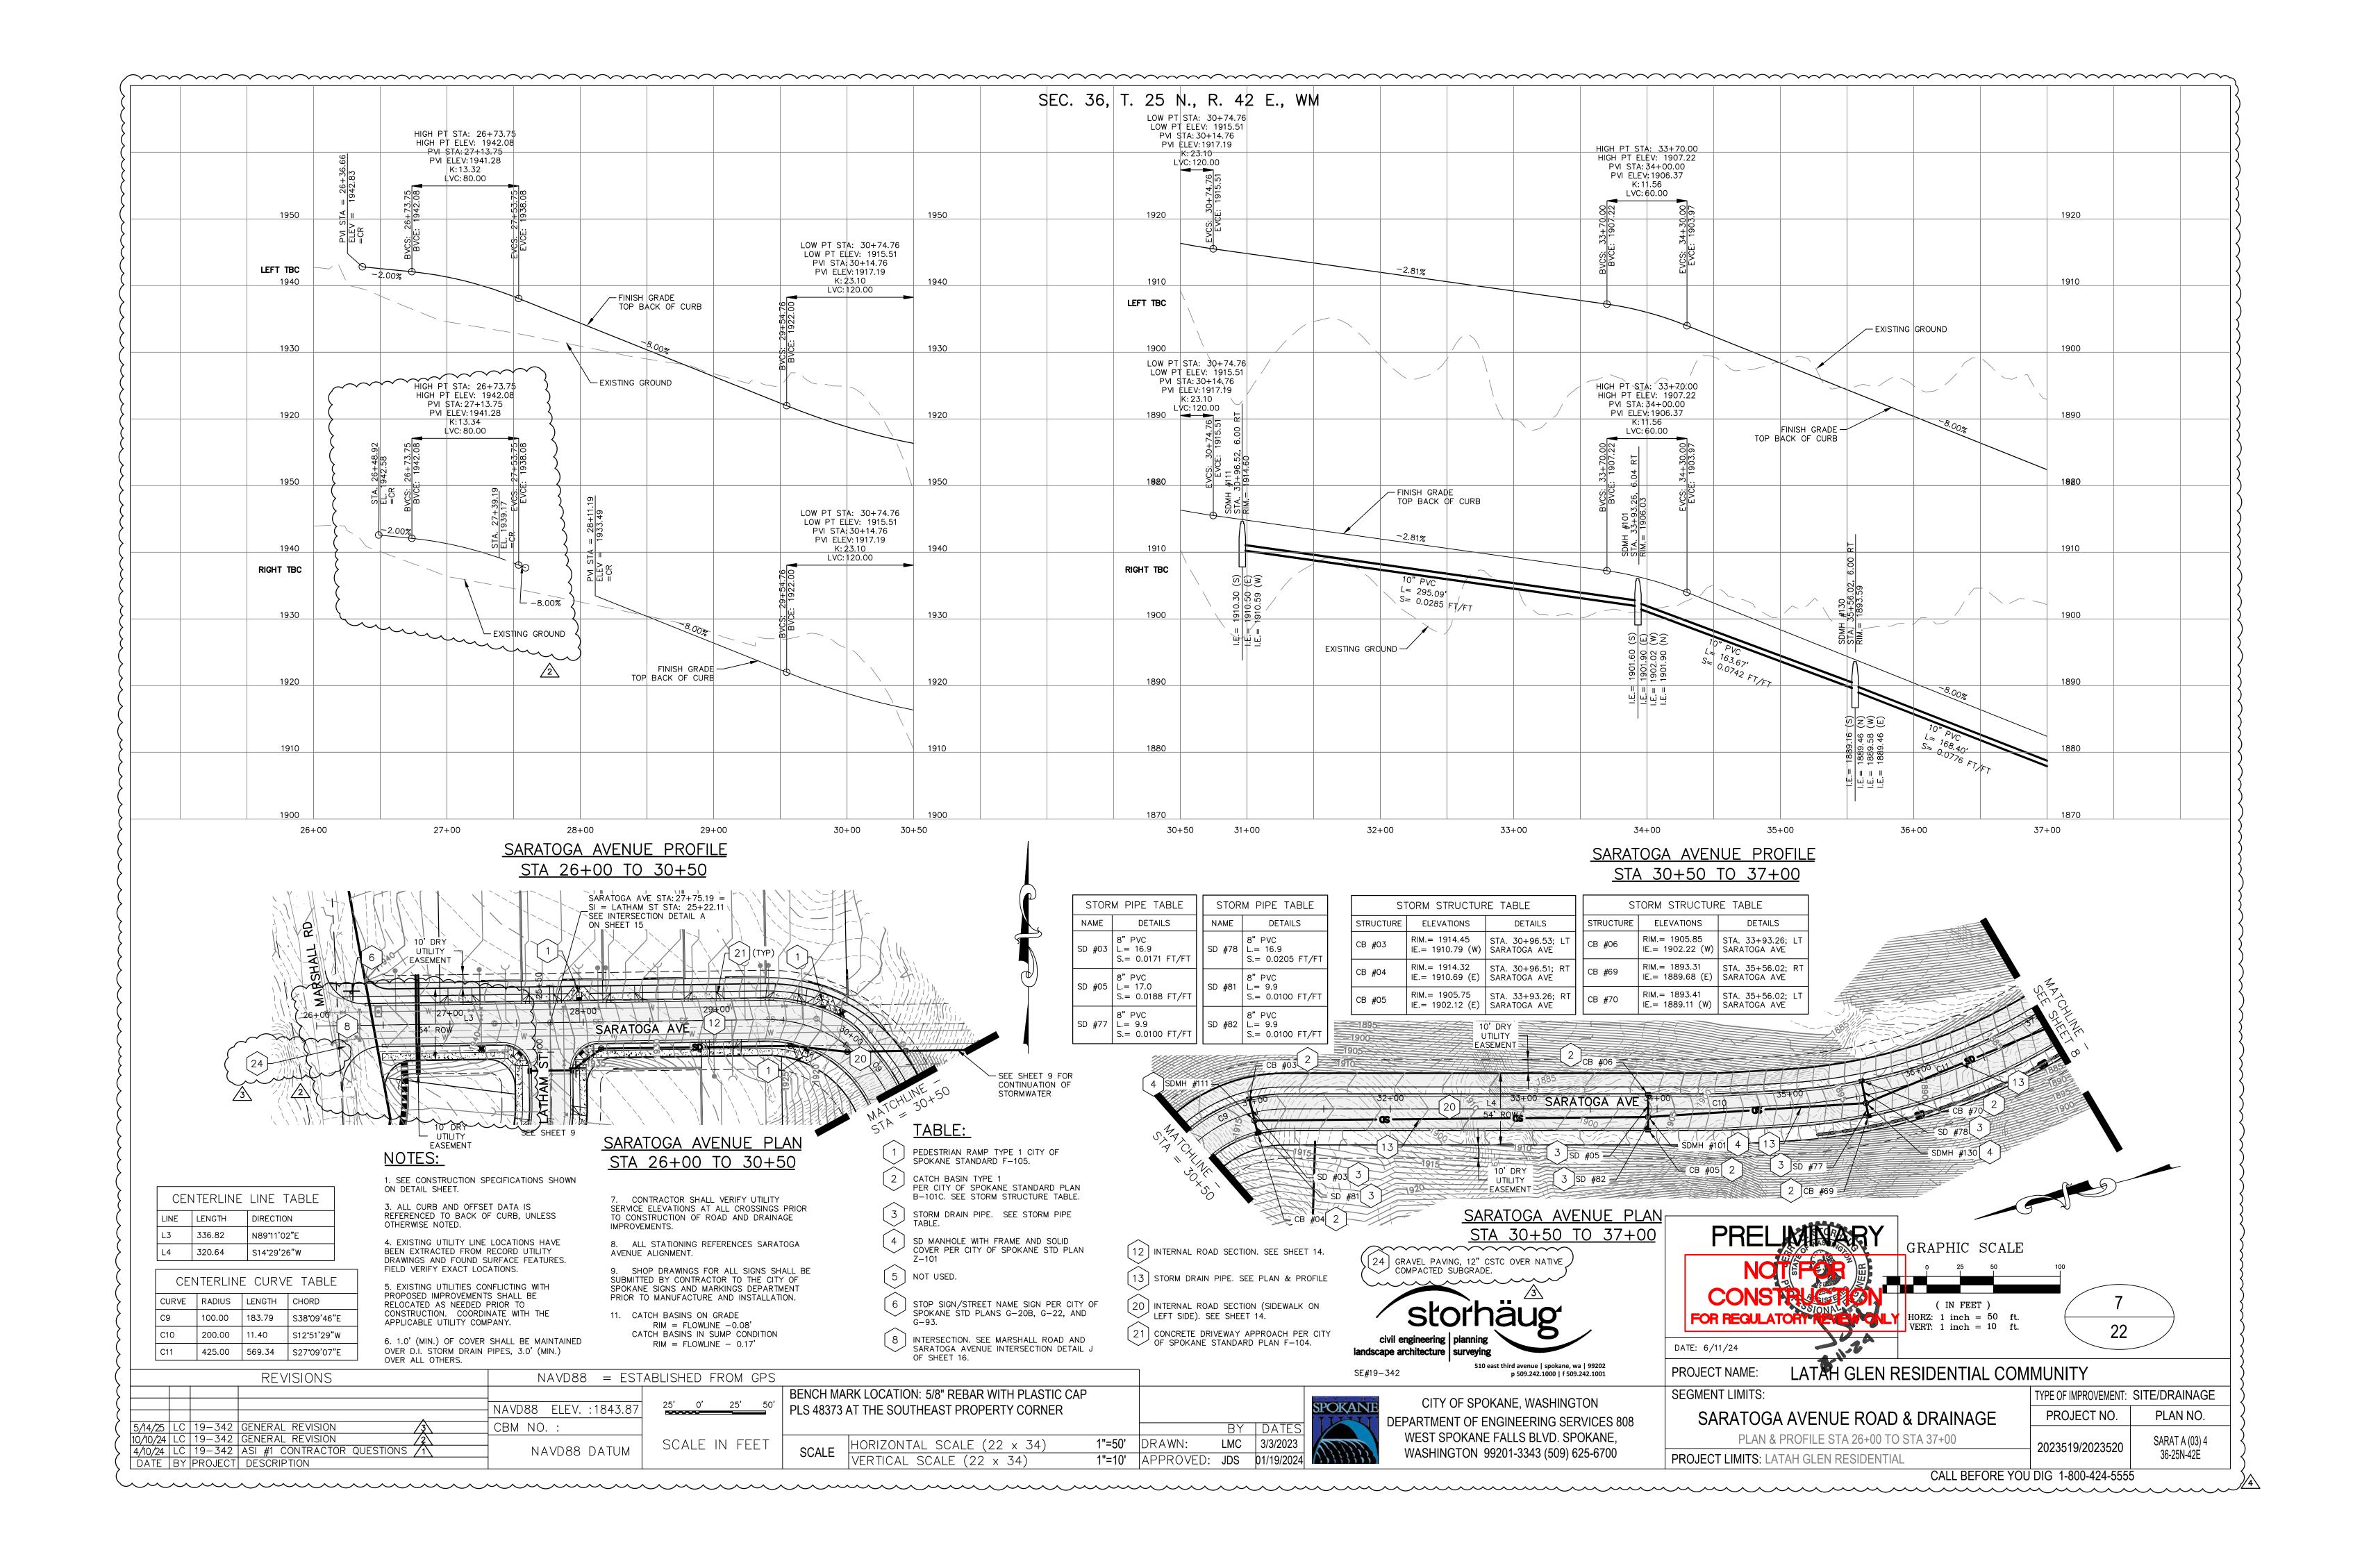


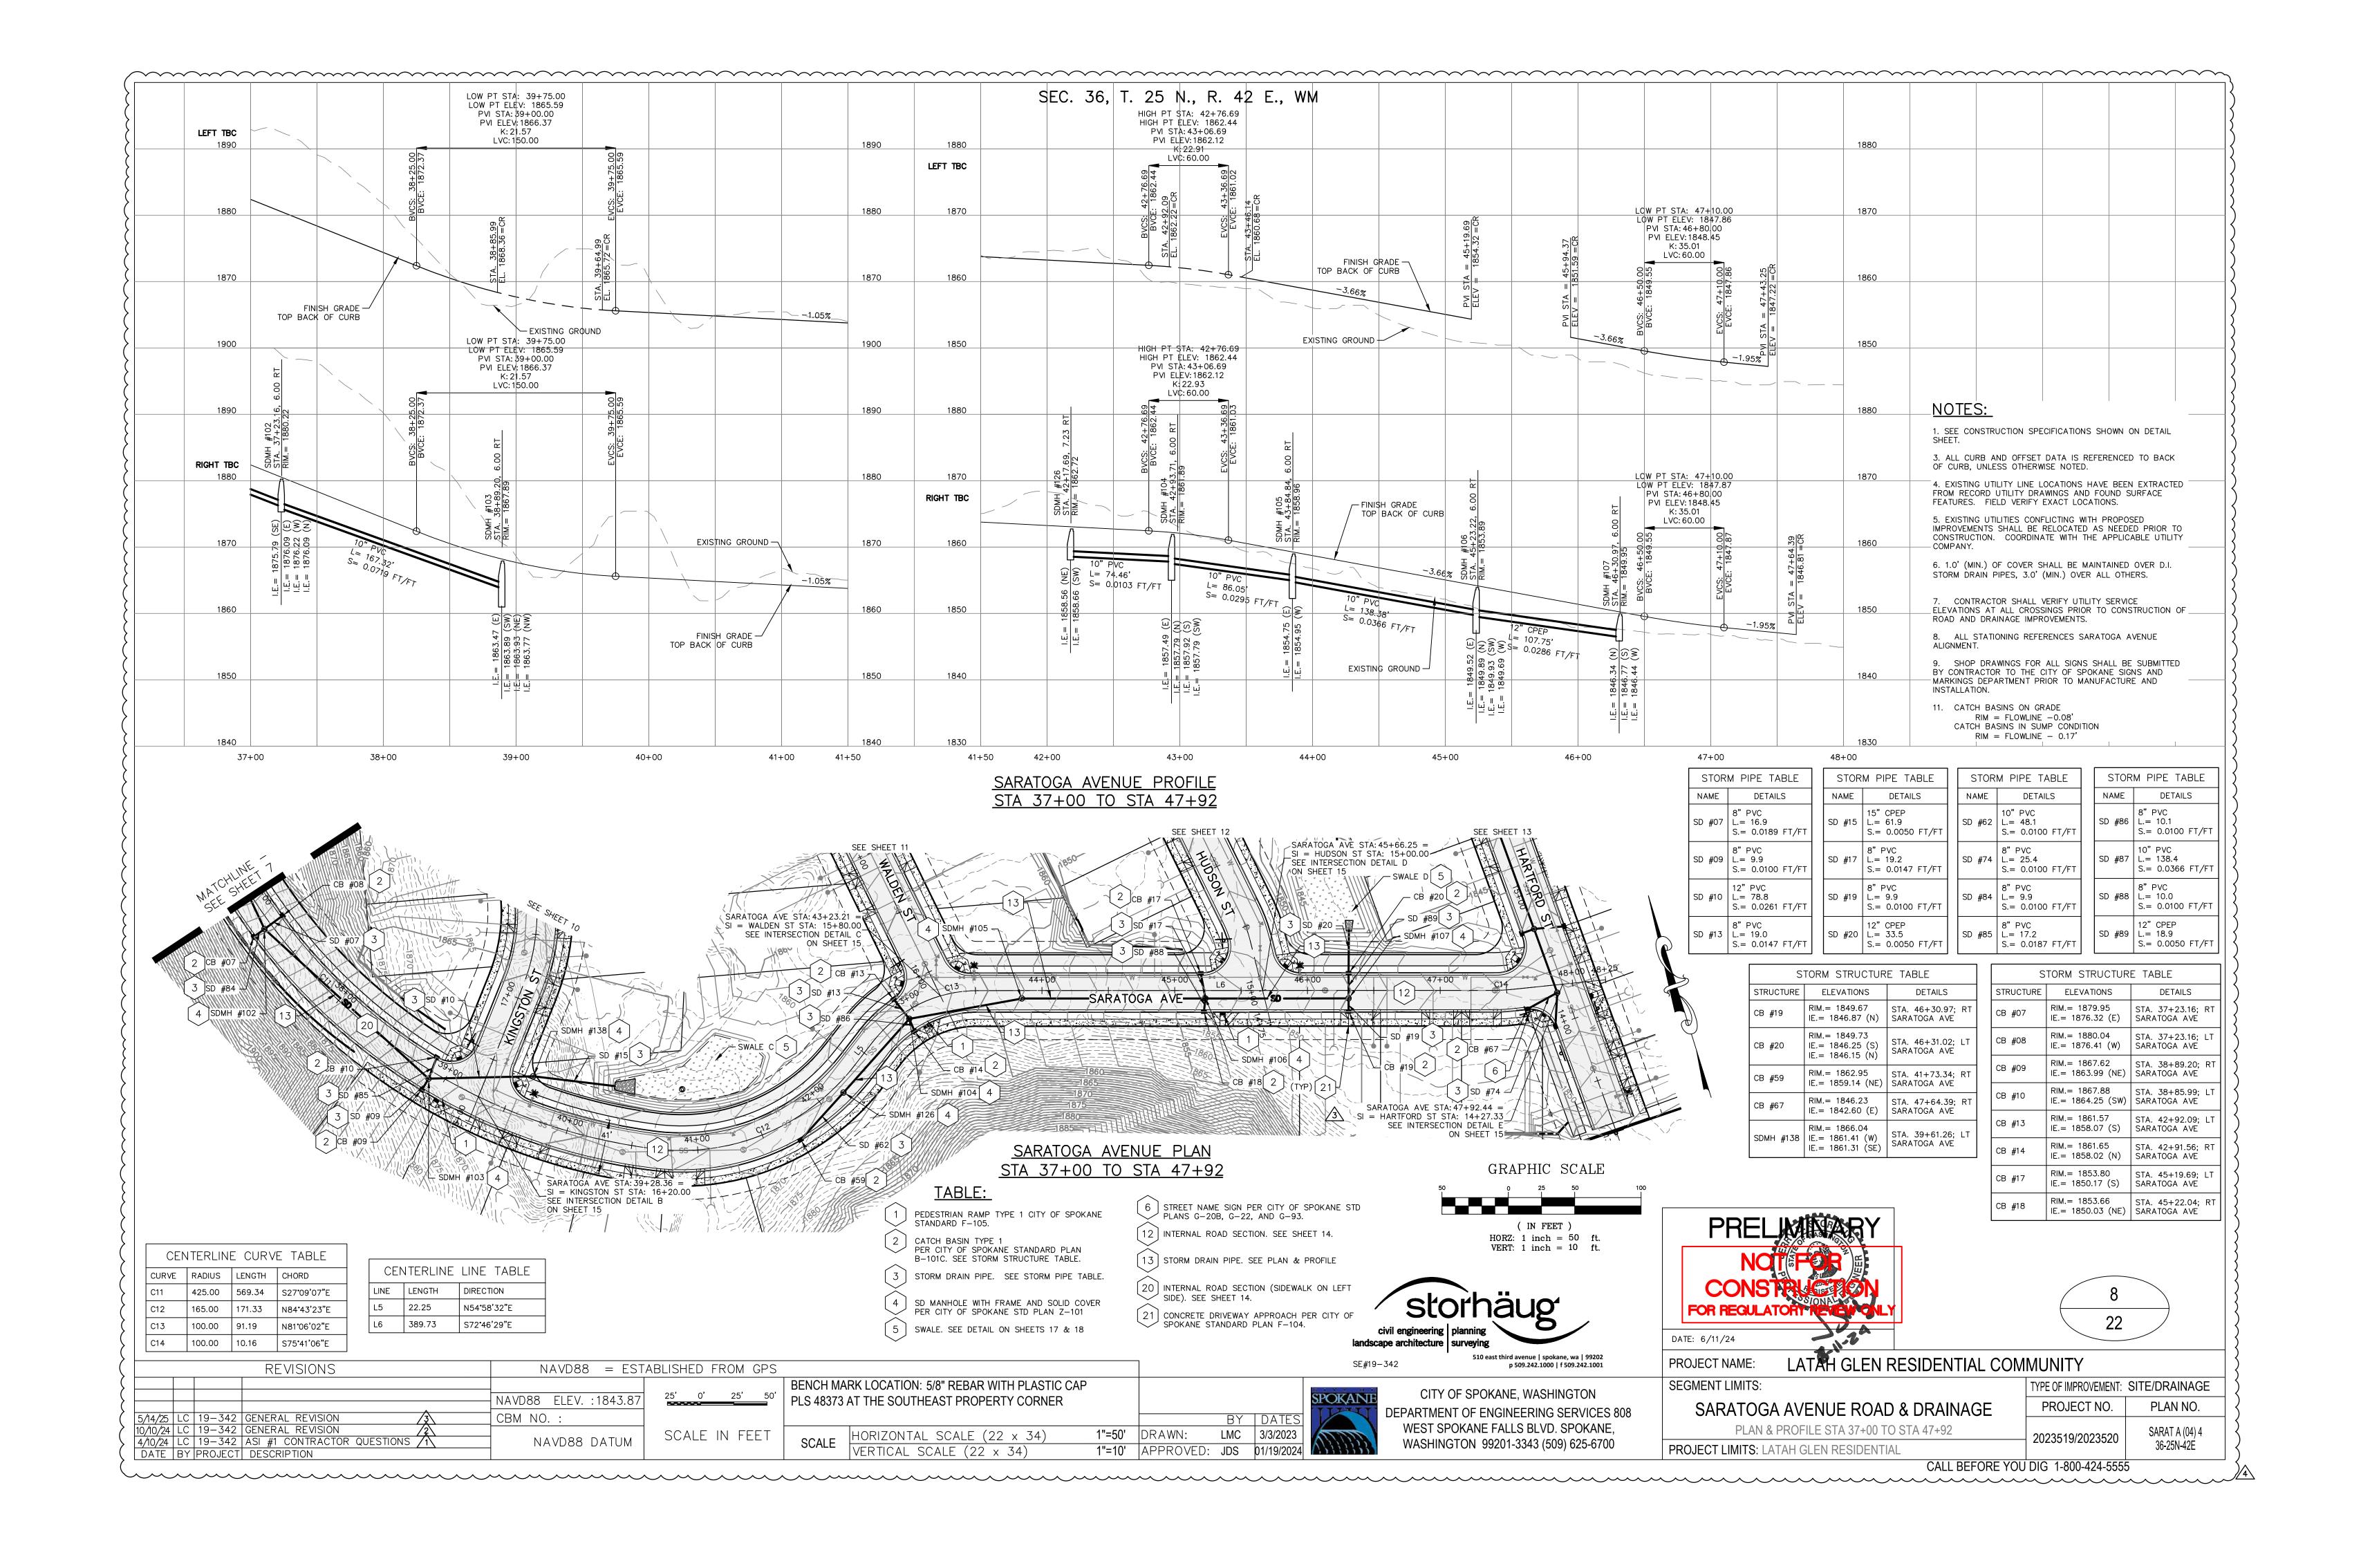


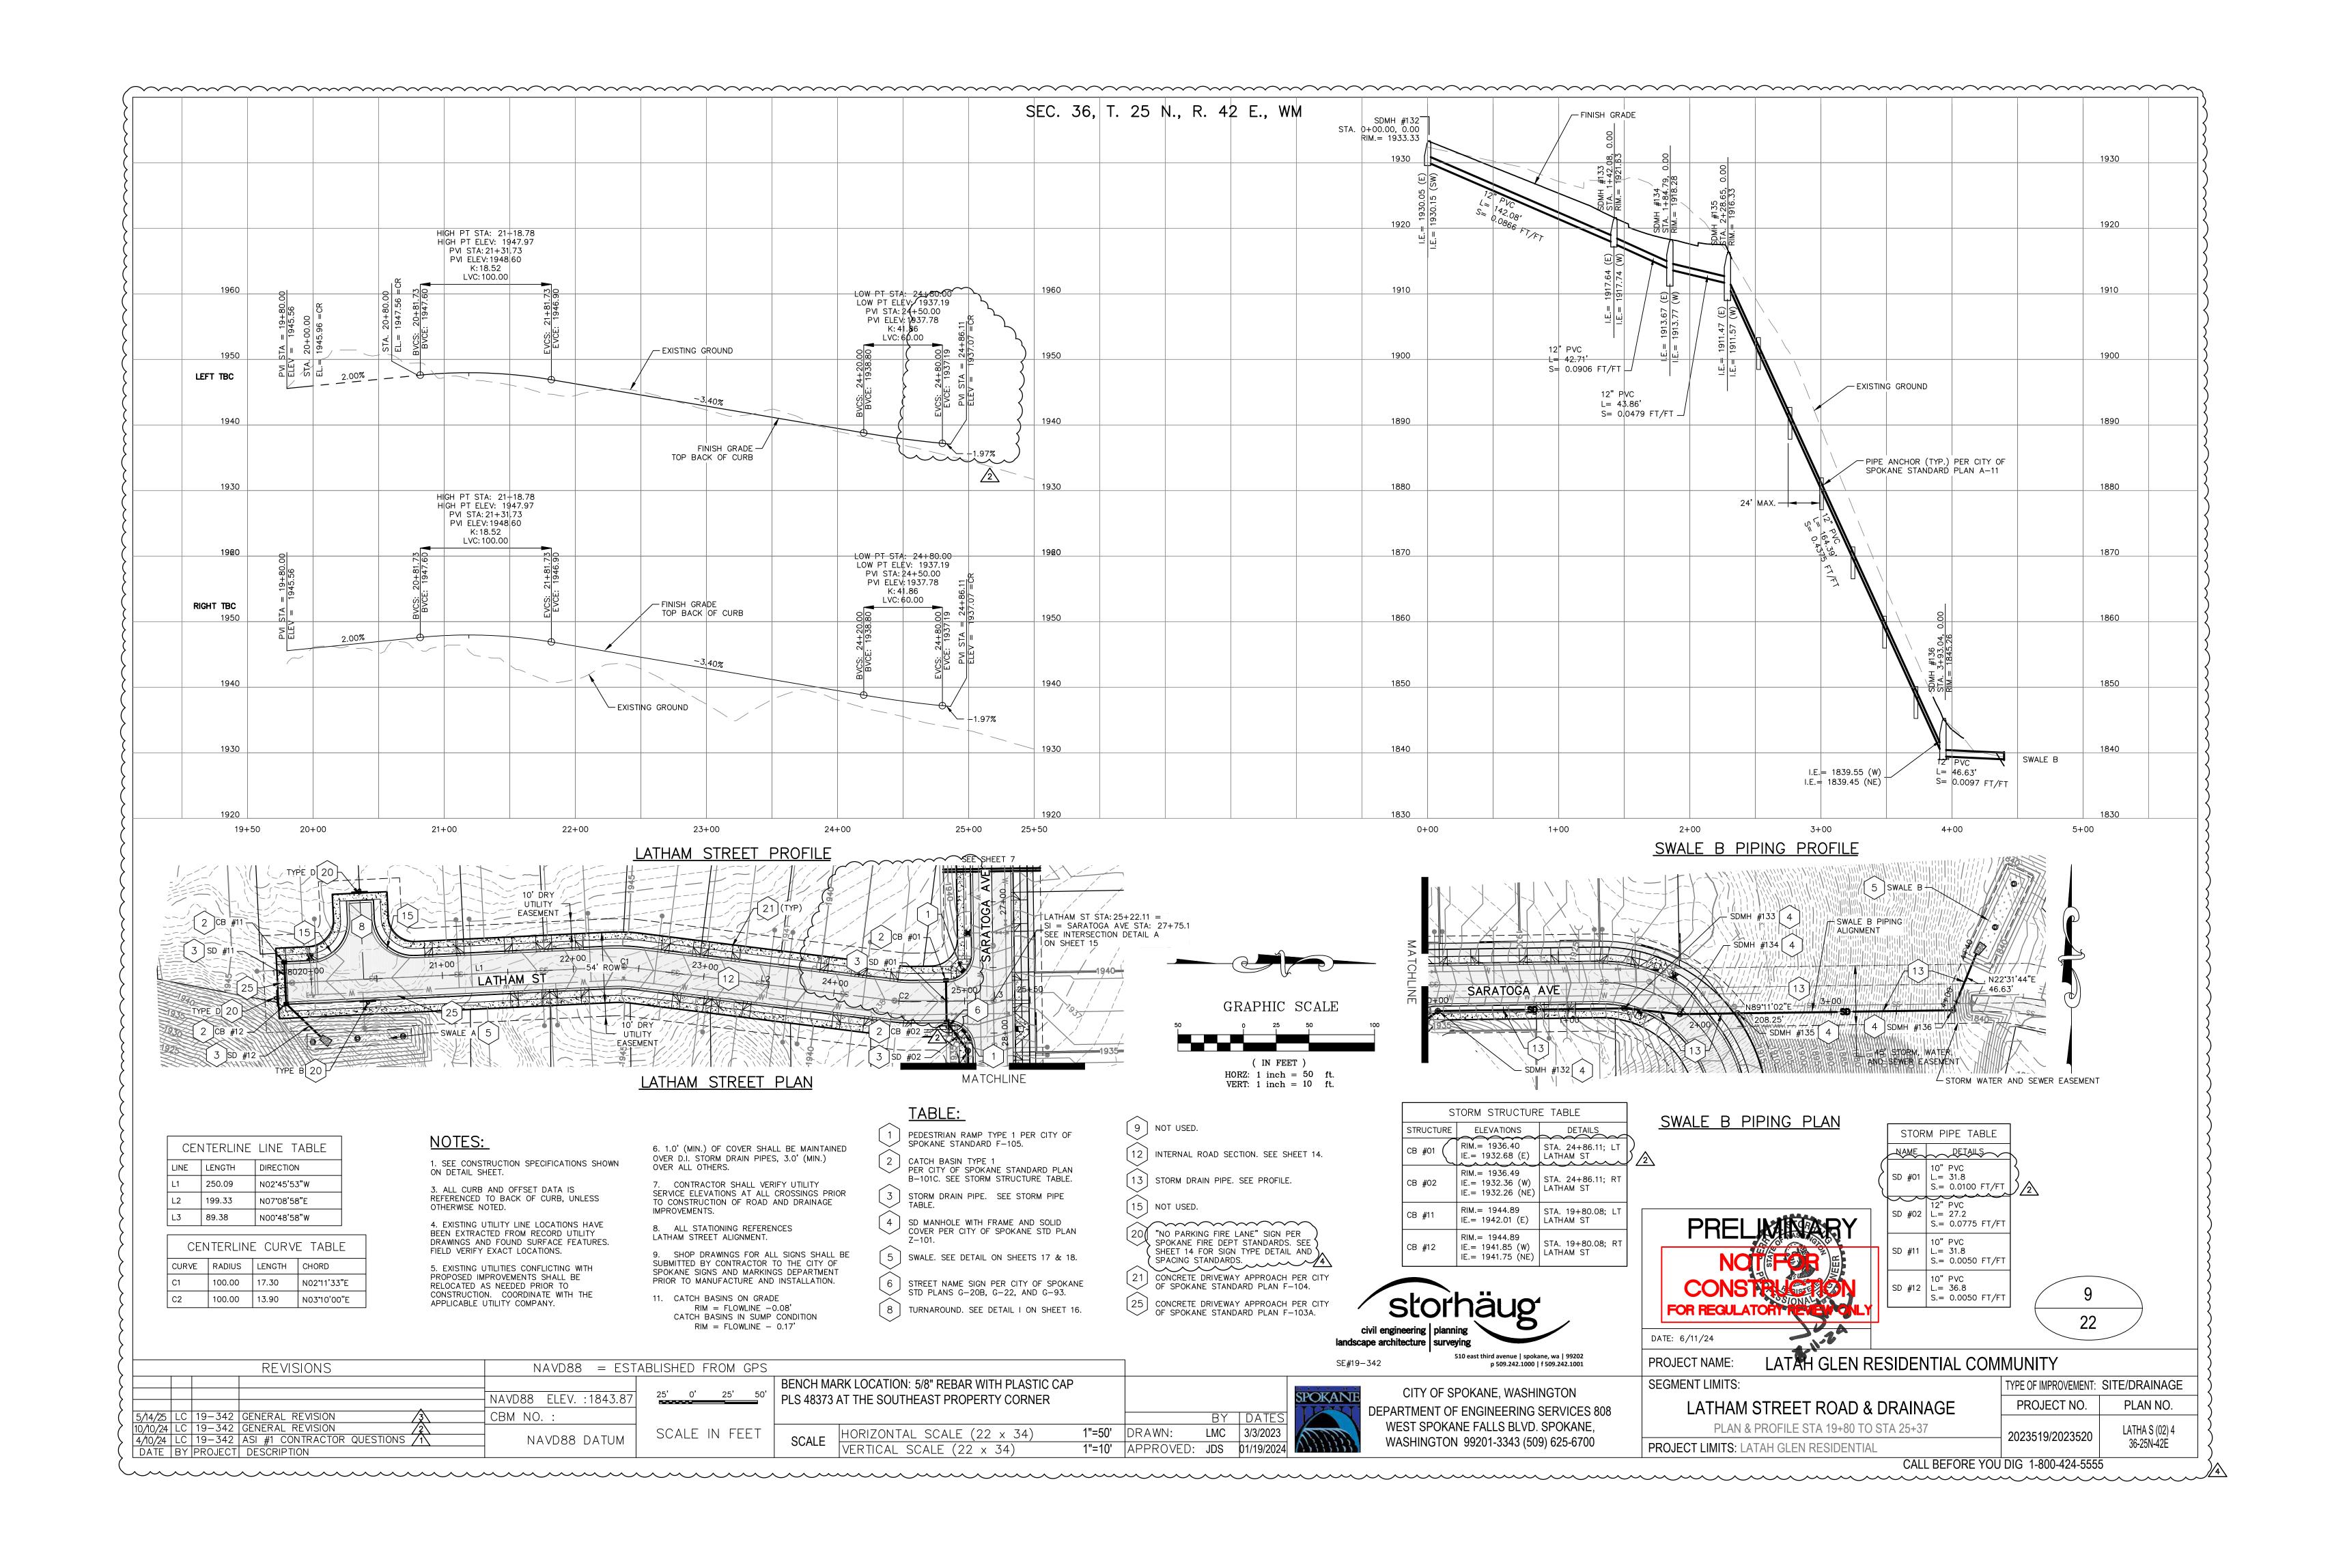


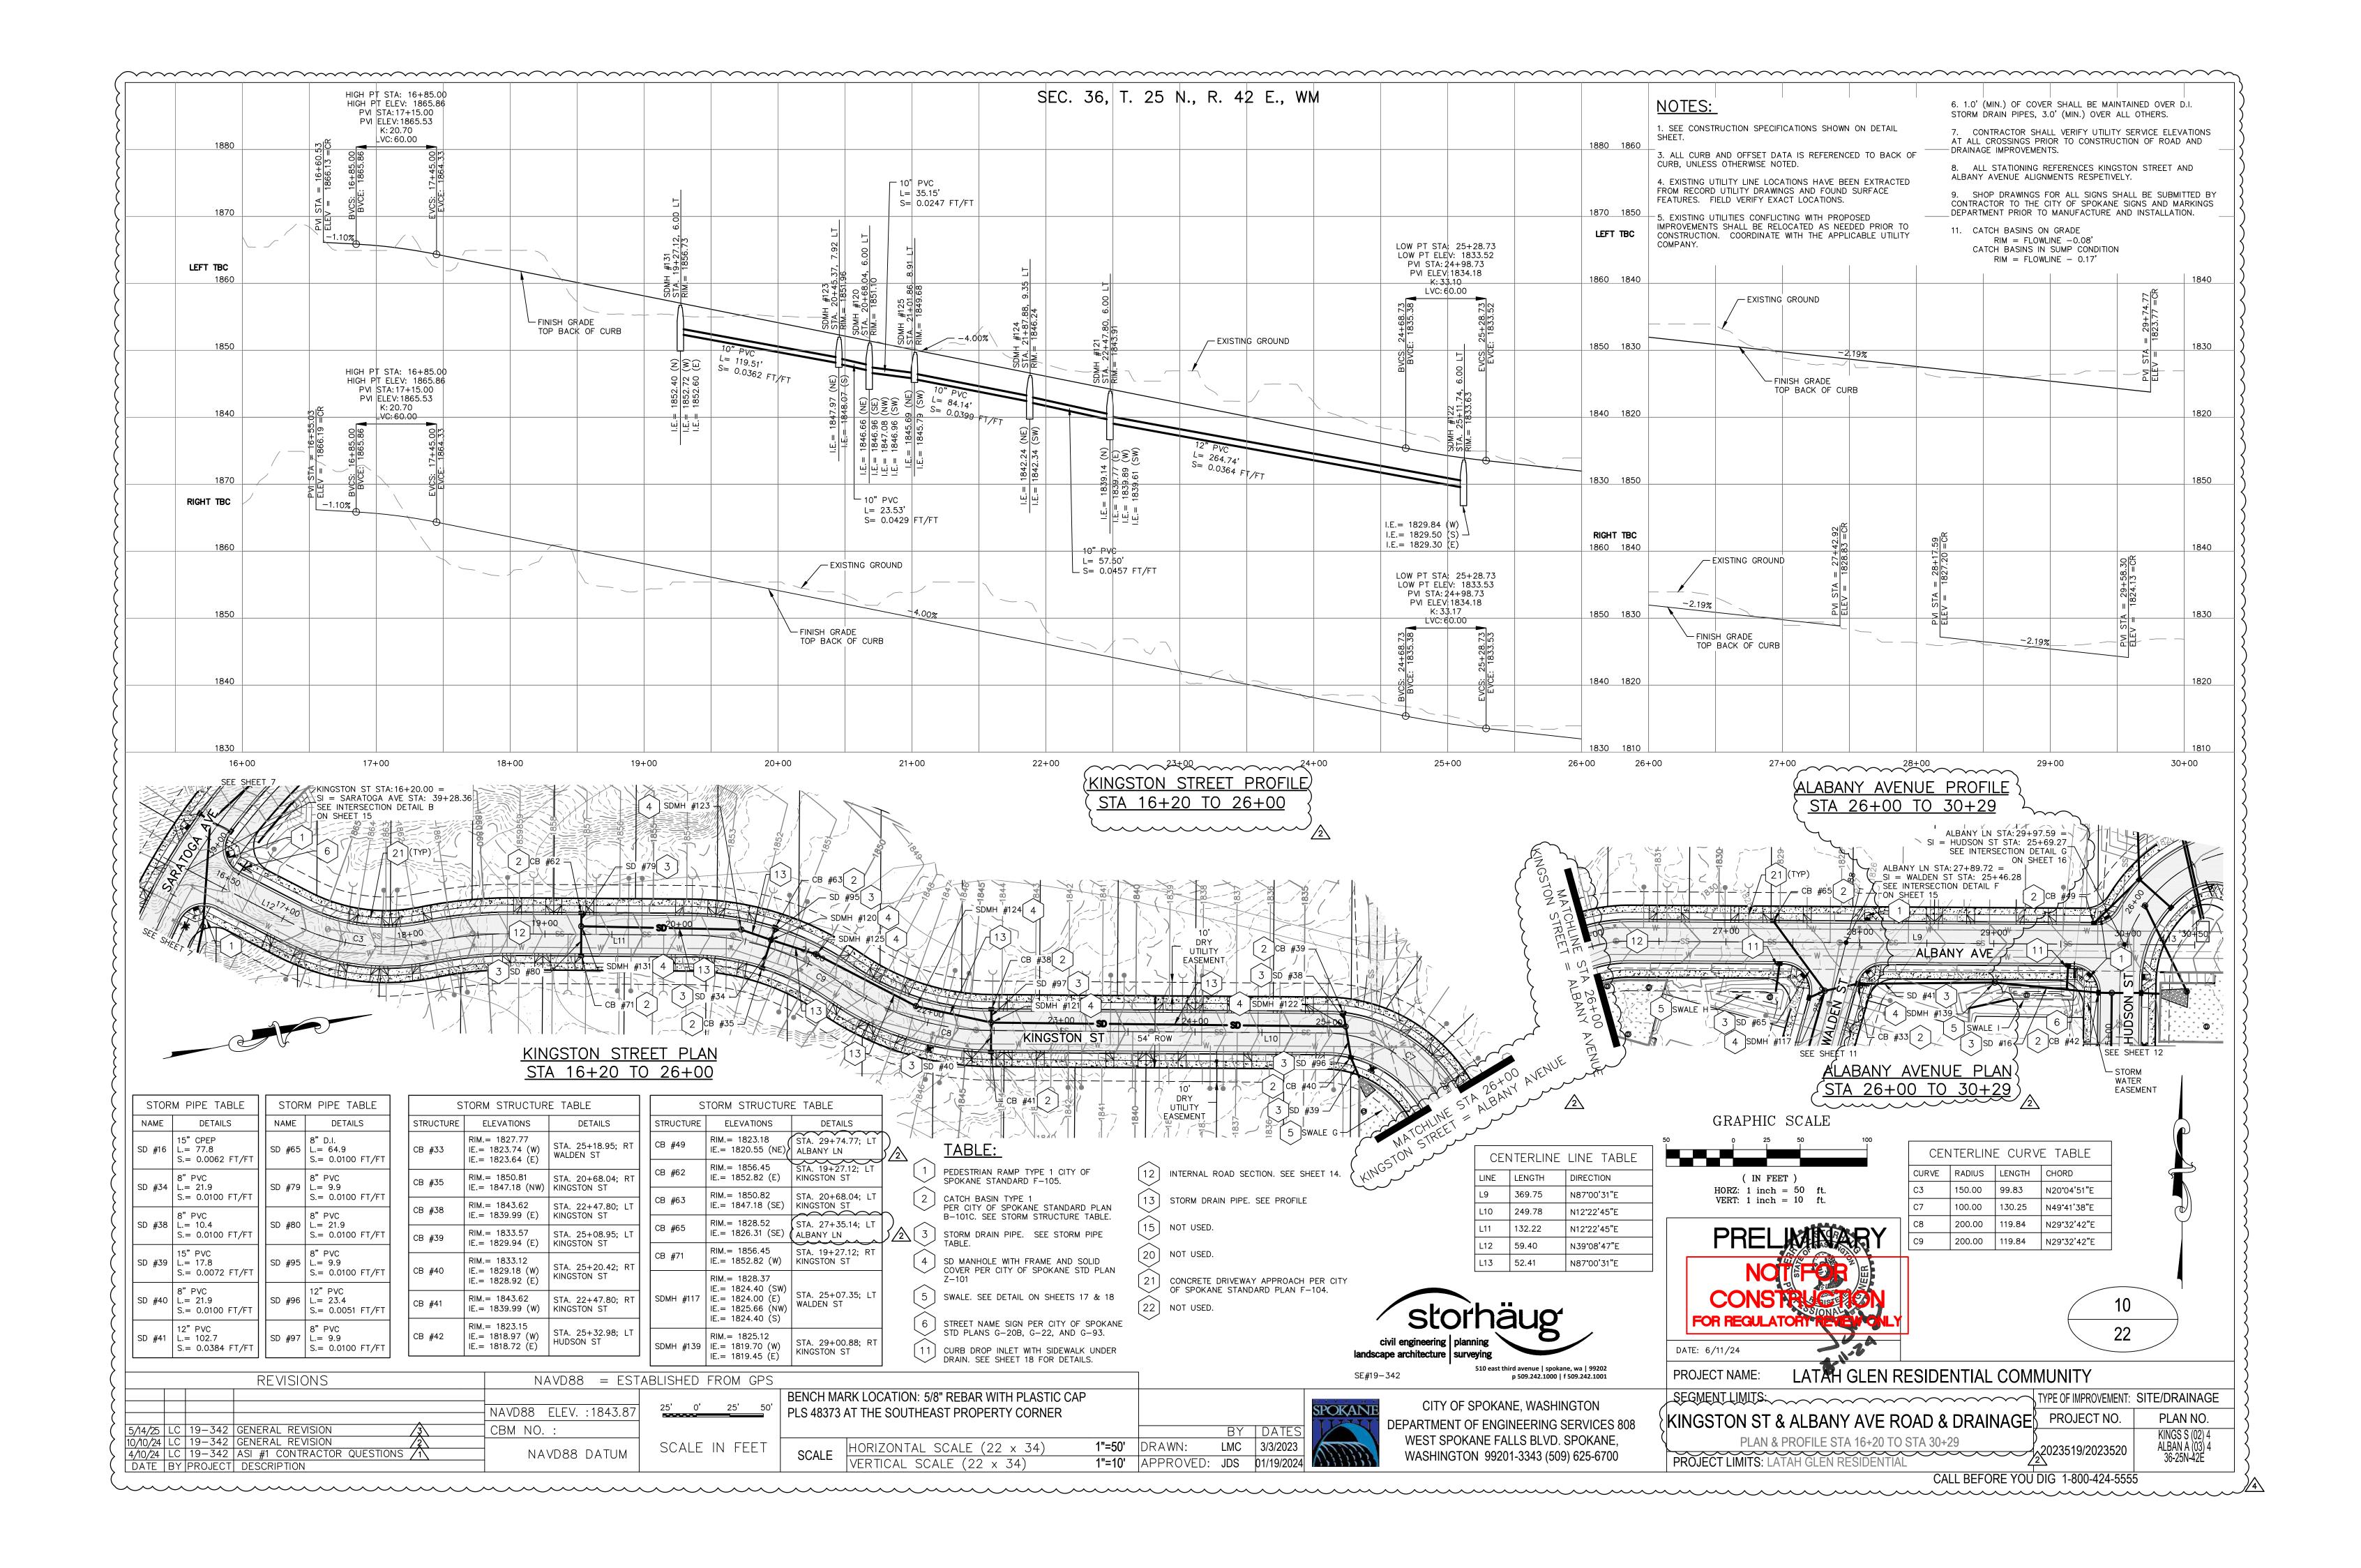


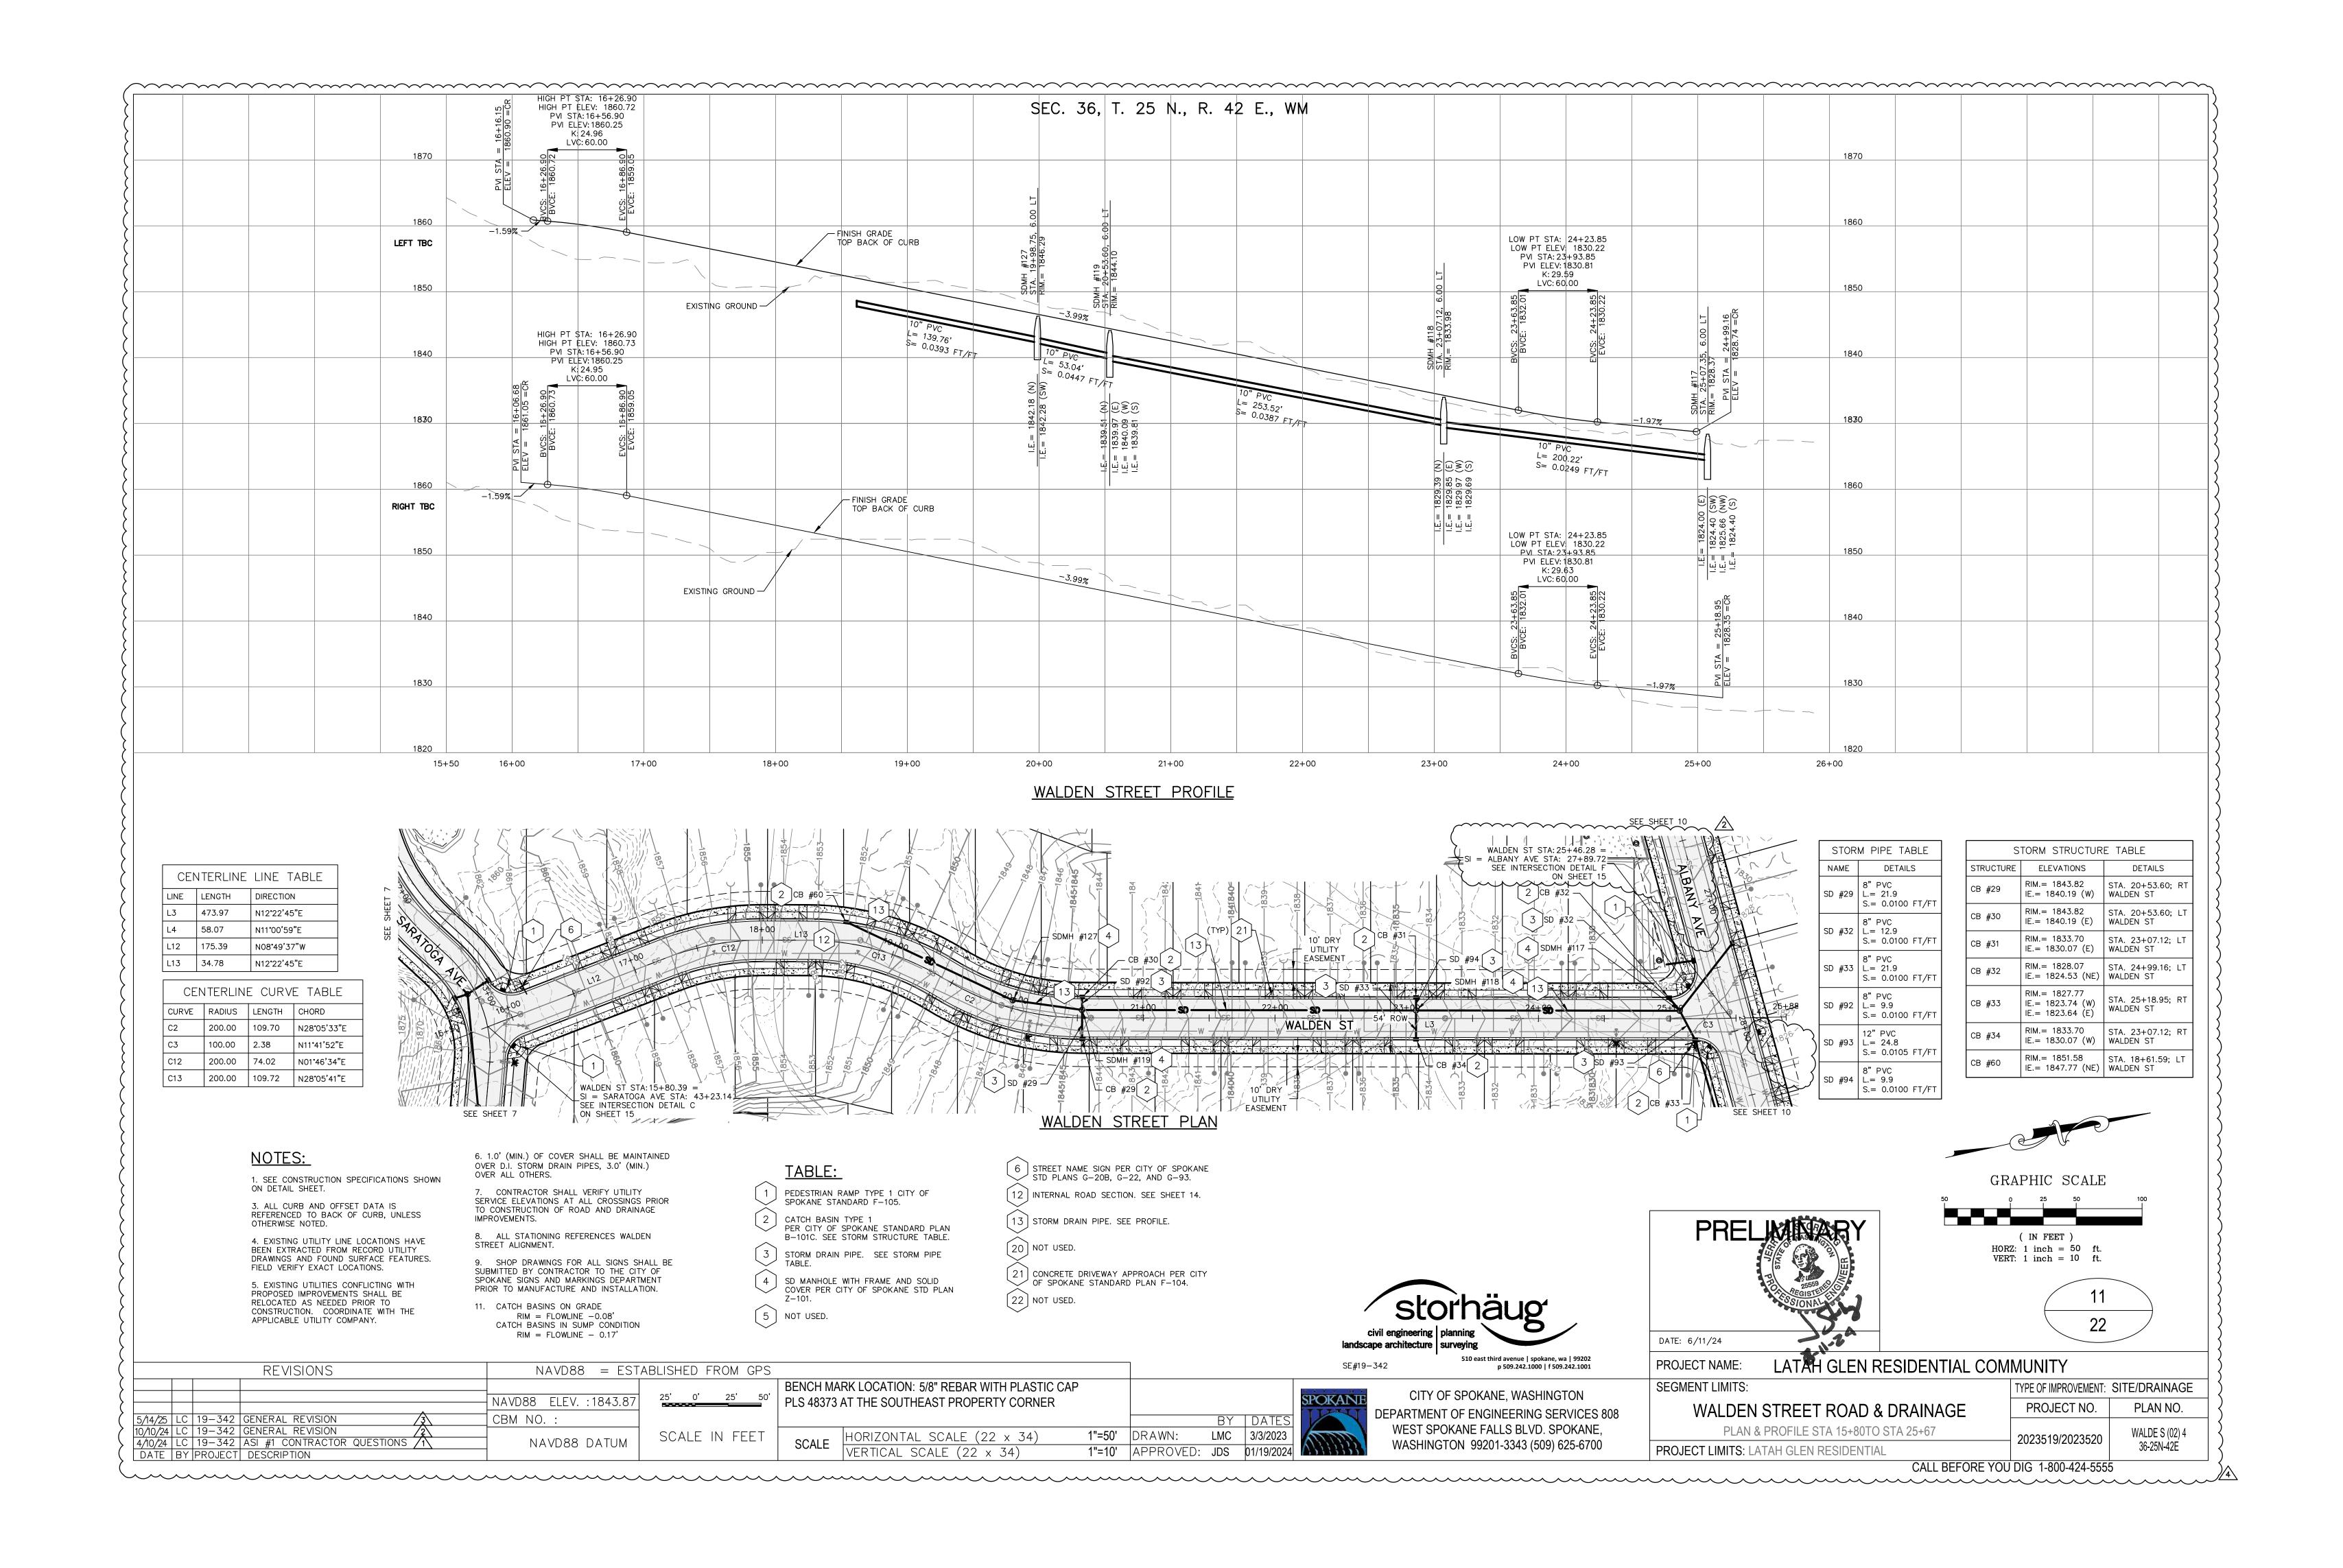


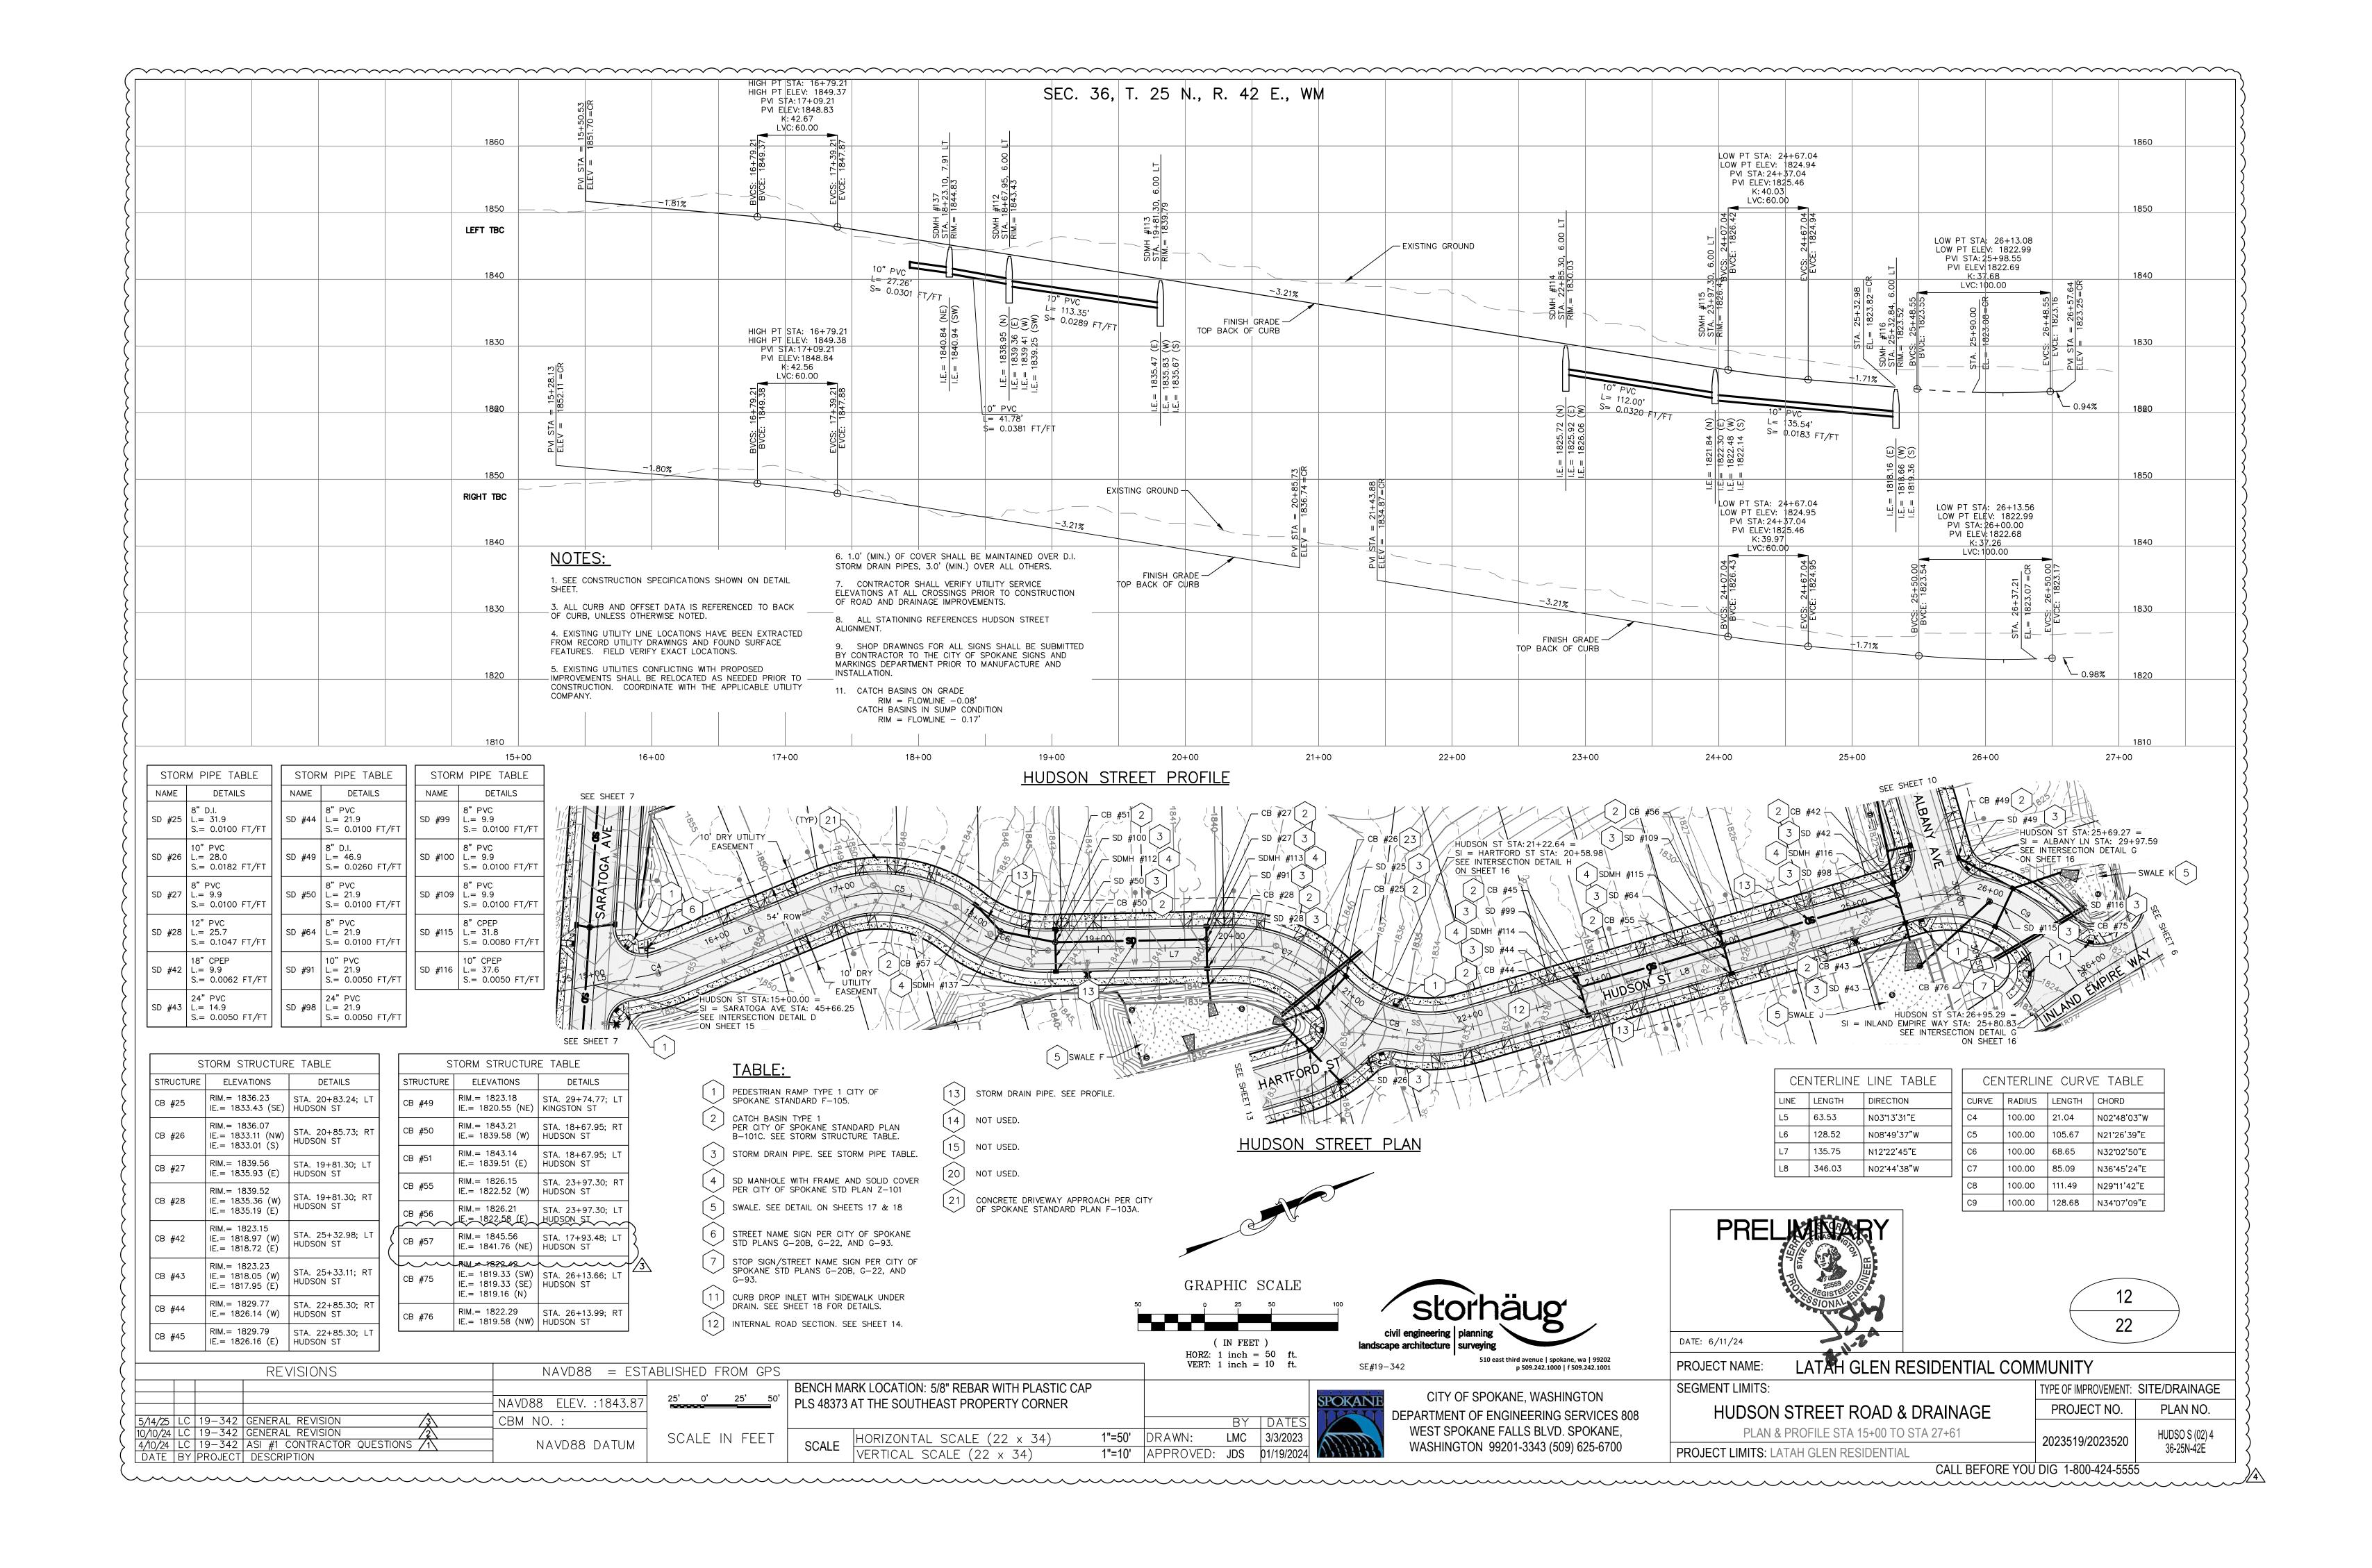


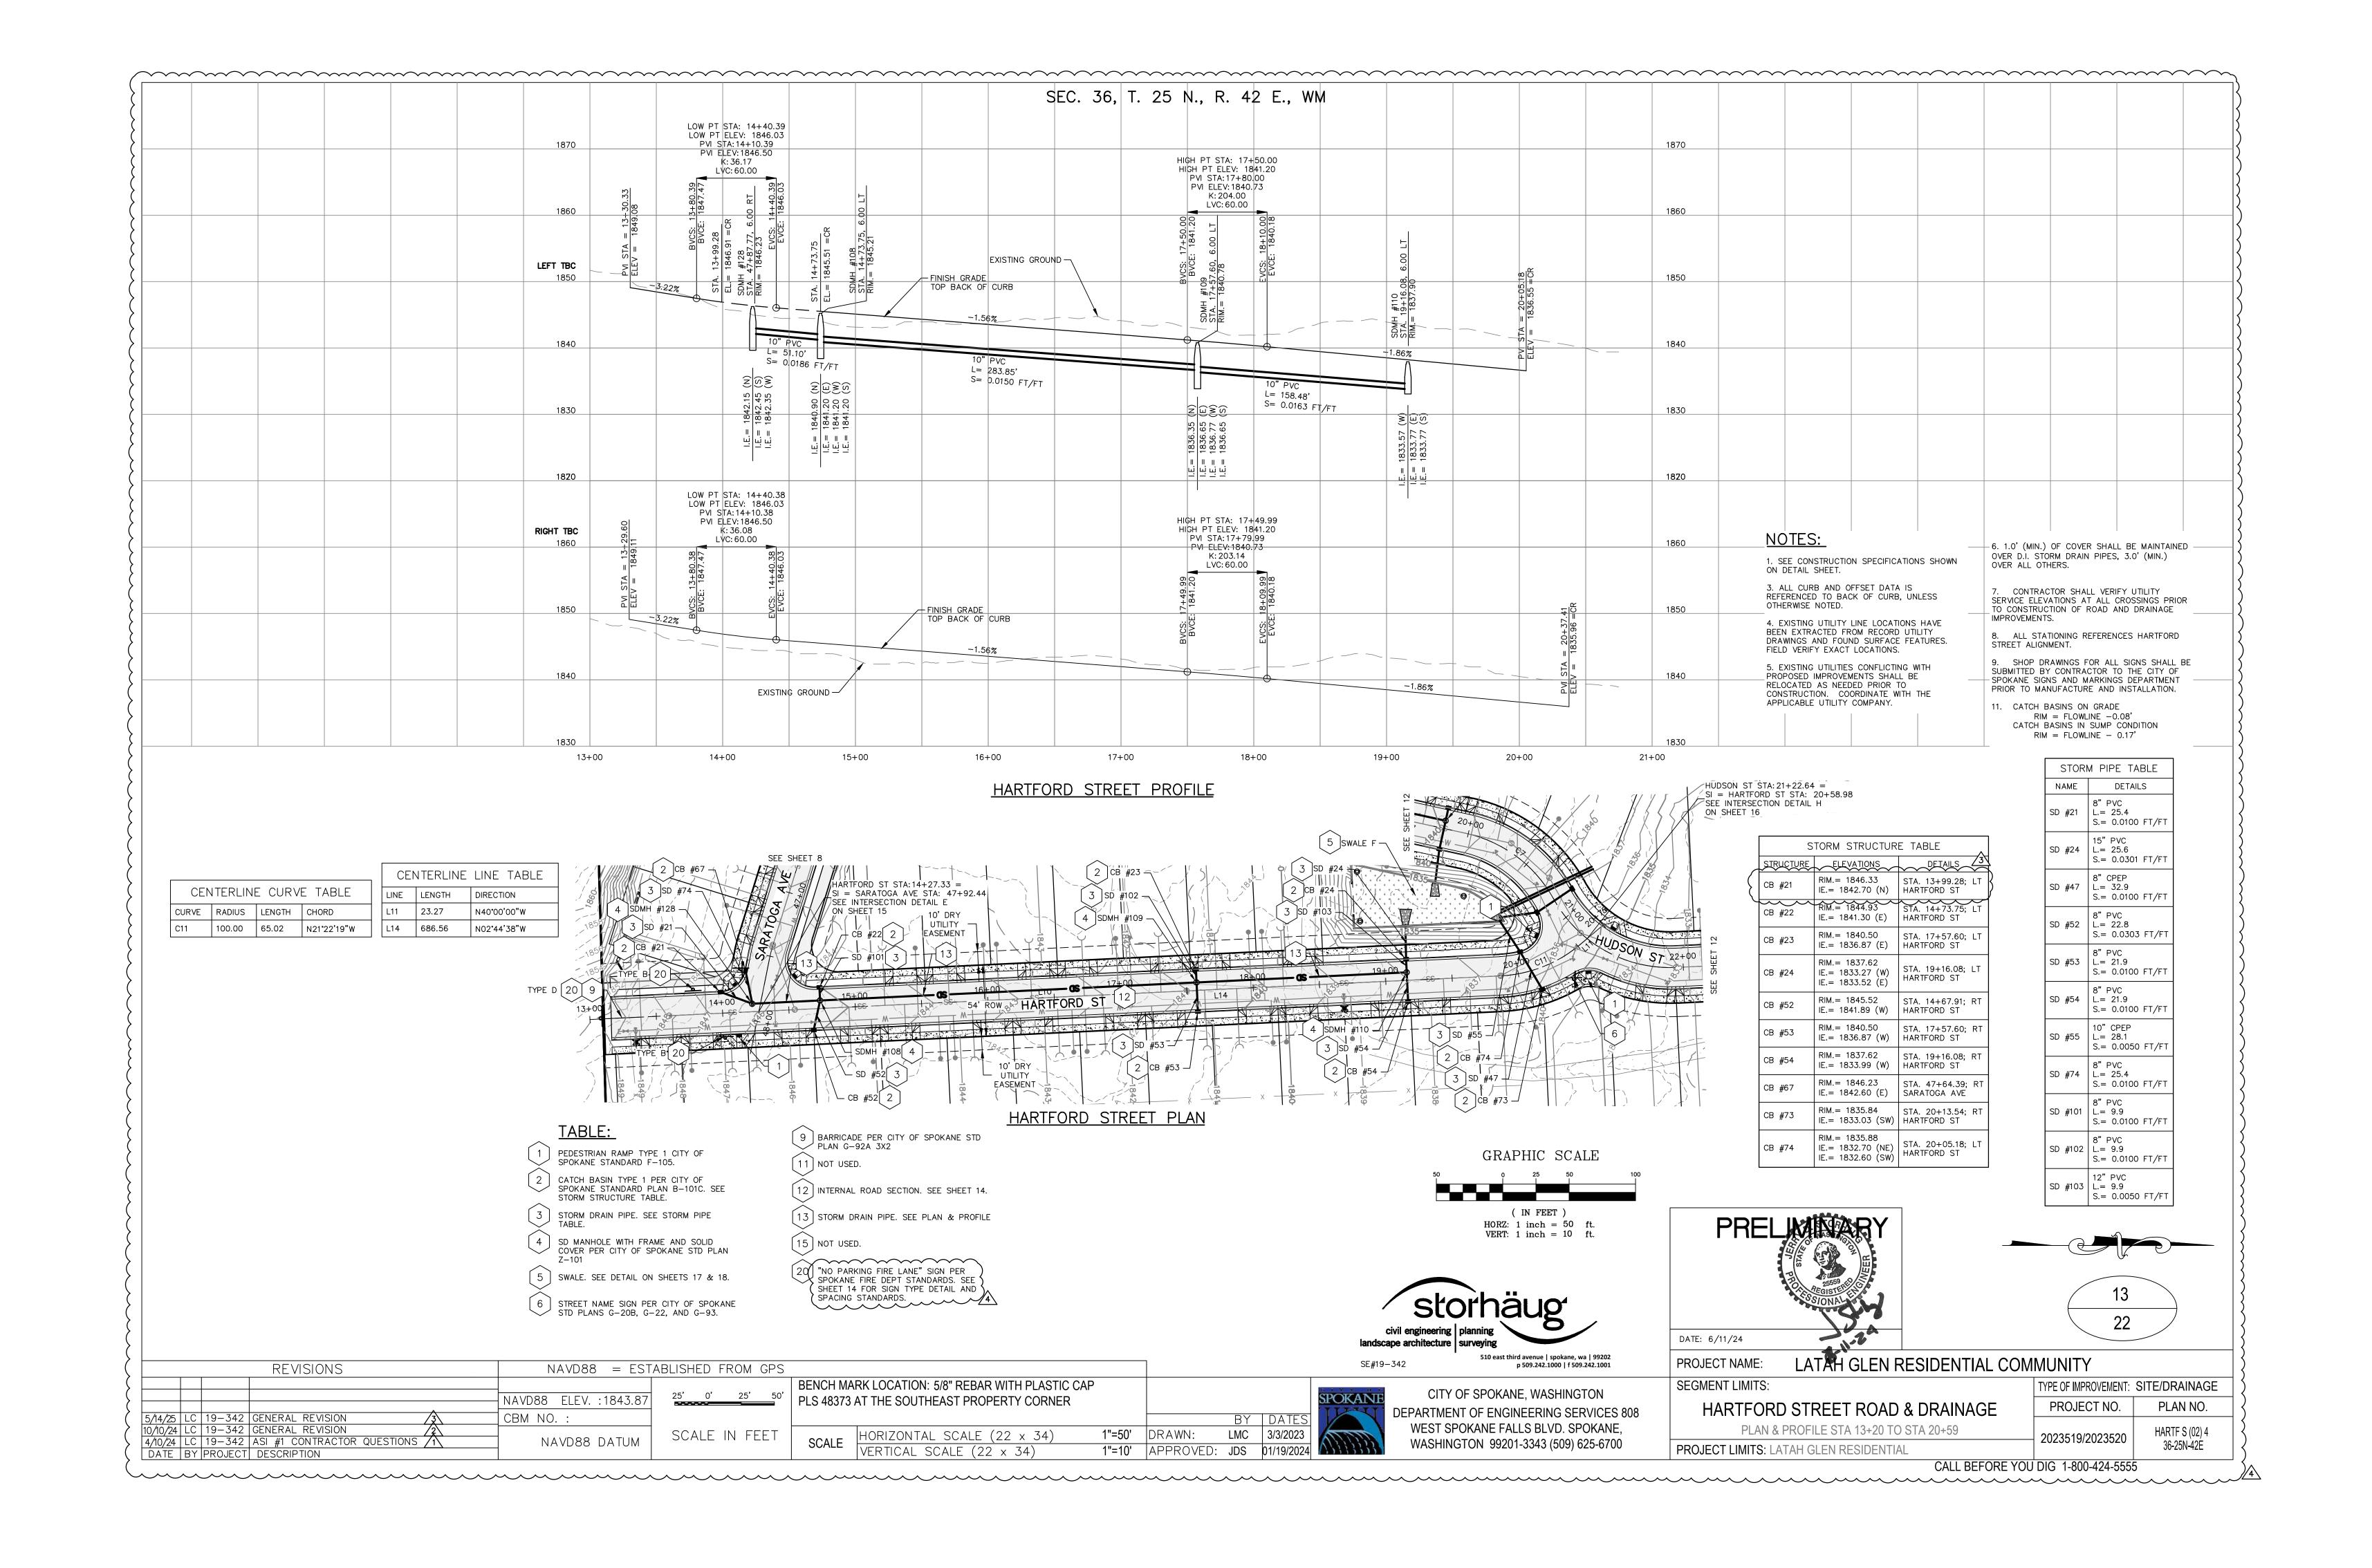


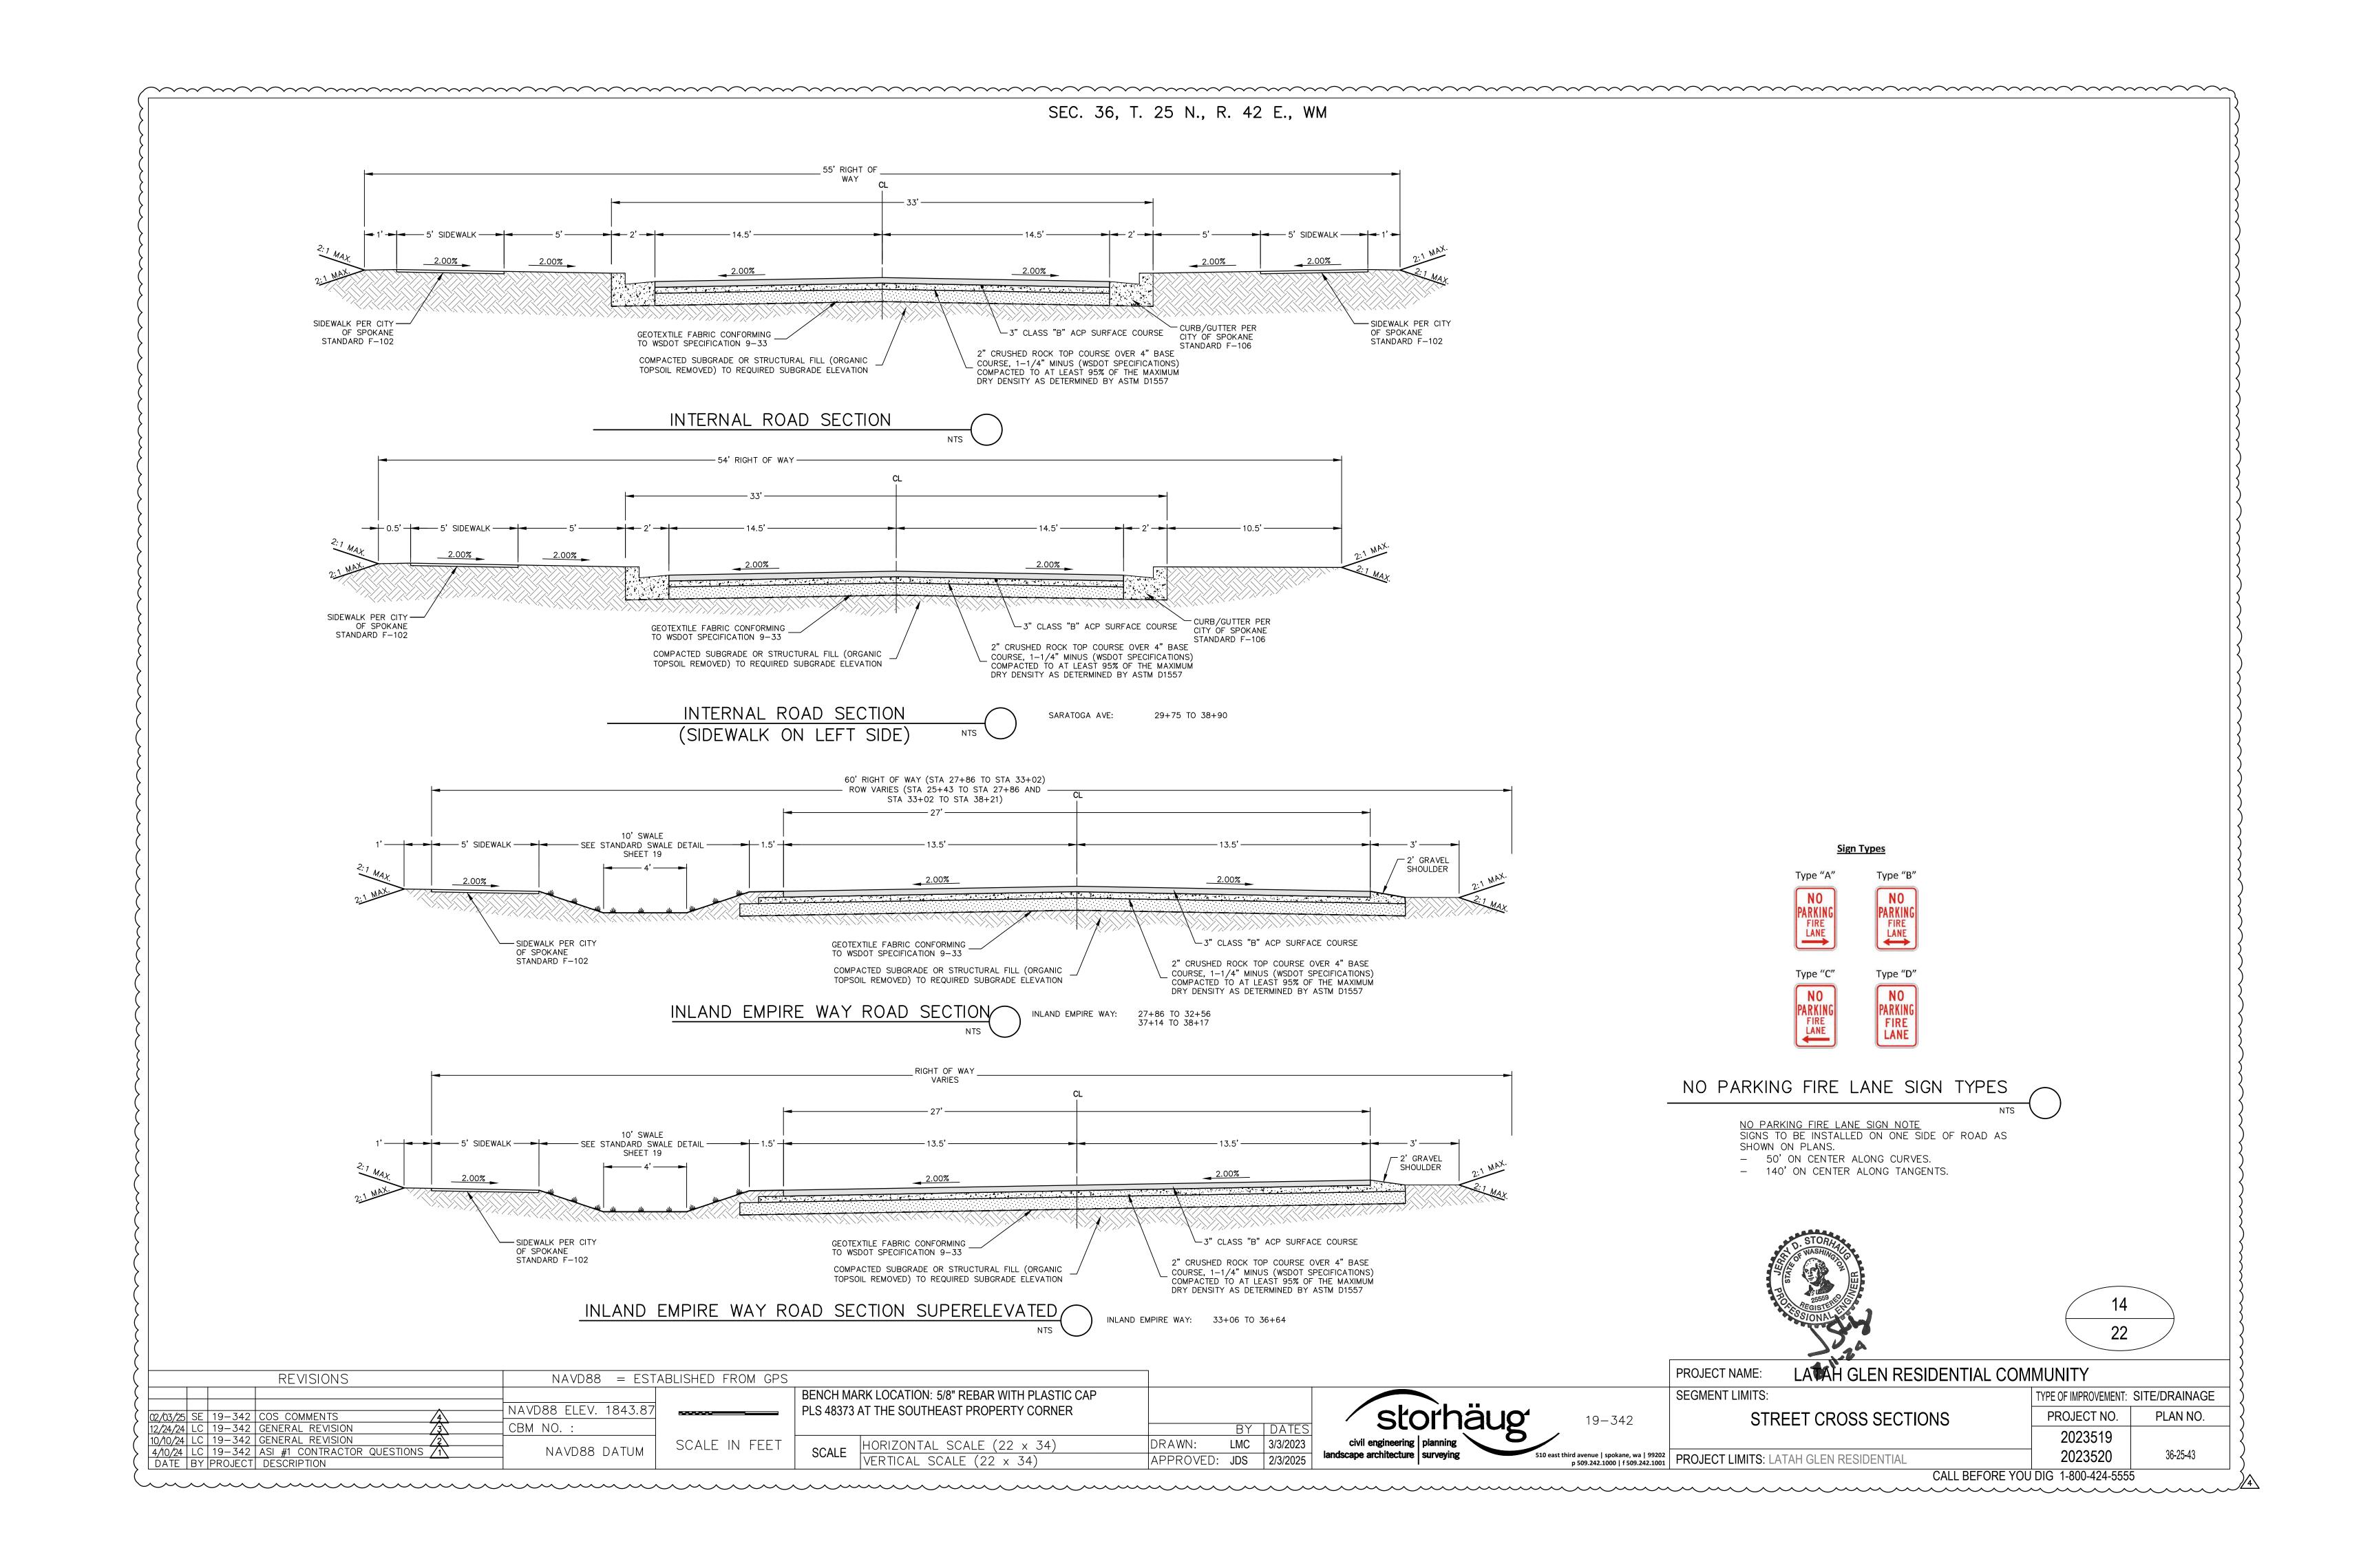

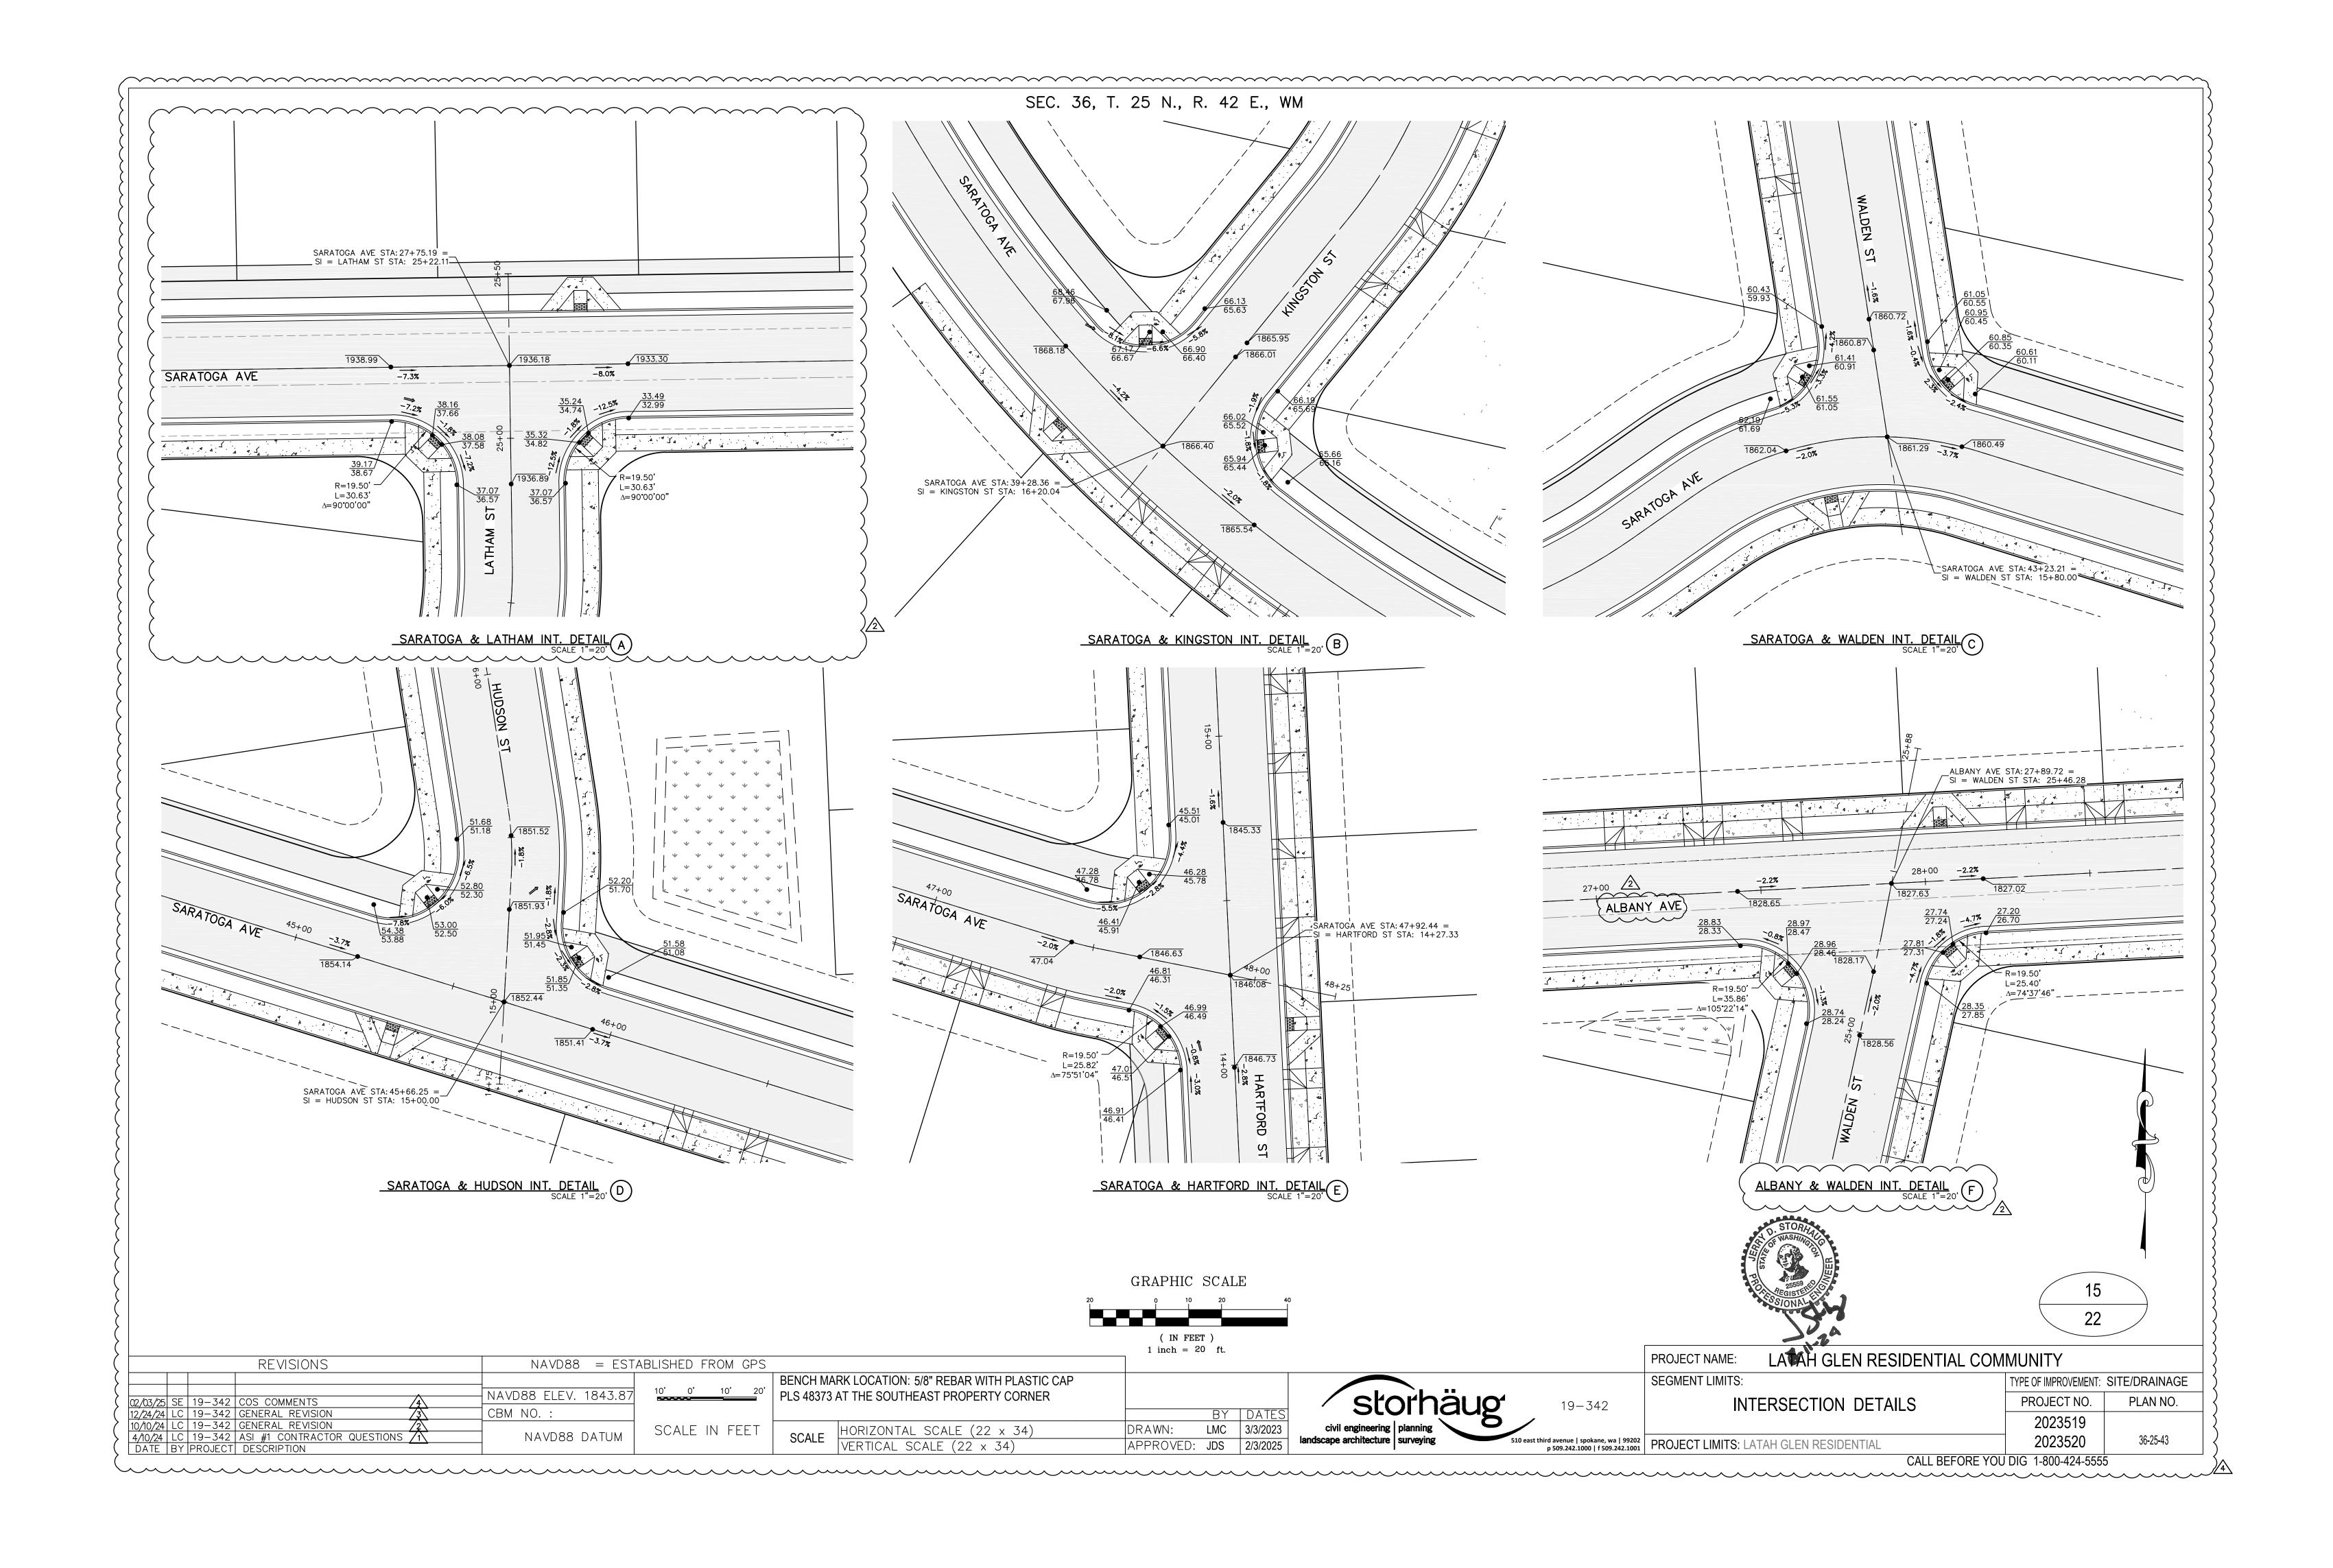

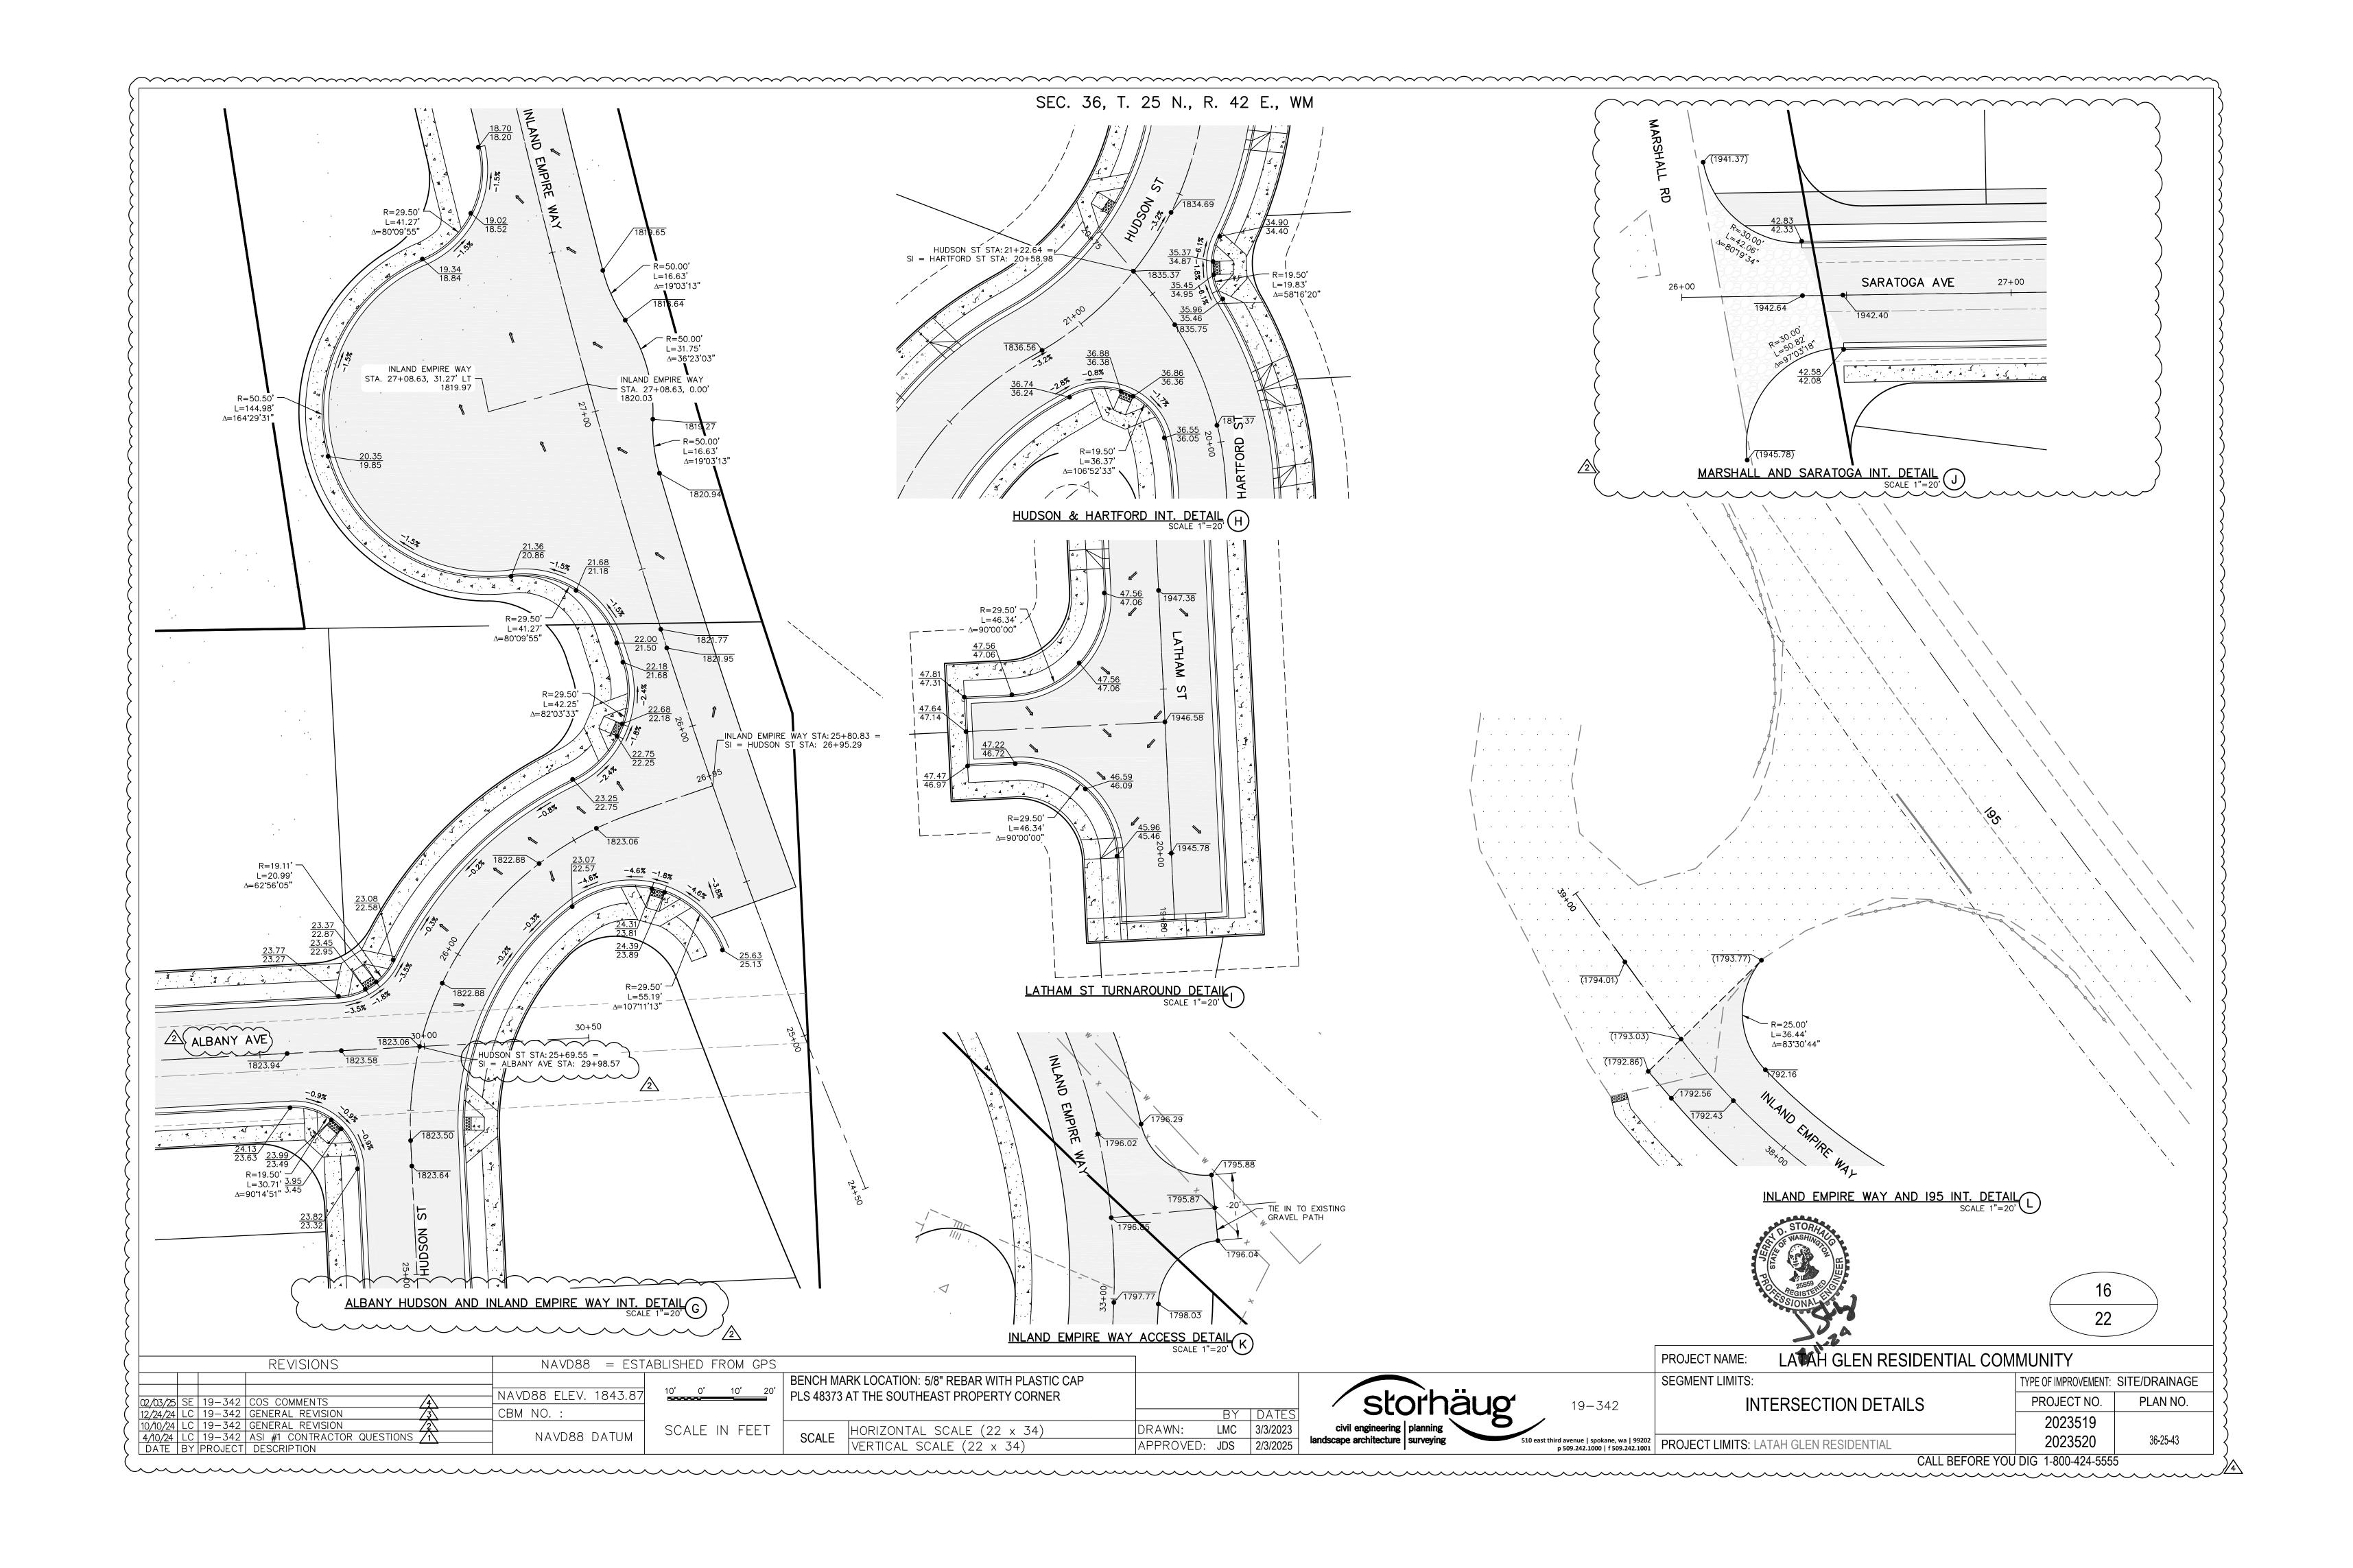

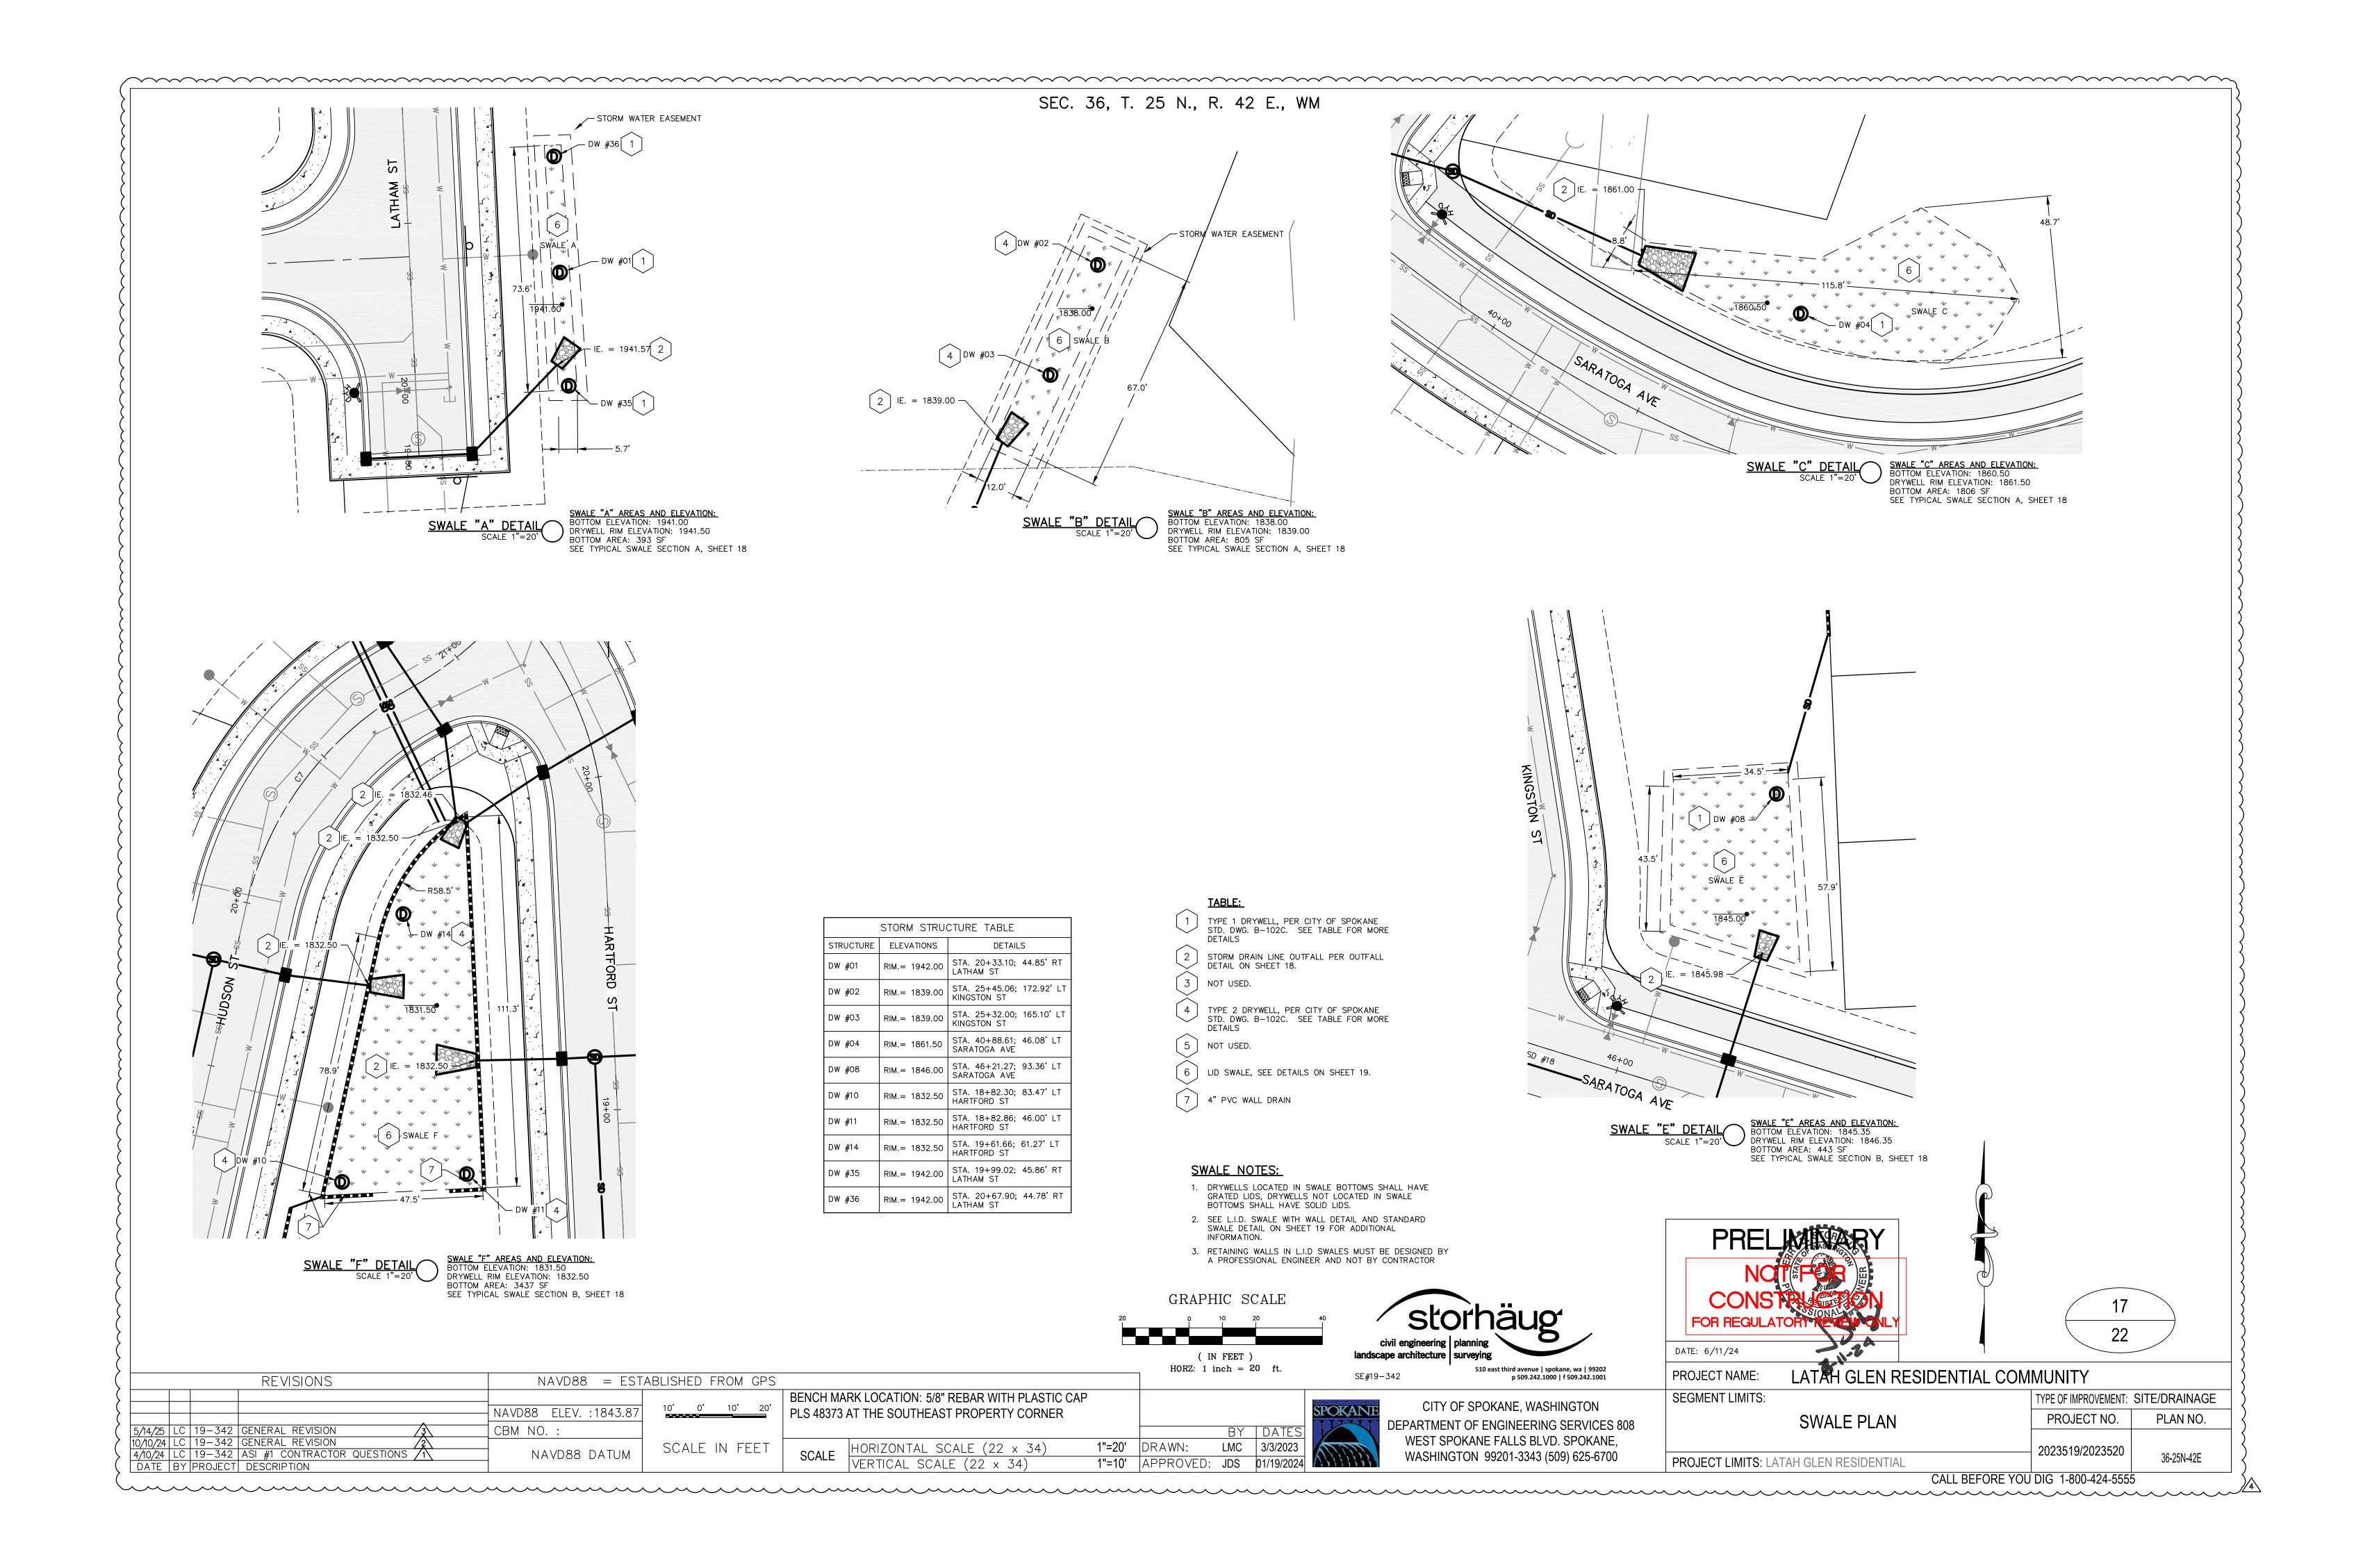

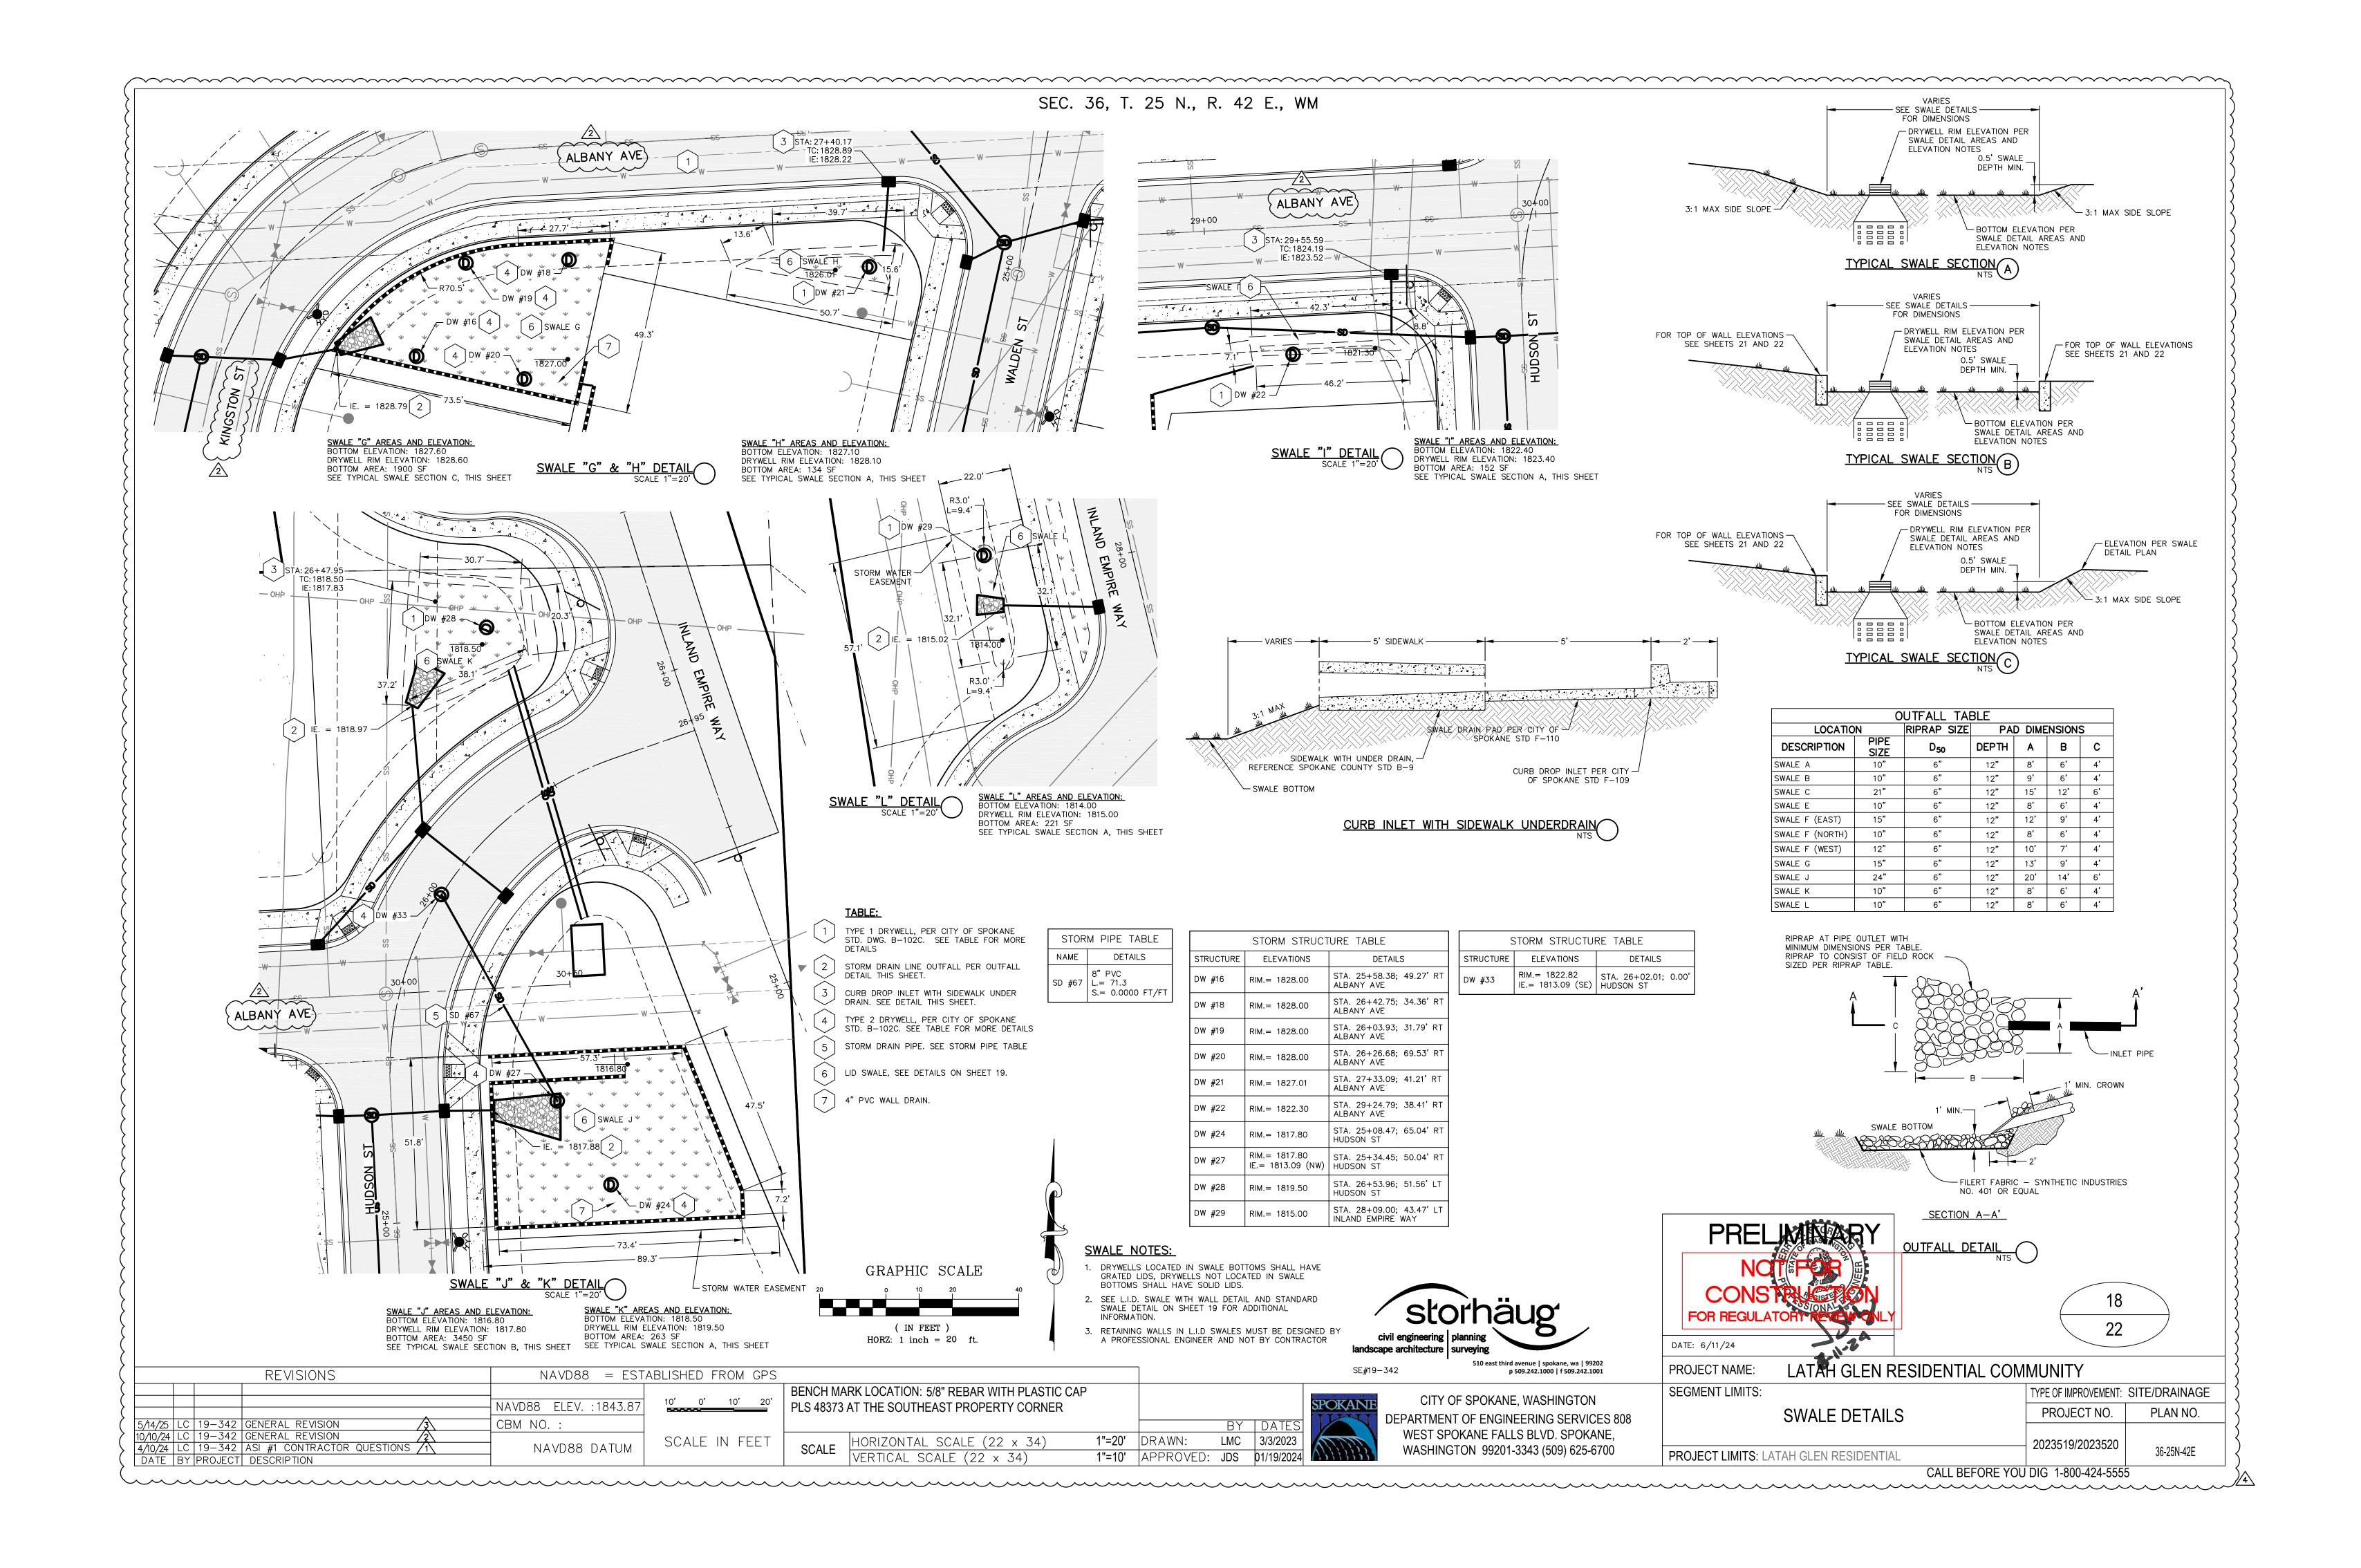

CONSTRUCTION SHALL CONFORM TO CITY OF SPOKANE STANDARDS FOR SEWER, WATER AND STORMWATER MANAGEMENT IMPROVEMENTS. UNLESS IT IS SPECIFICALLY EXCEPTED IN THE PLANS OR CONTRACT DOCUMENTS, ALL CONSTRUCTION METHODS AND MATERIALS SHALL BE IN ACCORDANCE WITH THE 2004 STANDARD SPECIFICATIONS FOR ROAD, BRIDGE, AND MUNICIPAL CONSTRUCTION AS PROMULGATED JOINTLY BY THE WASHINGTON STATE DEPARTMENT OF TRANSPORTATION (WSDOT), THE AMERICAN PUBLIC WORKS ASSOCIATION (APWA), AND AS AMENDED BY THE CITY OF SPOKANE SUPPLEMENTAL SPECIFICATIONS.

2. CONTRACTOR SHALL REFER TO CITY SPECIFICATIONS FOR ADDITIONAL REQUIREMENTS.

. A PLUG SHALL BE INSTALLED AT THE END OF ALL SERVICE LINES UNTIL SUCH TIME THAT SERVICE IS EXTENDED TO BUILDING FOR CONNECTION.

WATER LINES AND APPURTENANCES SHALL MEET THE CITY OF SPOKANE WATER DEPARTMENT AND FIRE DEPARTMENT REQUIREMENTS UNLESS NOTED OTHERWISE. WATER LINES SHALL BE INSTALLED WITH MINIMUM COVER OF 60 INCHES FROM TOP OF PIPE.

MAINTAIN A MINIMUM OF 10 FEET HORIZONTAL CLEARANCE BETWEEN WATER PIPE AND PIPE CARRYING NON-POTABLE WATER. AT CROSSINGS, THERE SHALL BE A MINIMUM VERTICAL CLEARANCE OF 18 INCHES BETWEEN WATER PIPE (ABOVE) AND PIPE CARRYING NON-POTABLE WATER (BELOW). INSTALLATIONS FOR UTILITIES OTHER THAN POTABLE WATER MAY BE INSTALLED AT A CLEARANCE LESS THAN THOSE STATED ABOVE THE NON-POTABLE LINE IS SLEEVED PER CITY OF SPOKANE SPECIFICATIONS. THE SLEEVE PIPE SHALL BE ONE SIZE LARGER THAN THE CONSTRUCTION PIPE. THE SLEEVE SHALL BE AT LEAST 20 FEET IN LENGTH AND CENTERED ON THE CROSSING TO PROVIDE FOR A MINIMUM HORIZONTAL SEPARATION OF 10 FEET EACH SIDE OF THE CROSSING, MEASURED PERPENDICULAR TO THE CROSSED LINE. EACH END OF THE SLEEVE SHALL BE SEALED WITH A FERNCO RUBBER COUPLER.

6. NO UTILITIES ARE TO BE INSTALLED WITHIN 5' PARALLEL TO WATER MAINS AND SERVICE LINES.

7. LOCATIONS OF EXISTING UTILITIES SHOWN ON THE PLANS ARE APPROXIMATE. THE CONTRACTOR SHALL BE RESPONSIBLE FOR LOCATING ALL UNDERGROUND AND OVERHEAD UTILITIES AND STRUCTURES. CONTRACTOR TO PERFORM NECESSARY FIELD VERIFICATION, INCLUDING SUBSURFACE EXPLORATION, FOR ALL EXISTING CONDITIONS TO BE INCLUDED IN CONTRACTOR BID (AT NO ADDITIONAL COST TO THE OWNER). ANY CONFLICTING UTILITIES SHALL BE RELOCATED PRIOR TO CONSTRUCTION OF PROPOSED IMPROVEMENTS.

8. PRIOR TO CONSTRUCTION THE CONTRACTOR IS RESPONSIBLE FOR LOCATING UNDERGROUND UTILITIES. CALL THE UNDERGROUND UTILITY LOCATION SERVICE AT 456-8000 BEFORE YOU DIG.

. IF THE CONTRACTOR DISCOVERS ANY DISCREPANCIES BETWEEN THE CONSTRUCTION DOCUMENTS AND EXISTING CONDITIONS ENCOUNTERED, THE CONTRACTOR SHALL IMMEDIATELY NOTIFY THE DESIGN ENGINEER.

10. UTILITY TRENCHING SHALL BE DONE IN ACCORDANCE WITH CITY OF SPOKANE STANDARD PLANS A-1 AND

11. THE CONTRACTOR SHALL HAVE A COMPLETE SET OF APPROVED PLANS ON THE JOB SITE WHENEVER CONSTRUCTION IS IN PROGRESS.

12. THE CONTRACTOR SHALL REVIEW THE GEOTECHNICAL REPORT FOR THE SUBJECT SITE PRIOR TO STARTING CONSTRUCTION. ANY DISCREPANCIES BETWEEN THE CONSTRUCTION DOCUMENTS AND THE GEOTECHNICAL REPORT SHALL BE REPORTED TO THE ENGINEER. CONSTRUCTION SHALL COMPLY WITH THE RECOMMENDATIONS OF THE GEOTECHNICAL REPORT

13. CONSTRUCTION SHALL COMPLY WITH THE AMERICANS WITH DISABILITIES ACT ACCESSIBILITY GUIDELINES (ADAAG).

14. IF FIELD GRADE ADJUSTMENTS ARE REQUIRED, THE CONTRACTOR SHALL NOTIFY THE ENGINEER IMMEDIATELY.

15. THE CONTRACTOR SHALL COMPLY WITH ALL REQUIREMENTS FOR STORM WATER DISCHARGE ASSOCIATED WITH CONSTRUCTION ACTIVITY AND SHALL BE RESPONSIBLE FOR PROTECTING THE EXISTING STORM WATER MANAGEMENT SYSTEM FROM SEDIMENTATION. THE CONTRACTOR SHALL TAKE THE NECESSARY MEASURES TO PROTECT EXISTING IMPROVEMENTS BY USING EROSION AND SEDIMENT CONTROLS, INCLUDING BUT NOT LIMITED TO, STABILIZED CONSTRUCTION ENTRANCES, SEDIMENT BARRIERS, SILT FENCES, AND INLET PROTECTION.

16. UNLESS ELEVATIONS AND/OR CONTOURS ARE OTHERWISE SHOWN, NEW FINISH GRADE SURFACES SHALL BE PLACED TO ALLOW FOR POSITIVE DRAINAGE TO CURB. GUTTER, OR OTHER RUNOFF COLLECTION DEVICES. MAINTAIN POSITIVE DRAINAGE AWAY FROM THE BUILDING.

17. THE CITY OF SPOKANE SHALL INSPECT AND CERTIFY CONSTRUCTION OF ALL SEWER LINES, SEWER SERVICES, AND BUILDING CONNECTIONS.

18. GEOTEXTILE FABRIC SHALL BE PLACED ON THE RIMS OF DRYWELLS, CATCH BASINS, INLETS, AND AREA DRAINS UNTIL SUCH TIME THE VEGETATION ON SITE IS ESTABLISHED AND THE THREAT OF SEDIMENT DEPOSITION INTO THE DRAINAGE SYSTEM IS MITIGATED

19. EROSION AND SEDIMENT CONTROL MEASURES SHALL CONFORM TO SPOKANE COUNTY ESC BEST MANAGEMENT

20. THE CONTRACTOR SHALL COORDINATE WITH THE APPROPRIATE UTILITY COMPANIES FOR ALL REQUIREMENTS AND TO CONFIRM THAT AN ADEQUATE DEPTH OF COVER IS MAINTAINED OVER THE UTILITIES.

. AREAS DISTURBED OR DAMAGED BY CONSTRUCTION ACTIVITIES SHALL BE CONSTRUCTED OR REPAIRED TO ORIGINAL CONDITIONS OR BETTER.

DAMAGED OR OBLITERATED CORNERS OR MONUMENTS SHALL BE RE-ESTABLISHED BY A PROFESSIONAL

22. EXISTING PROPERTY CORNERS AND SURVEY MONUMENTS SHALL BE PROTECTED DURING CONSTRUCTION. ANY

23. APPROVALS AND PERMITS REQUIRED BY THE GOVERNING REGULATORY AGENCIES SHALL BE OBTAINED BY THE CONTRACTOR PRIOR TO BEGINNING CONSTRUCTION, INCLUDING A CONSTRUCTION GENERAL STORM WATER PERMIT IF REQUIRED. THE CONTRACTOR SHALL COORDINATE WITH THE GOVERNING REGULATORY AGENCIES TO DETERMINE IF A PRE-CONSTRUCTION MEETING IS REQUIRED.

24. THE CONTRACTOR SHALL BE RESPONSIBLE FOR ALL TRAFFIC CONTROL IN ACCORDANCE WITH MUTCD (MANUAL ON UNIFORM TRAFFIC CONTROL DEVICES) STANDARDS. COORDINATE REQUIREMENTS WITH THE GOVERNING REGULATORY AGENCY.

25. SAFETY STANDARDS AND REQUIREMENTS SHALL BE THE RESPONSIBILITY OF THE CONTRACTOR AND COMPLIED WITH AS SET FORTH BY OSHA.

26. THE CONTRACTOR SHALL COORDINATE WITH THE GOVERNING REGULATORY AGENCY REGARDING INSPECTION AND TESTING REQUIREMENTS. INSPECTION, TESTING, COMPACTION, AND DISINFECTION REQUIREMENTS SHALL CONFORM WITH WSDOT, AWWA, AND APWA SPECIFICATIONS.

27. COORDINATE THE INSTALLATION OF STREET NAME AND REGULATORY SIGNS WITH THE GOVERNING REGULATORY

28. UTILITY PIPES AND CONDUITS SHALL BE INSTALLED WITH CONTINUOUS TRACER TAPE ABOVE THE PIPE AND BELOW THE FINISHED SURFACE GRADE AT DEPTHS THAT COMPLY WITH WSDOT AND THE STANDARDS OF THE GOVERNING REGULATORY AGENCY.


29. WHERE NEW ASPHALT JOINS EXISTING ASPHALT, THE EXISTING ASPHALT SHALL BE SAWCUT TO A NEAT, VERTICAL EDGE AND TACKED WITH ASPHALT EMULSION IN ACCORDANCE WITH WSDOT SPECIFICATIONS. THE NEW ASPHALT SHALL BE FEATHERED BACK OVER THE EXISTING ASPHALT TO PROVIDE FOR A SEAL AT THE SAWCUT LOCATION.

30. SANITARY SEWER MAINS AND SERVICES SHALL BE PVC. ASTM D 3034. SDR 35 WITH FLEXIBLE GASKET JOINTS. SEWER SERVICE CONNECTIONS SHALL BE MADE BY A TAP TO AN EXISTING MAIN, OR A TEE BRANCH FROM A NEW MAIN CONNECTED ABOVE THE SPRING LINE FO THE PIPE. SERVICE CONNECTIONS TO MANHOLES ARE PROHIBITED. SEWER SERVICES SHALL BE AT RIGHT ANGLES TO THE SEWER MAIN.

I. GROUNDWATER OR UNANTICIPATED GEOLOGIC CONDITIONS SHALL BE REPORTED TO THE GEOTECHNICAL ENGINEER FOR ASSESSMENT AND RECOMMENDATIONS.

32. ALL COMPACTION EFFORTS SHALL BE MONITORED AND TESTED BY AN EXPERIENCED SOILS TECHNICIAN, UNDER THE SUPERVISION OF A LICENSED GEOTECHNICAL ENGINEER REPRESENTING THE OWNER. ALL MASS GRADING SHALL BE MONITORED, TESTED AND CERTIFIED BY A LICENSED PROFESSIONAL ENGINEER (GEOTECHNICAL ENGINEER).

GENERAL NOTES

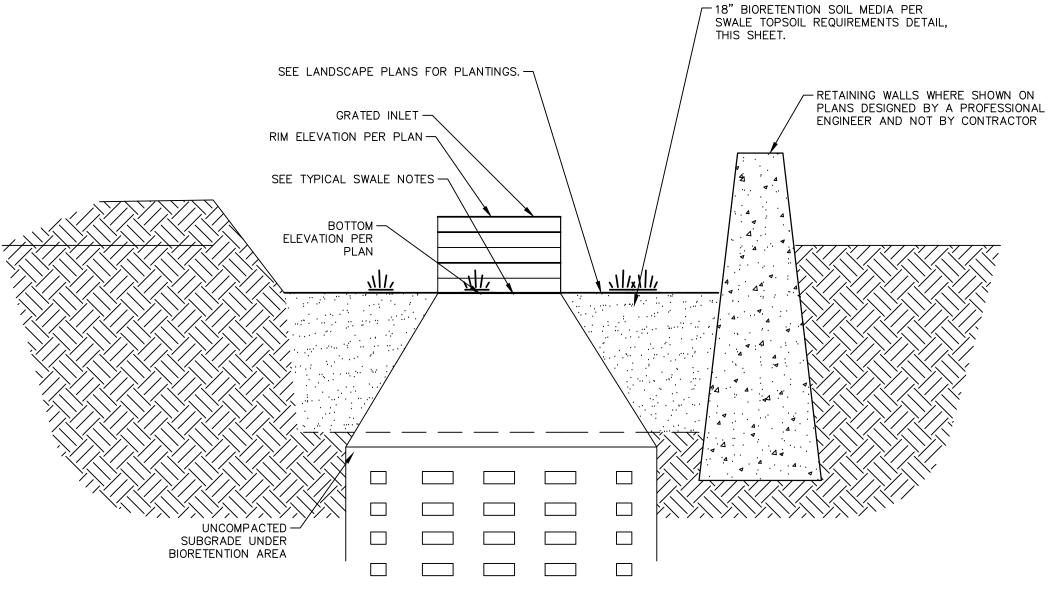

SEC. 36, T. 25 N., R. 42 E., WM

- 1. SEED OR SOD PER LANDSCAPE PLAN.
- 2. DRYWELL OR INLET SHALL BE RAISED 6" ABOVE THE FLOWLINE OF THE DRAINAGE SWALE UNLESS OTHERWISE SHOWN ON THE PLANS.
- 3. DRYWELL TO BE CONSTRUCTED PER CITY OF SPOKANE STANDARDS.
- 4. SWALE SIDE SLOPES TO BE 3:1 MAX (H: V).
- 5. FOR CONSTRUCTION OF DRYWELLS, INSTALL FILTER FABRIC (AMOCO 4545 OR APPROVED EQUIVALENT).

6. THE SWALE BOTTOM SHALL BE FLAT..

7. UTILIZE 18" BIORETENTION SOIL MEDIA MADE FROM IMPORTED 50% HIGHLY PERMEABLE SANDY MINERAL AGGREGATE MIXED WITH 50% COMPOST, PER CHAPTER 4 OF THE EASTERN WASHINGTON LOW IMPACT DEVELOPMENT GUIDANCE MANUAL, JUNE 2013

L.I.D. SWALE WITH WALL



- 2) LOCATIONS OF EXISTING UTILITIES SHOWN IN THE PLANS ARE APPROXIMATE. PRIOR TO SITE CONSTRUCTION, THE CONTRACTOR SHALL BE RESPONSIBLE FOR LOCATING ALL UNDERGROUND AND OVERHEAD UTILITIES. ANY CONFLICTING UTILITIES SHALL BE RELOCATED PRIOR TO CONSTRUCTION OF ROAD AND DRAINAGE FACILITIES. CALL THE UNDERGROUND UTILITY LOCATION SERVICE AT 456-8000 BEFORE YOU DIG.
- 3) THE CONTRACTOR IS REQUIRED TO HAVE A COMPLETE SET OF THE APPROVED ROAD AND DRAINAGE PLANS ON THE JOB SITE WHENEVER CONSTRUCTION IS IN PROGRESS. COORDINATE WITH CITY OF SPOKANE AND DESIGN ENGINEER PRIOR TO CONSTRUCTION. THE CONTRACTOR SHALL OBTAIN ALL APPLICABLE PERMITS PRIOR TO BEGINNING CONSTRUCTION AND COORDINATE WITH THE GOVERNING REGULATORY AGENCIES REGARDING CONSTRUCTION AND INSPECTION REQUIREMENTS.
- 4) IF THE CONTRACTOR DISCOVERS ANY DISCREPANCIES BETWEEN THE PLANS AND EXISTING CONDITIONS ENCOUNTERED, THE CONTRACTOR SHALL IMMEDIATELY NOTIFY THE DESIGN ENGINEER.
- 5) FOR CONSTRUCTION OF DRYWELLS, INSTALL FILTER FABRIC (AMOCO 4545 OR APPROVED EQUIVALENT) BETWEEN THE WASHED DRAIN ROCK AND THE NATIVE SOILS.
- 6) FOR ANY CURB GRADES LESS THAN 0.8% (0.008 FT/FT). A WASHINGTON STATE LICENSED PROFESSIONAL LAND SURVEYOR SHALL VERIFY THAT THE CURB FORMS ARE AT THE GRADES NOTED ON THE APPROVED PLANS, PRIOR TO PLACEMENT OF CURB MATERIAL. THE CONTRACTOR IS RESPONSIBLE FOR ARRANGING AND COORDINATING WORK WITH THE PROFESSIONAL LAND
- 7) THE CONTRACTOR SHALL EMPLOY A LICENSED SURVEYOR TO VERIFY THAT THE CROSS GUTTER FORMS ARE AT THE CORRECT PLANE GRADE PRIOR TO CONCRETE PLACEMENT. THE CROSS GUTTERS SHALL BE CONSTRUCTED PRIOR TO PAVING, AND THE PAVEMENT SHALL THEN MATCH THE EDGE OF CONCRETE GUTTER.
- 8) THE CONTRACTOR SHALL REVIEW ALL GEOTECHNICAL RECOMMENDATIONS AND INVESTIGATION REPORTS ASSOCIATED WITH THE SUBJECT DEVELOPMENT PRIOR TO STARTING CONSTRUCTION. ANY DISCREPANCIES BETWEEN DESIGN PLANS AND GEOTECHNICAL REPORT SHALL BE REPORTED TO THE DESIGN ENGINEER. CONSTRUCTION SHALL COMPLY WITH RECOMMENDATIONS OF THE GEOTECHNICAL
- 9) THE CONTRACTOR SHALL DEMOLISH AND REMOVE EXISTING STRUCTURES AND ASSOCIATED IMPROVEMENTS ON THE SUBJECT SITE PRIOR TO STARTING CONSTRUCTION. CONTRACTOR SHALL COORDINATE DEMOLITION ACTIVITIES WITH OWNER FOR FURTHER DIRECTION AND EXTENT OF WORK.
- 10) THE FLOOR OF A GRASSED PERCOLATION AREA (GPA) SWALE INCLUDES THE LEVEL PORTION OF THE FLOOR OF THE SWALE, AND THE SIDESLOPES OF THE SWALE UP TO THE GPA OVERFLOW ELEVATION OR TOP OF DRYWELL. THE SOIL LOCATED IN THE FLOOR OF THE GPA SWALE SHALL BE A MEDIUM TO WELL-DRAINING MATERIAL, WITH A MINIMUM INFILTRATION RATE OF 0.5 INCHES PER HOUR. THE ENGINEER SHALL PROVIDE A WRITTEN STATEMENT WHICH VERIFIES THAT ALL GPA

SWALES CONFORM TO THIS REQUIREMENT. THIS WRITTEN STATEMENT SHALL BE SUBMITTED TO PRIOR TO FINAL ACCEPTANCE. THE SWALE FLOOR MATERIAL SHALL BE INSTALLED TO A NATIVE SOIL STRATUM WHICH ALSO MEETS OR EXCEEDS THIS MINIMUM PERCOLATION RATE OF 0.5 INCHES

- 11) IRRIGATION SYSTEM FOR STORM WATER MANAGEMENT PONDS SHALL BE PROVIDED BY
- 12) CPEP STORM DRAIN PIPES, WHEN IDENTIFIED ON THE PLANS, SHALL BE POLYETHYLENE (CPEP) SMOOTH WALL PIPE PER ADVANCED DRAINAGE SYSTEM (ADS) N12, CONSTRUCTED PER W.S.D.O.T/A.P.W.A STANDARD SPECIFICATION. ALL CPEP PIPE SHALL SATISIFY THE ADDITIONAL
- 13) THE CONTRACTOR SHALL BE RESPONSIBLE FOR ALL TRAFFIC CONTROL IN ACCORDANCE WITH M.U.T.C.D. AND CITY OF SPOKANE STANDARDS PRIOR TO DISRUPTION OF ANY TRAFFIC. NO WORK SHALL COMMENCE UNTIL ALL APPROVED TRAFFIC CONTROL IS IN PLACE AND THE APPROPRIATE AGENCY NOTIFICATION HAS TAKEN PLACE.
- 14) WHERE NEW ASPHALT JOINTS EXIST, THE EXISTING ASPHALT SHALL BE CUT TO A NEAT VERTICAL EDGE AND TACKED WITH ASPHALT EMULSION TYPE CSS-1 IN ACCORDANCE WITH THE STANDARD A SEAL AT THE SAW CUT LOCATION AND THE JOINT SEALED WITH GRADE AR-4000W PAVING
- 15) COMPACTION OF SUB GRADE, ROCK AND ASPHALT SHALL BE IN ACCORDANCE WITH THE STANDARD
- 16) COORDINATE WITH THE CITY OF SPOKANE STREET MAINTENANCE DEPARTMENT SIGNS AND MARKINGS DIVISION REGARDING CONSTRUCTION / INSTALLATION OF STREET NAME AND REGULATORY SIGNS.
- 17) MAINTAIN MINIMUM HORIZONTAL CLEARANCE AS SHOWN ON CITY OF SPOKANE STANDARD PLANS SHALL BE A MINIMUM VERTICAL CLEARANCE OF 18 INCHES BETWEEN WATER PIPE (ABOVE) AND PIPE CARRYING NON-POTABLE WATER (BELOW). INSTALLATIONS FOR UTILITIES OTHER THAN
- 18) DRYWELL INSTALLATION SHALL BE PER CITY OF SPOKANE STANDARD PLANS.
- 19) THE CONTRACTOR SHALL COMPLY WITH ALL REQUIREMENTS FOR STORM WATER DISCHARGE ASSOCIATED WITH CONSTRUCTION ACTIVITY.

andscape architecture | surveying

SHALL BE PLACED TO ALLOW FOR POSITIVE DRAINAGE TO CURB, GUTTER, OR OTHER RUNOFF COLLECTION DEVICES. MAINTAIN POSITIVE DRAINAGE AWAY FROM BUILDINGS.

THE CITY OF SPOKANE ENGINEER'S OFFICE PRIOR TO INSTALLING FINISHED LANDSCAPING/SOD AND

- CONTRACTOR/DEVELOPER. IRRIGATION SYSTEM SHALL BE DESIGN/BUILD.
- REQUIREMENTS OF THE CITY OF SPOKANE "LETTER OF INSTRUCTION" DATED APRIL 1, 2006.
- SPECIFICATIONS. THE NEW ASPHALT SHALL BE FEATHERED BACK OVER EXISTING TO PROVIDE FOR
- W-111 BETWEEN WATER PIPE AND PIPE CARRYING NON-POTABLE WATER. AT CROSSINGS, THERE POTABLE WATER MAY BE INSTALLED AT A CLEARANCE LESS THAN THOSE STATED ABOVE IF THE NON-POTABLE LINE IS SLEEVED PER CITY OF SPOKANE STANDARD PLAN W-111.

- 20) UNLESS ELEVATIONS AND/OR CONTOURS ARE OTHERWISE SHOWN, NEW FINISH GRADE SURFACES

DATE: 6/11/24

CONTRACTOR TO GRADE BERM TO CONTAIN 0.5' (MIN.)STORAGE

_DEPTH IN PROPOSED SWALE. SEE

GRADING PLAN FOR MORE DETAILS

SWALE SHALL HAVE 12" OF TOPSOIL MATCHING SWALE TOPSOIL

5. IRRIGATION TO BE PROVIDED AS REQUIRED TO MAINTAIN HEALTHY

REQUIREMENTS AS PROVIDED THIS SHEET.

. SWALE SHALL BE SODDED OR TURF SEEDED.

GROWING GRASSES. IRRIGATION DESIGN BY OWNER.

DESIGN REQUIREMENT

BETWEEN 0.25 AND .050 INCHES/HOUR

AT LEAST 0.15 INCHES/HOUR AND FACILITY MUST COMPLETELY DRAIN WITHIN 72 HOURS

AT LEAST 15 MILLIEQUIVALENTS/100GRAMS

AT LEAST 2% BY WEIGHT

0.5' SWALE DEPTH MIN.—

STANDARD SWALE DETAIL

PROVIDE FRESH, CLEAN NEW CROP SEED COMPLYING WITH TOLERANCE FOR PURITY AND

MIXTURE COMPOSED OF GRASS SPECIES AND PERCENTAGES AS FOLLOWS:

FERTILIZER: 16:16:16 TIMED RELEASE COMPOSITION, 300 LBS. PER ACRE

ALL SEEDING OF SLOPES SHALL BE DONE IN ACCORDANCE WITH WSDOT STANDARD

GERMINATION ESTABLISHED BY OFFICIAL SEED ANALYSTS OF NORTH AMERICA. PROVIDE SEED

PROVIDE MIXTURE COMPOSED OF GRASS SEED AND FERTILIZER IN PERCENTAGES AS FOLLOWS:

CONTRACTOR SHALL IRRIGATE SEEDED AREAS UNTILL SEED HAS GERMINATED AND HAS BEEN

SEEDING SPECIFICATIONS

UNLESS RECOMMENDED OTHERWISE BY A GEOTECHNICAL ENGINEER, BIO-INFILTRATION

INCHES THICK, UNDERLAIN BY A SUBGRADE INFILTRATIVE LAYER AT LEAST 48 INCHES

THICK. ALL SOILS, INCLUDING AMMENDED NATIVE SOILS, SHALL MEET THE INFILTRATIVE

WELL-DRAINING SOIL (TESTED FOR INFILTRATIVE AND TREATMENT CRITERIA) AT LEAST 12

SWALES SHALL BE CONSTRUCTED WITH A TREATMENT ZONE OF MEDIUM-TO

1 SAND AND COARSER SOILS ARE NOT SUITABLE TO BE USED AS TOP SOILS WHEN TREATMENT IS REQUIRED

REQUIREMENTS FOUND IN CHAPTER 4 OF THE SPOKANE REGIONAL STORMWATER MANUAL (SRSM).

REQUIREMENTS FOR EITHER THE AVERAGE CATION EXCHANGE

NOTE:

1. THE SWALE TOPSOIL REQUIREMENTS SHALL MEET THE DESIGN

CAPACITY OR THE ORGANIC MATTER CONTENT.

 2 AN INFILTRATION TEST (FOR EXAMPLE, A SINGLE-RING INFILTROMETER TEST) DEMONSTRATING THE FACILITY'S CONFORMANCE TO THE INFILTRATION RATE CRITERIA MAY BE REQUIRED PRIOR TO CONSTRUCTION CERTIFICATION.

³ THE 48-INCH LAYER OF INFILTRATIVE SUBGRADE SOILS MUST BE MEET THE GEOTECHNICAL RECOMMENDATIONS AS PER THE

SWALE TOPSOIL REQUIREMENTS

1.0' TOPSOIL -

SIDE SLOPE

20 PERCENT ELKA PERENNIAL RYE

20 PERCENT DURAR HARD FESCUE 45 PERCENT COVAR SHEEP /FESCUE

ACCEPTED BY CITY OF SPOKANE.

15 PERCENT REUBENS CANADIAN BLUEGRASS

GRASS SEED MIXTURE: 90 LBS. PER ACRE

CRITERIA INDICATED IN TABLE 6-1.

CRITERIA

TREATMENT ZONE INFILTRATION RATE

(VEGETATED COVER AND TREATEMEN<u>T LAY</u>ER)

SUBGRADE INFILTRATION RATE 23

AVERAGE CATION EXCHANGE CAPACITY

ORGANIC MATTER CONTENT

LATAH GLEN RESIDENTIAL COMMUNITY

SEGMENT LIMITS: TYPE OF IMPROVEMENT: SITE/DRAINAGE NOTES PLAN NO. PROJECT NO. 2023519/2023520 36-25N-42E PROJECT LIMITS: LATAH GLEN RESIDENTIAL

PROJECT NAME:

CITY OF SPOKANE, WASHINGTON DEPARTMENT OF ENGINEERING SERVICES 808 WEST SPOKANE FALLS BLVD. SPOKANE,

510 east third avenue | spokane, wa | 99202

p 509.242.1000 | f 509.242.1001

REVISIONS NAVD88 = ESTABLISHED FROM GPS NAVD88 ELEV. :1843.87 4/25 LC 19-342 GENERAL REVISION 3 10/24 LC 19-342 GENERAL REVISION 2 0/24 LC 19-342 ASI #1 CONTRACTOR QUESTIONS 1 CBM NO. NAVD88 DATUM DATE BY PROJECT DESCRIPTION

SCALE IN FEET


BENCH MARK LOCATION: 5/8" REBAR WITH PLASTIC CAP PLS 48373 AT THE SOUTHEAST PROPERTY CORNER LMC 3/3/2023 DRAWN: HORIZONTAL SCALE (22 x 34) VERTICAL SCALE (22 x 34) JDS


CONSTRUCTION SPECIFICATIONS





WASHINGTON 99201-3343 (509) 625-6700


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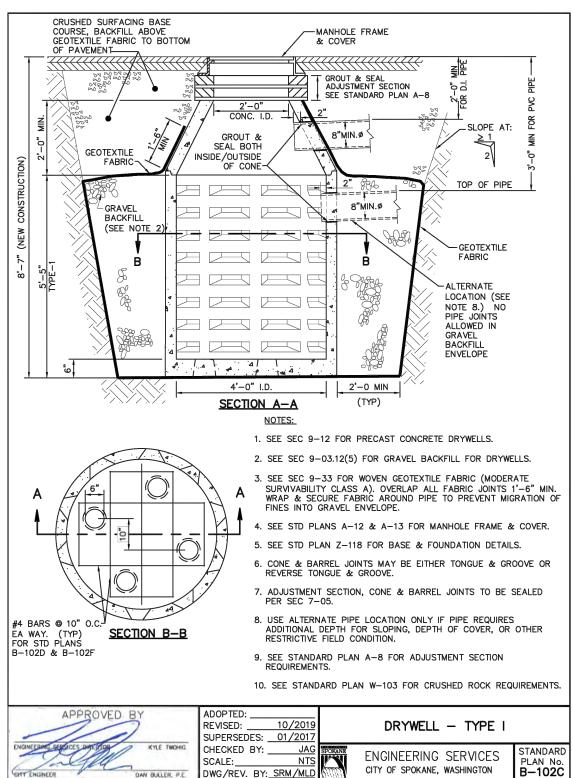


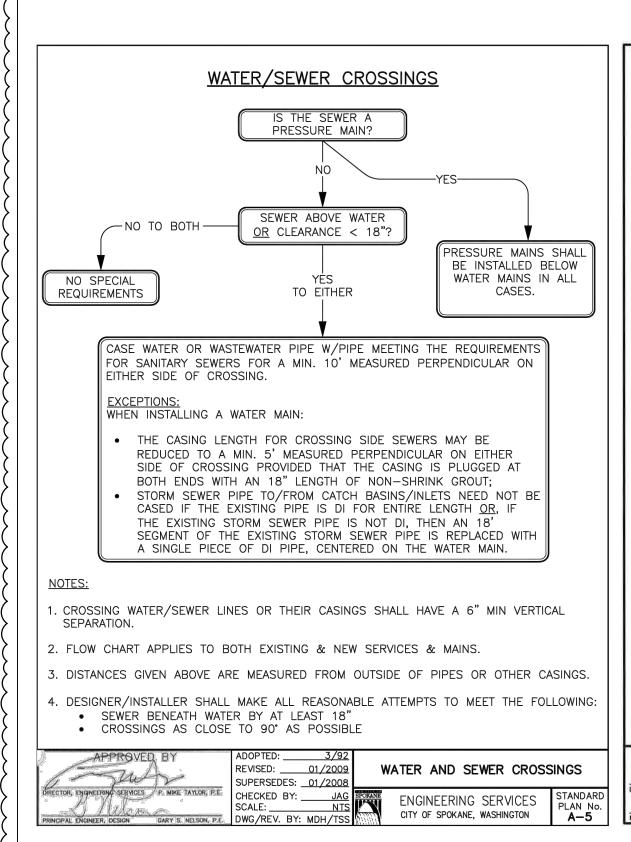

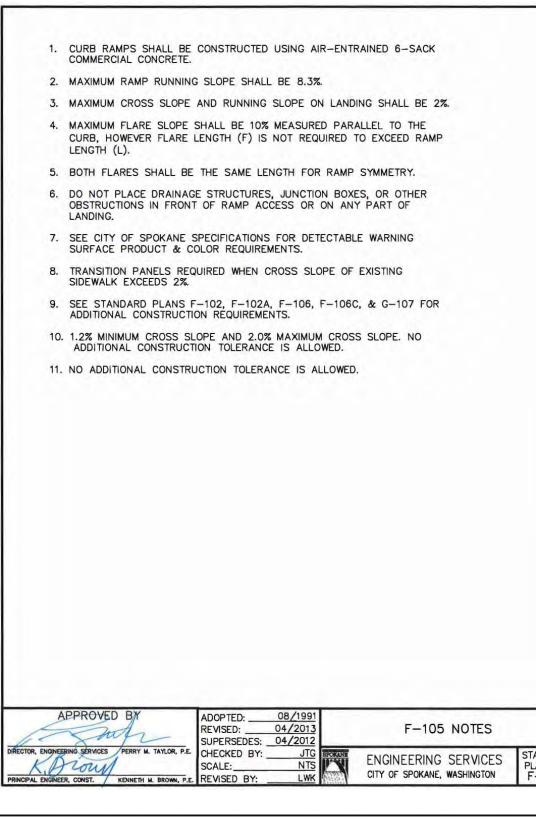


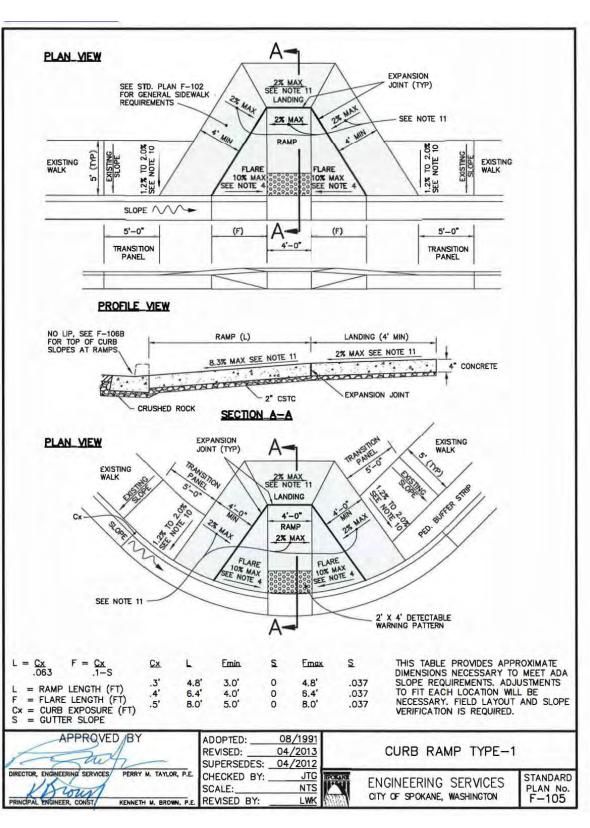


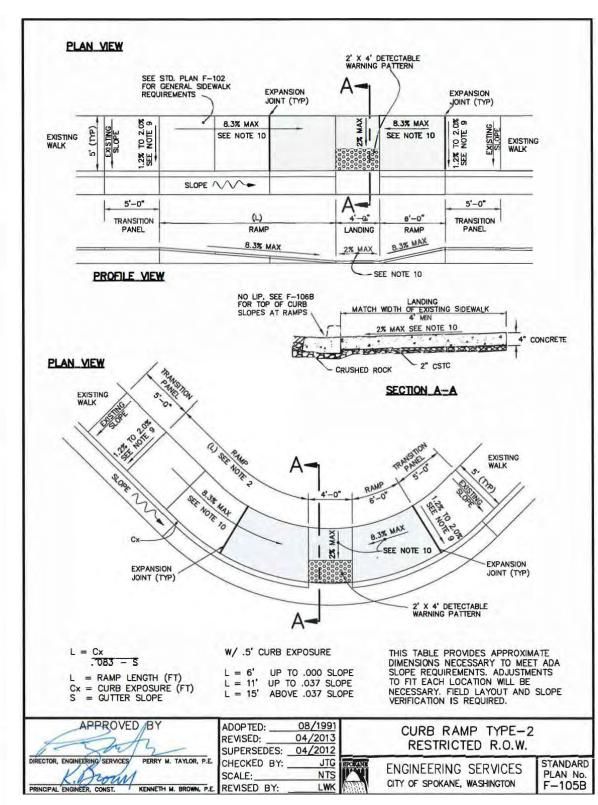


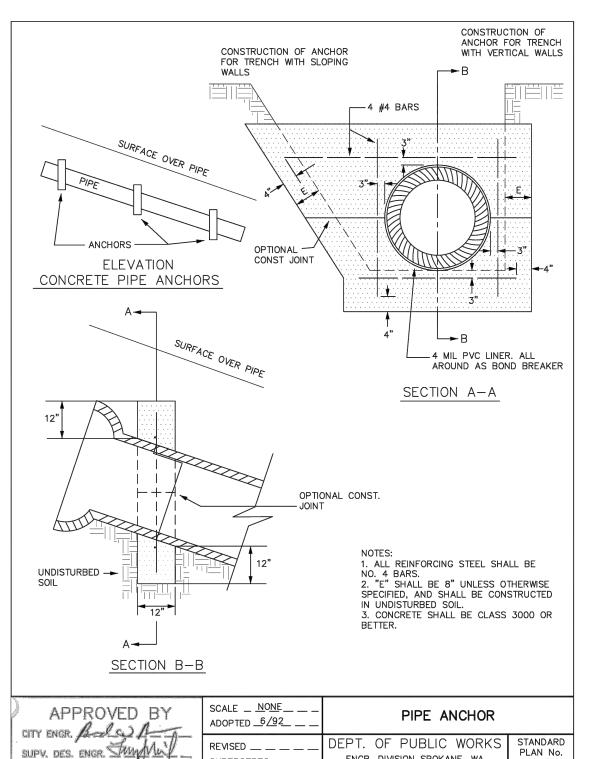

CITY OF SPOKANE, WASHINGTON

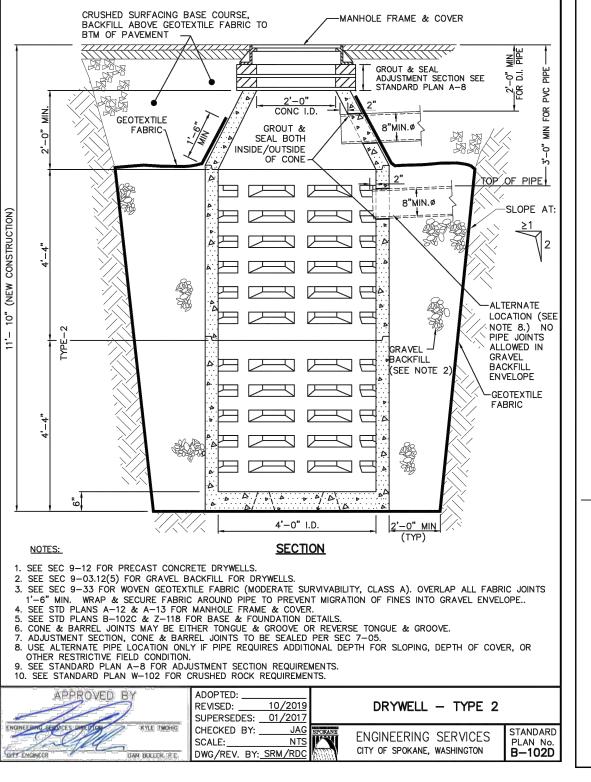


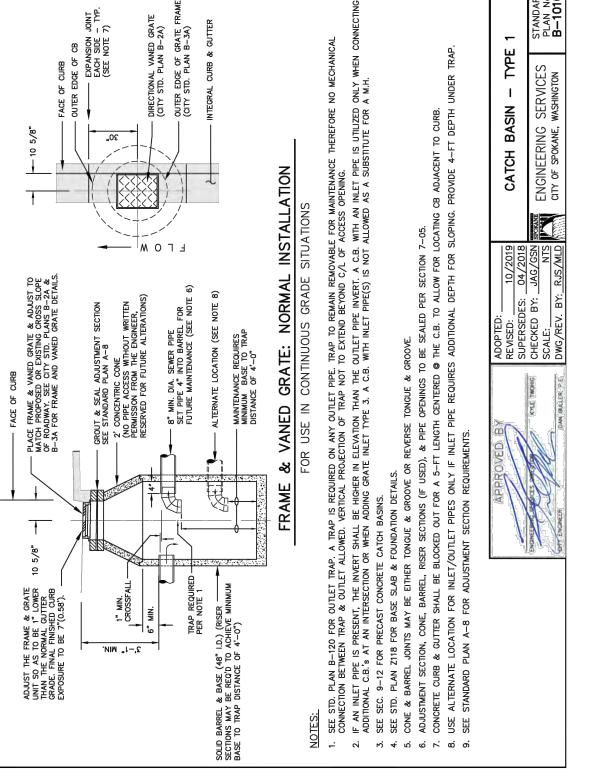

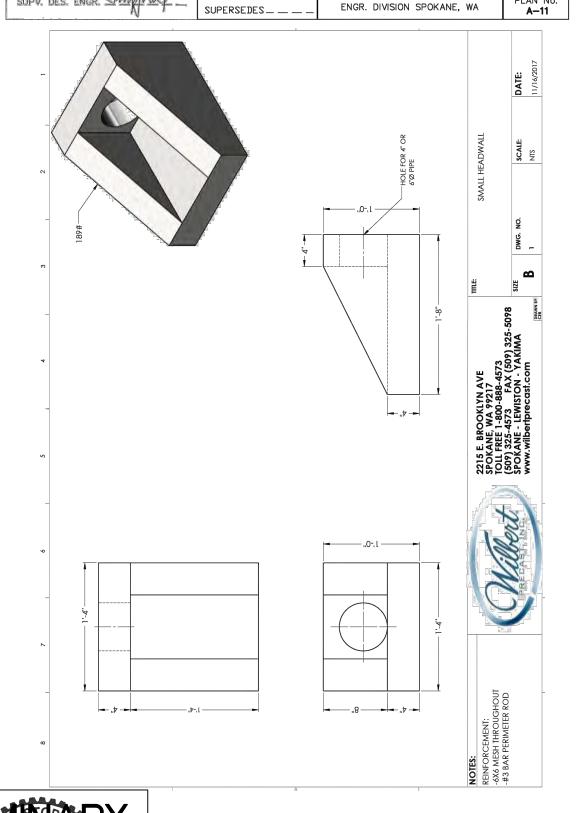







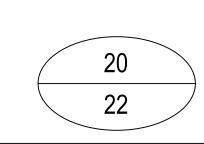


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}			25' 0' 25' 50'	BENCH MARK LOCATION: 5/8" REBAR WITH PLASTIC CAP		COLLANT	CITY OF SPOKANE, WASHINGTON	SEGMENT LIMITS:		TYPE OF IMPROVEMENT: S	SITE/DRAINAGE
}	5 / 1 / 1	NAVD88 ELEV. :1843.87	23 0 23 30	PLS 48373 AT THE SOUTHEAST PROPERTY CORNER		SPOKANE	EPARTMENT OF ENGINEERING SERVICES 808		STANDARD DETAILS	S PROJECT NO.	PLAN NO.
>	5/14/25 LC 19-342 GENERAL REVISION	CBM_NO.:		LIODIZONITAL COALE (OO ZA)	BY DATES		WEST SPOKANE FALLS BLVD. SPOKANE,				
>	4/10/24 LC 19-342 ASI #1 CONTRACTOR QUESTIONS 1	NAVD88 DATUM	SCALE IN FEET	SCALE HORIZONTAL SCALE (22 x 34) VERTICAL SCALE (22 x 34)	DRAWN: LMC 3/3/2023 APPROVED: JDS 01/19/2024	3/3/2023 WASHINGTON 99201-3343 (509) 625-670	WASHINGTON 99201-3343 (509) 625-6700	PROJECT LIMITS:	LATAH GLEN RESIDENTIAL	2023519/2023520	36-25N-42E
(DATE DATE DESCRIPTION									CALL BEFORE YOU DIG 1-800-424-5555	



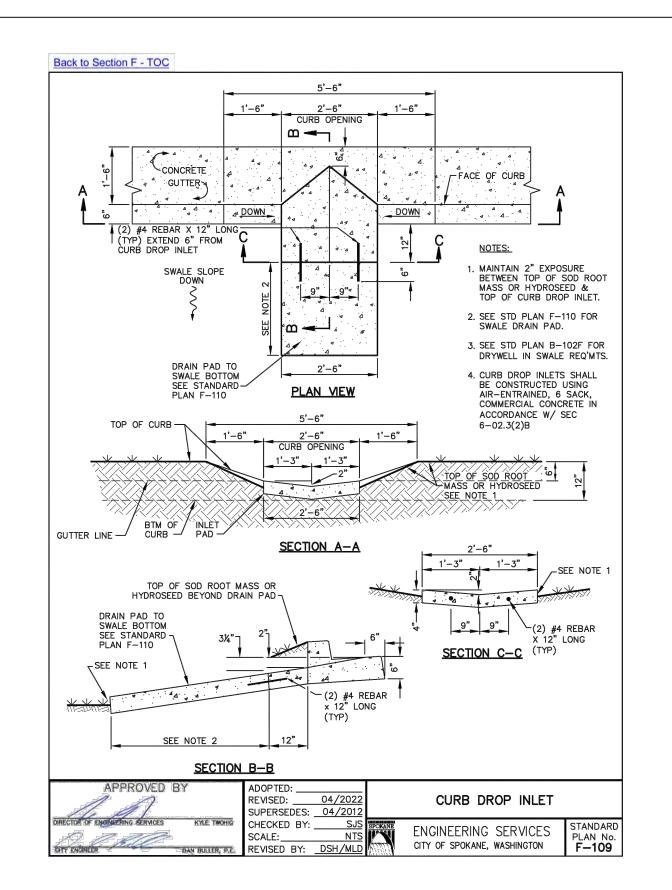


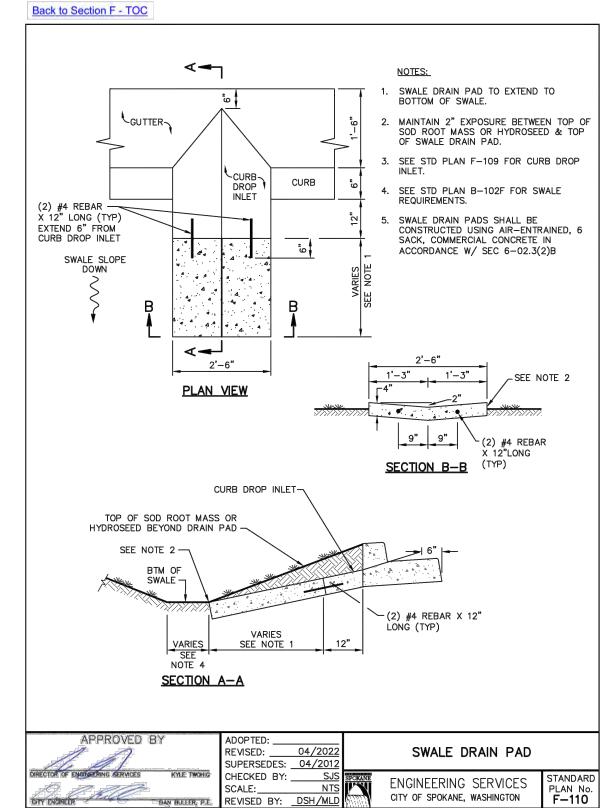

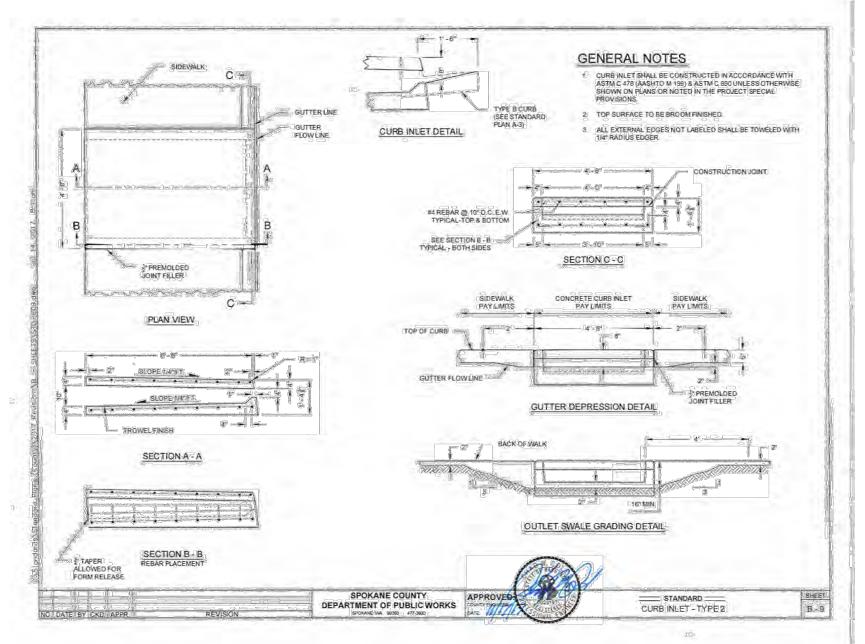





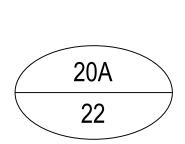

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DATE	BY	PROJECT	DESCRIPTION		


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5' 0' 25' 50'		RK LOCATION: 5/8" REBAR T AT THE SOUTHEAST PROPE
CALE IN FEET	SCALE	HORIZONTAL SCALE (VERTICAL SCALE (22


_	RK LOCATION: 5/8" REBAR WITH PLASTIC CAP AT THE SOUTHEAST PROPERTY CORNER			
			BY	DAT
SCALE	HORIZONTAL SCALE (22 x 34)	DRAWN:	LMC	3/3/20
SCALE	VERTICAL SCALE (22 x 34)	APPROVED:	JDS	01/19/2

CITY OF SPOKANE, WASHINGTON
DEPARTMENT OF ENGINEERING SERVICES 808
WEST SPOKANE FALLS BLVD. SPOKANE,
WASHINGTON 99201-3343 (509) 625-6700
17770111101011 00201 0010 (000) 020 0700

LATAH GLEN RESIDENTIAL COMMUNITY PROJECT NAME:

SEGMENT LIMITS: TYPE OF IMPROVEMENT: SITE/DRAINAGE PROJECT NO. PLAN NO. STANDARD DETAILS 2023519/2023520 36-25N-42E PROJECT LIMITS: LATAH GLEN RESIDENTIAL

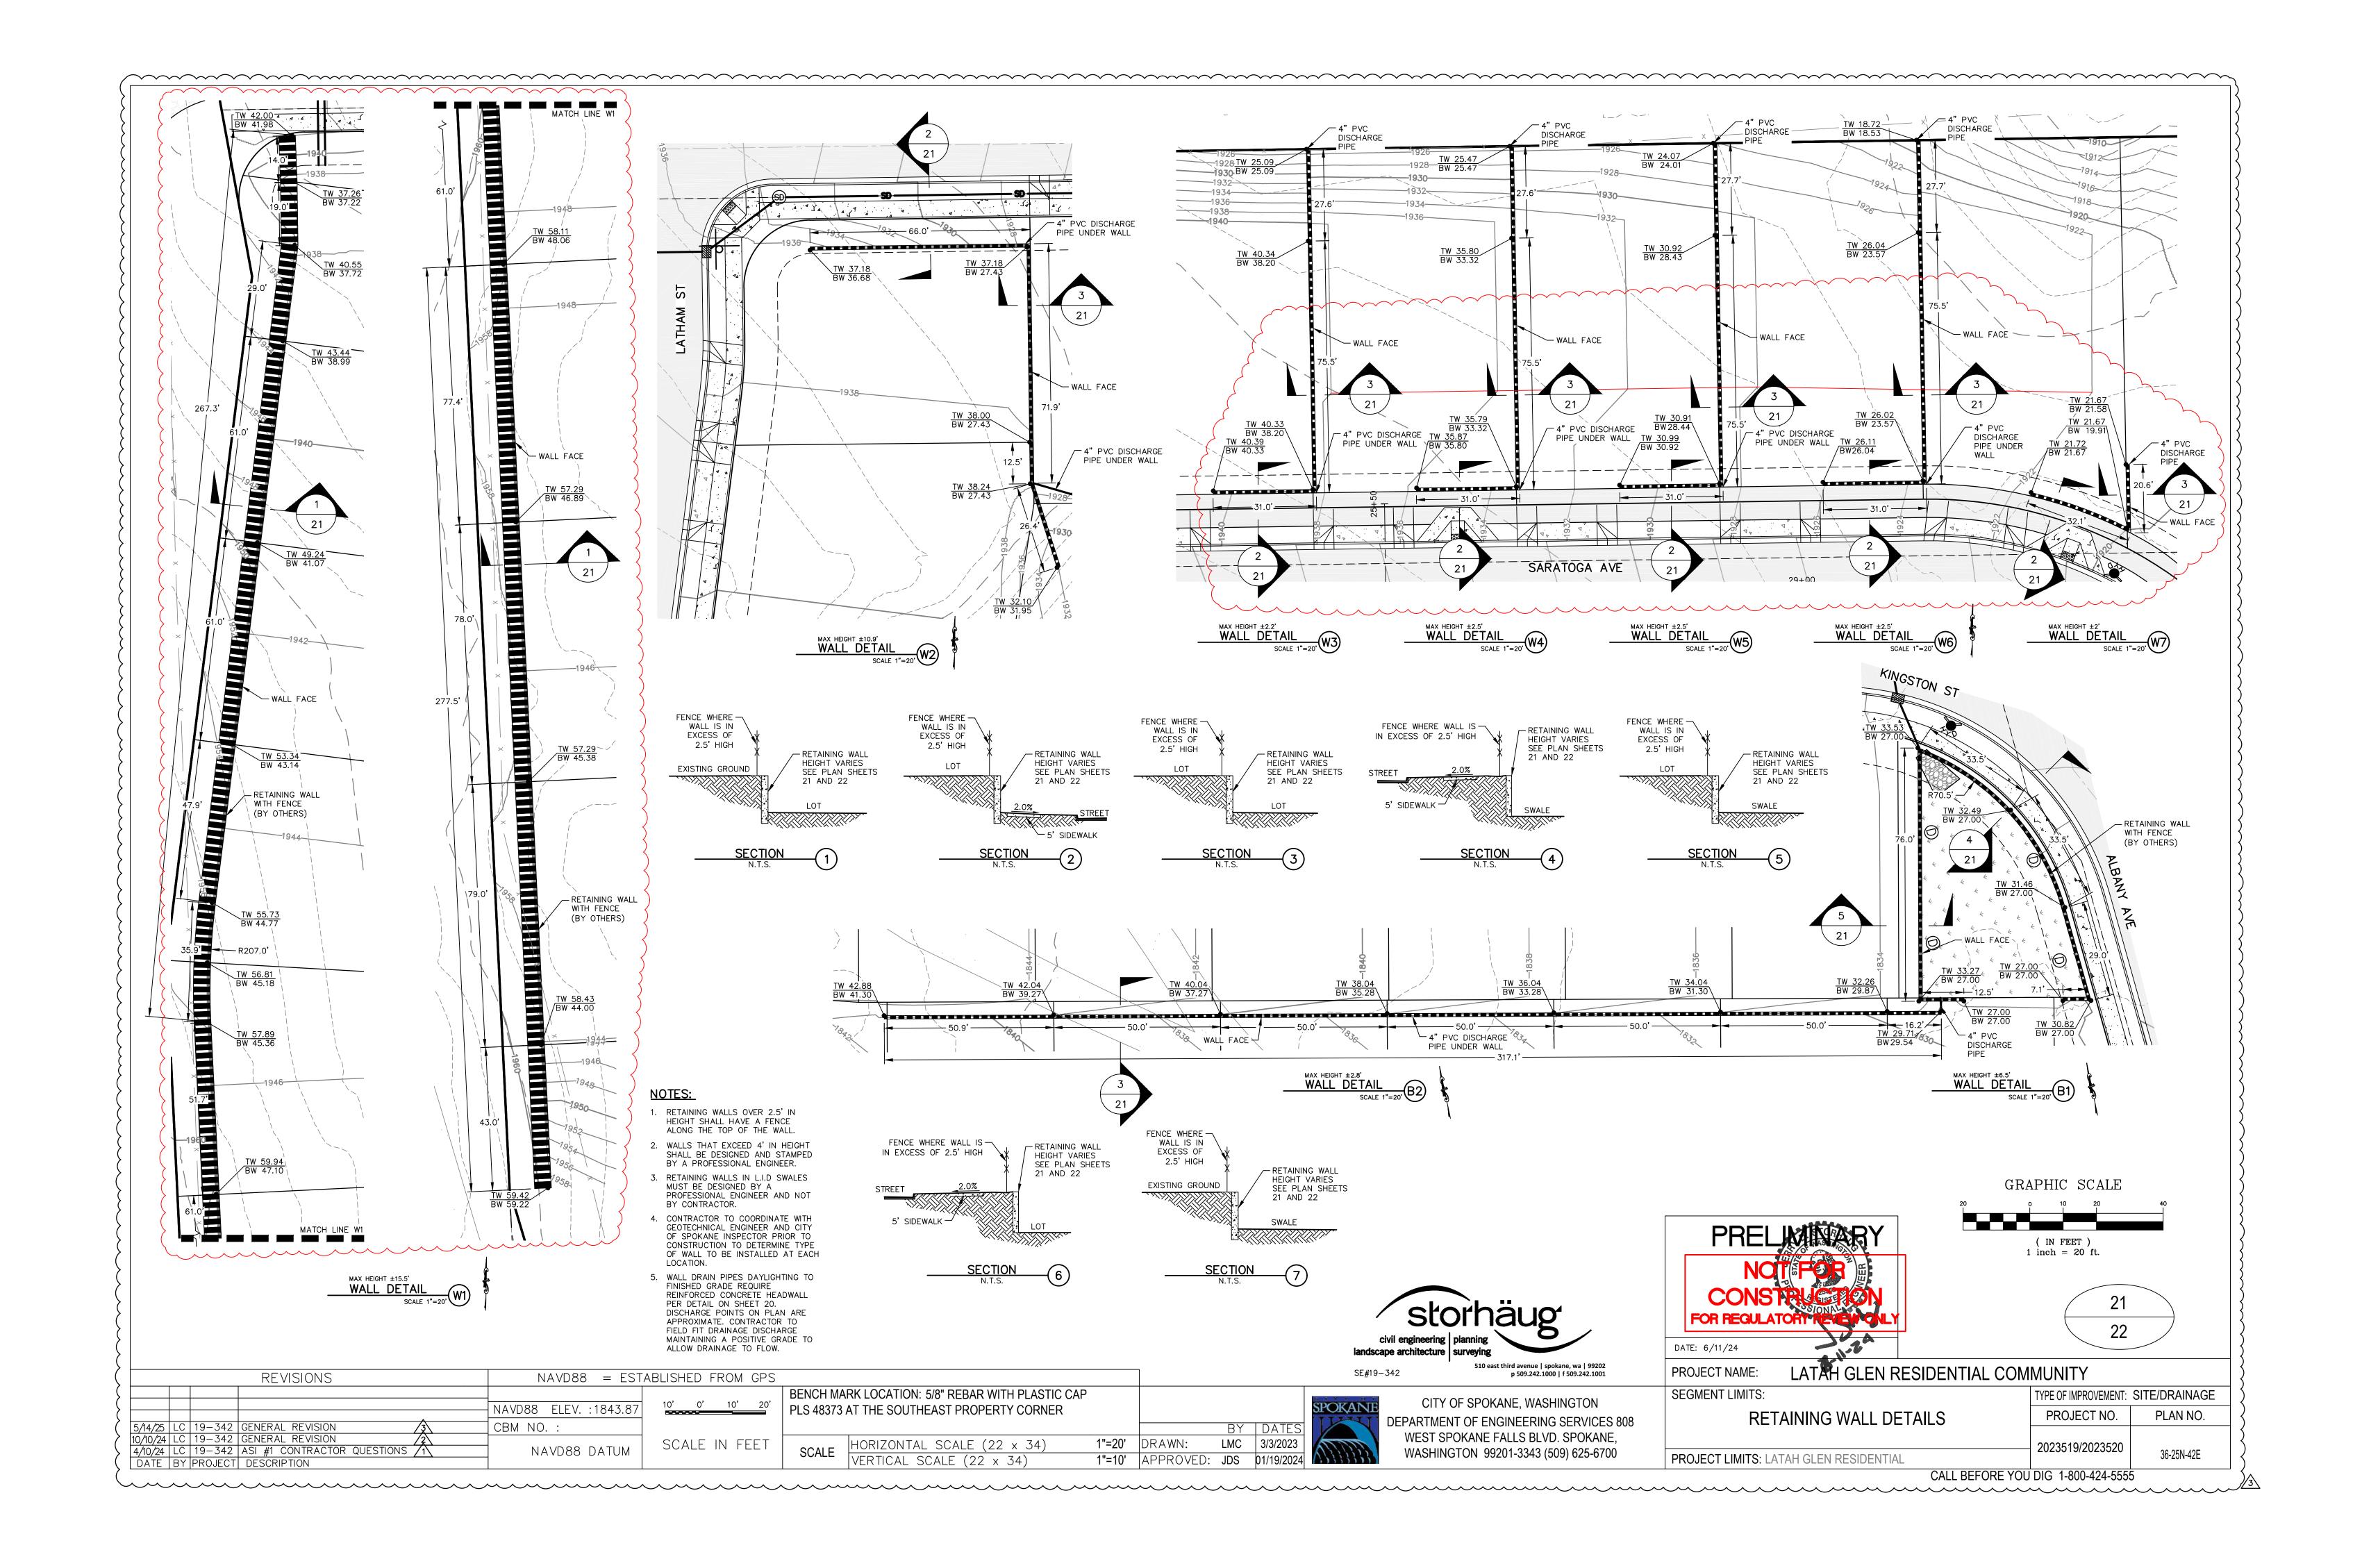

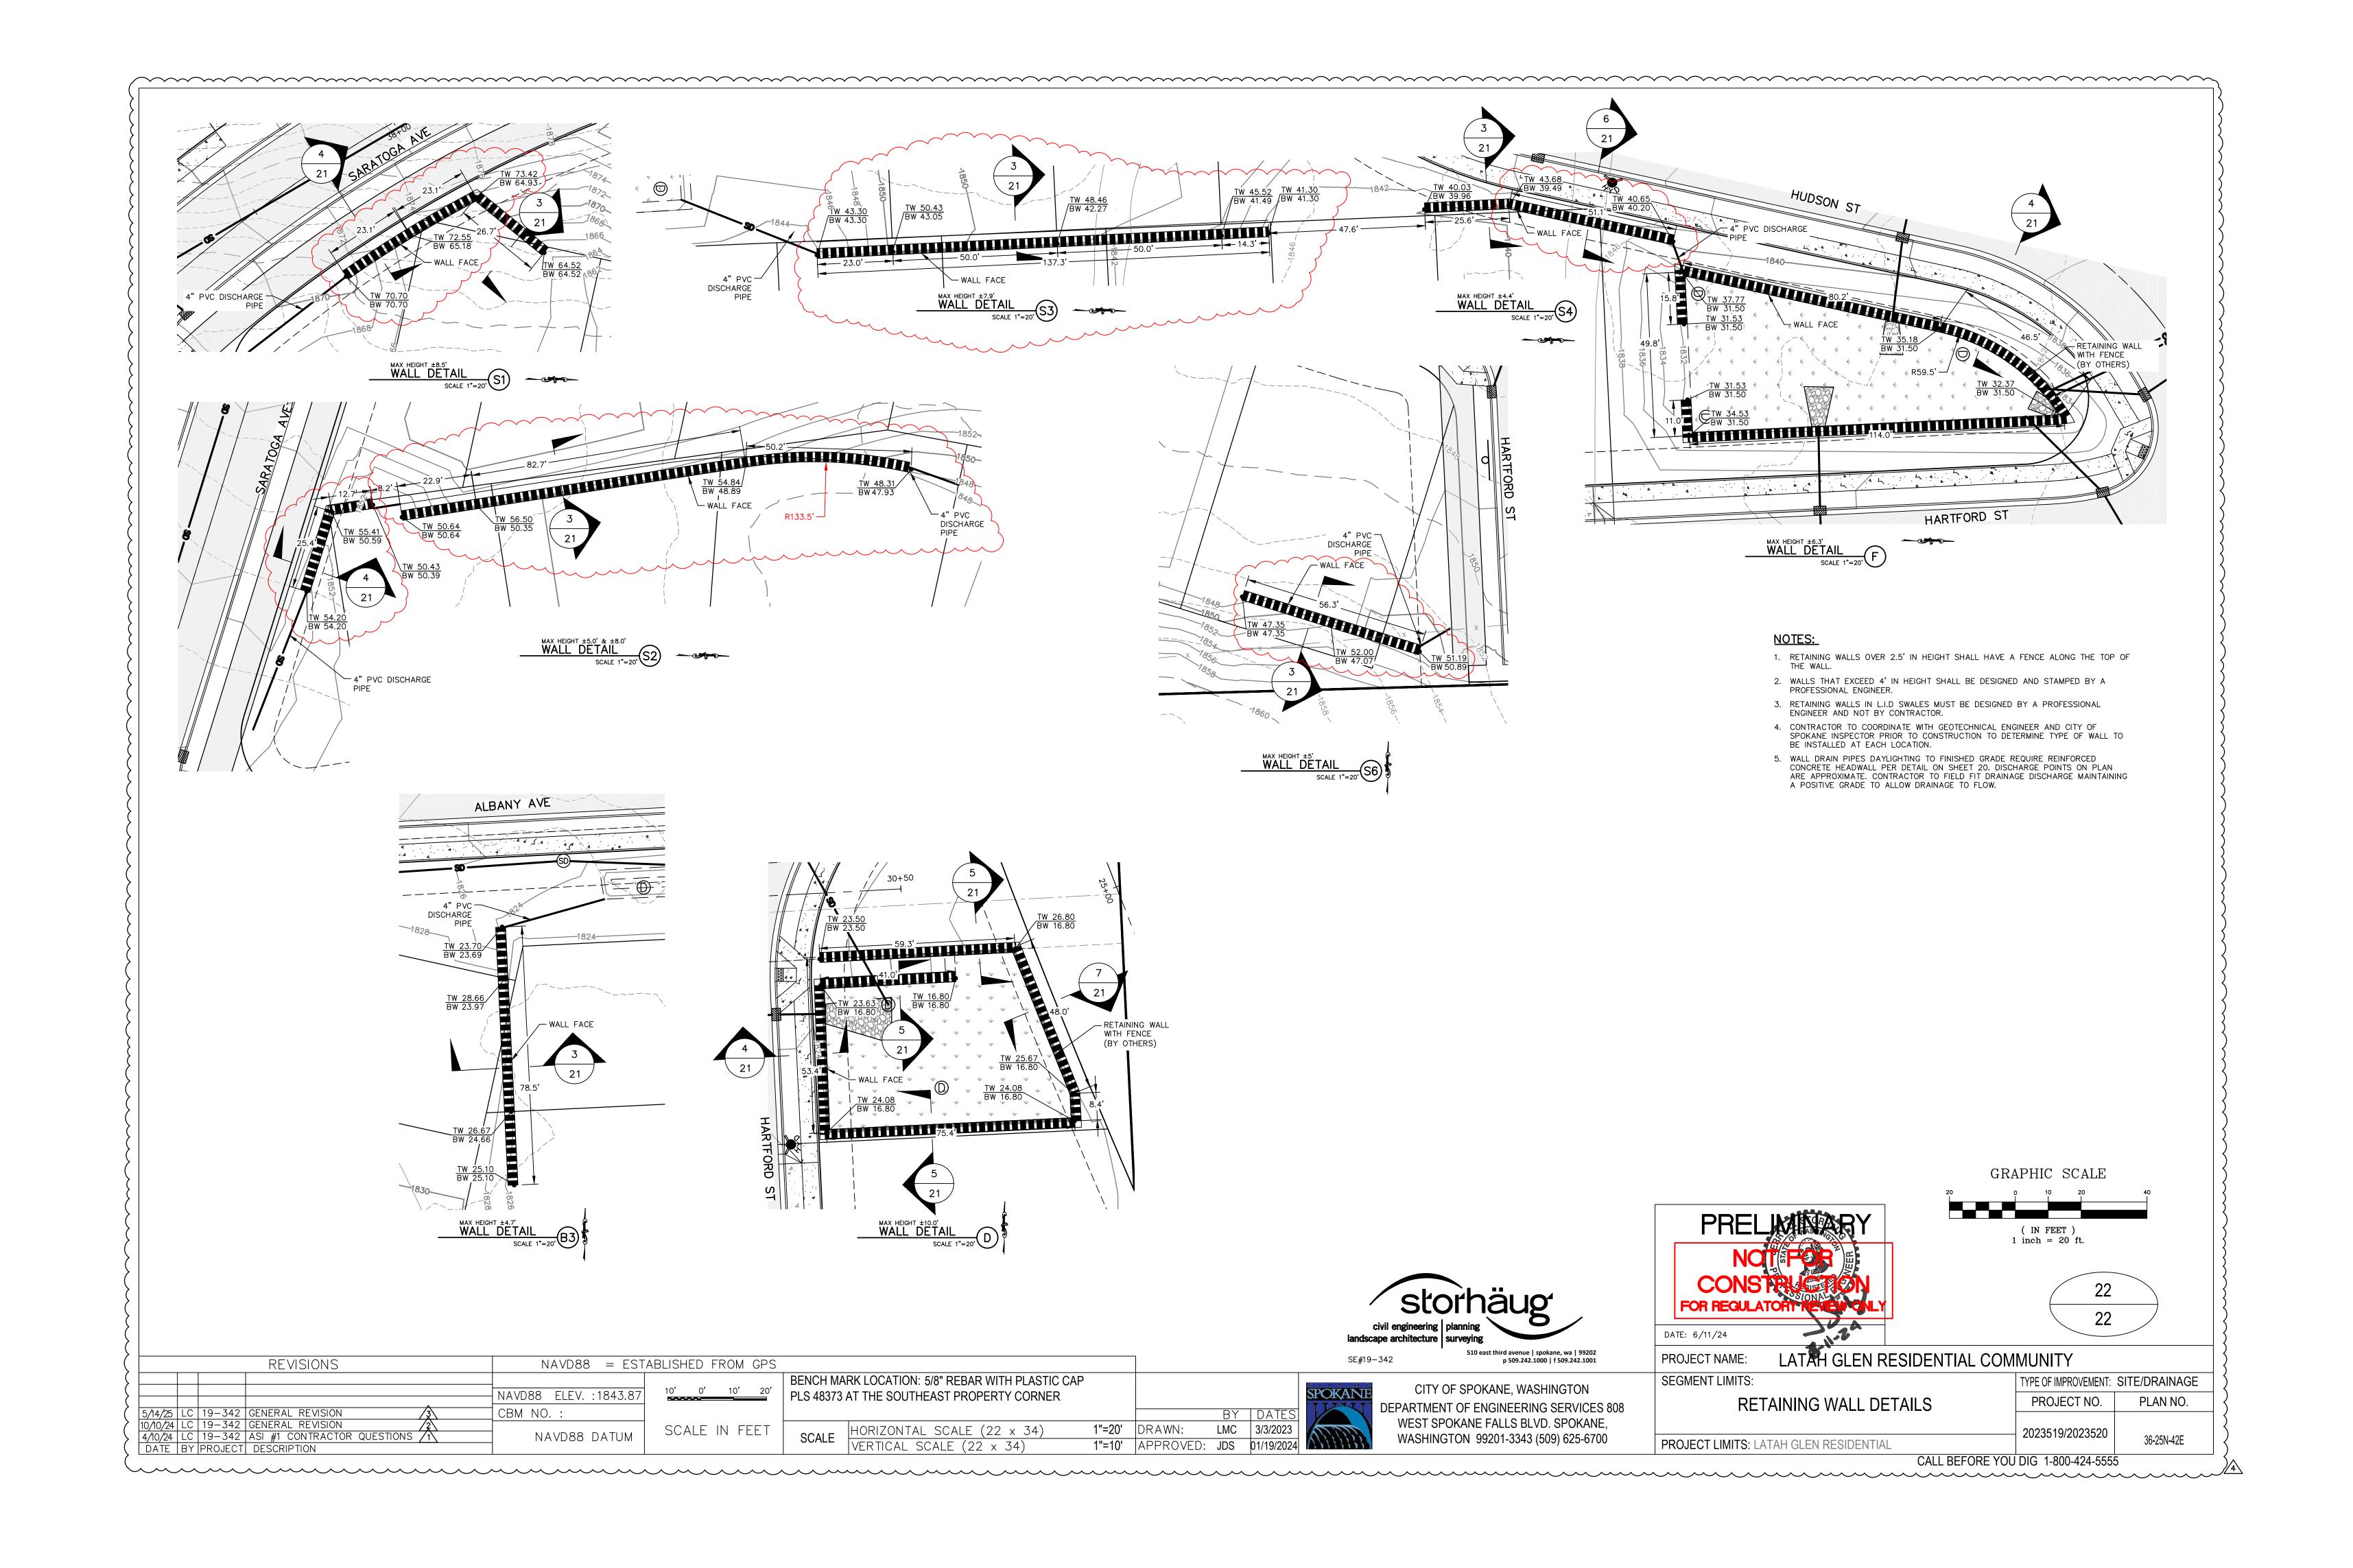

SANITARY SEWER IMPROVEMENTS

LATAH GLEN RESIDENTIAL COMMUNITY

SECTION 36, TOWNSHIP 25 NORTH, RANGE 42 EAST, W.M., CITY OF SPOKANE, SPOKANE COUNTY, WASHINGTON

GENERAL NOTES

- THE CONTRACTOR SHALL BE RESPONSIBLE FOR OBTAINING ALL NECESSARY PERMITS FROM ALL APPLICABLE AGENCIES. THE CONTRACTOR SHALL NOTIFY THE CITY OF SPOKANE PUBLIC WORKS INSPECTOR AT LEAST 48 HOURS PRIOR TO THE START OF ANY EARTH DISTURBING ACTIVITY, OR CONSTRUCTION ON ANY AND ALL SEWER AND WATER
- 2. THE CONTRACTOR SHALL COORDINATE AND COOPERATE WITH THE CITY OF SPOKANE, SPOKANE COUNTY AND ALL UTILITY COMPANIES INVOLVED WITH REGARD TO RELOCATIONS OR ADJUSTMENTS OF EXISTING UTILITIES DURING CONSTRUCTION AND TO ASSURE THAT THE WORK IS ACCOMPLISHED IN A TIMELY FASHION AND WITH A MINIMUM DISRUPTION OF SERVICE. THE CONTRACTOR SHALL BE RESPONSIBLE FOR CONTACTING ALL PARTIES AFFECTED BY ANY DISRUPTION OF ANY UTILITY SERVICE.
- 3. THE CONTRACTOR SHALL HAVE ONE (1) SIGNED COPY OF THE APPROVED PLANS, ONE (1) COPY OF THE APPROPRIATE STANDARDS AND SPECIFICATIONS, AND A COPY OF ANY PÉRMITS AND EXTENSION AGREEMENTS NEEDED FOR THE JOB ON-SITE AT ALL TIMES.
- 4. IF, DURING THE CONSTRUCTION PROCESS, CONDITIONS ARE ENCOUNTERED BY THE CONTRACTOR, HIS SUBCONTRACTORS, OR OTHER AFFECTED PARTIES, WHICH COULD INDICATE A SITUATION THAT IS NOT IDENTIFIED IN THE PLANS OR SPECIFICATIONS, THE CONTRACTOR SHALL CONTACT THE ENGINEER IMMEDIATELY.
- 5. THE CONTRACTOR SHALL SUBMIT A TRAFFIC CONTROL PLAN IN ACCORDANCE WITH M.U.T.C.D. TO THE APPROPRIATE RIGHT-OF-WAY AUTHORITY (CITY, COUNTY, OR STATE) FOR APPROVAL PRIOR TO ANY CONSTRUCTION ACTIVITIES WITHIN, OR AFFECTING, THE RIGHT-OF-WAY. THE CONTRACTOR SHALL BE RESPONSIBLE FOR PROVIDING ANY AND ALL TRAFFIC CONTROL DEVICES AS MAY BE REQUIRED BY THE CONSTRUCTION ACTIVITIES.
- 6. THE CONTRACTOR SHALL BE RESPONSIBLE FOR KEEPING ROADWAYS FREE AND CLEAR OF ALL CONSTRUCTION DEBRIS AND DIRT TRACKED FROM THE SITE.
- 7. THE CONTRACTOR SHALL BE RESPONSIBLE FOR RECORDING AS-BUILT INFORMATION ON A SET OF RECORD DRAWINGS KEPT AT THE CONSTRUCTION SITE, AND MADE AVAILABLE TO THE CITY OF SPOKANE PUBLIC WORKS INSPECTOR AT ALL TIMES.
- 8. ALL STRUCTURAL EROSION CONTROL MEASURES SHALL BE INSTALLED, AT THE LIMITS OF CONSTRUCTION, PRIOR TO ANY OTHER GROUND-DISTURBING ACTIVITY. ALL EROSION CONTROL MEASURES SHALL BE MAINTAINED IN GOOD REPAIR BY THE CONTRACTOR, UNTIL SUCH TIME AS THE ENTIRE DISTURBED AREAS ARE STABILIZED WITH HARD SURFACE OR LANDSCAPING.
- 9. ALL WORK WITHIN THE PUBLIC RIGHT-OF-WAY IS SUBJECT TO THE JURISDICTION OF
- 10. ALL OPERATIONS CONDUCTED ON THE PREMISES, INCLUDING THE WARMING UP, REPAIR, ARRIVAL, DEPARTURE OR RUNNING OF TRUCKS, EARTHMOVING EQUIPMENT, CONSTRUCTION EQUIPMENT AND ANY OTHER ASSOCIATED EQUIPMENT SHALL GENERALLY BE LIMITED TO THE PERIOD BETWEEN 7:00 A.M. AND 10:00 P.M. WEEKDAYS, 9:00AM AND 10:00PM WEEKENDS, UNLESS OTHERWISE APPROVED BY THE COUNTY.
- 11. NO REVISIONS SHALL BE MADE TO THESE PLANS WITHOUT THE APPROVAL OF THE CITY ENGINEER AND NOTIFICATION OF THE ENGINEER OF RECORD.
- 12. STATIONING AND OFFSET IS BASED ON STATIONING FOR THE REFERENCED STREET ALIGNMENT.
- 13. EXISTING UTILITIES CONFLICTING WITH PROPOSED IMPROVEMENTS SHALL BE RELOCATED AS NEED PRIOR TO CONSTRUCTION. COORDINATE WITH APPLICABLE UTILITY COMPANY.
- 14. RESTRAINTS SHALL BE INSTALLED ON ALL PRESSURE PIPELINES IN ACCORDANCE WITH CITY OF SPOKANE STANDARDS. REFER TO RESTRAINED JOINT TABLE ON THESE PLANS.

GENERAL SEWER NOTES

UNLESS SPECIFICALLY EXCEPTED IN THE PLANS OR CONTRACT DOCUMENTS ALL CONSTRUCTION METHODS AND MATERIALS SHALL BE IN ACCORDANCE WITH CURRENT STANDARD SPECIFICATIONS AND STANDARD PLANS FOR ROAD, BRIDGE, AND MUNICIPAL CONSTRUCTION PROMULGATED BY THE WASHINGTON STATE DEPARTMENT OF TRANSPORTATION AND THE WASHINGTON CHAPTER OF THE AMERICAN PUBLIC WORKS ASSOCIATION, (LATEST EDITION) & CITY OF SPOKANE SUPPLEMENTAL SPECIFICATIONS.

THE CONTRACTOR SHALL PROVIDE ALL MATERIALS, LABOR AND EQUIPMENT TO CONSTRUCT AND INSTALL TO PROPER WORKING ORDER ALL IMPROVEMENTS AS DETAILED OR CALLED OUT IN THESE PLANS

3. THE PLANS ARE SCHEMATIC AND ARE NOT INTENDED TO DEPICT ALL DETAILS OF THE WORK REQUIRED. THE CONTRACTOR SHALL BE RESPONSIBLE TO FAMILIARIZE HIMSELF WITH ACTUAL SITE CONDITIONS REQUIREMENTS AND FACTORS AFFECTING THE WORK. WHERE LACK OF DETAIL OR CONFLICTS EXISTS BETWEEN THESE AND OTHER PLANS, THE CONTRACTOR SHALL NOTIFY THE OWNER TO RESOLVE THE ISSUE PRIOR TO PROCEEDING.

4. THE CONTRACTOR IS RESPONSIBLE FOR PROVIDING ALL LABOR AND MATERIALS NECESSARY FOR THE COMPLETION OF THE INTENDED IMPROVEMENTS SHOWN ON THESE DRAWINGS OR DESIGNATED TO BE PROVIDED, INSTALLED OR CONSTRUCTED UNLESS SPECIFICALLY NOTED OTHERWISE.

5. EXCAVATION AND EMBANKMENT SHALL BE IN ACCORDANCE WITH APPLICABLE REQUIREMENTS OF SECTION 2-03 OF THE WSDOT STANDARD SPECIFICATIONS. ALL COMPACTION SHALL BE IN ACCORDANCE WITH SECTION 2-03.3(14)C, METHOD B, OF THE STANDARD SPECIFICATION.

6. THESE PLANS MAY NOT SHOW ALL EXISTING UTILITIES. EXISTING UTILITY LOCATIONS SHOWN ARE APPROXIMATE ONLY. IT IS THE CONTRACTORS RESPONSIBILITY TO VERIFY THE EXISTENCE AND ACTUAL LOCATION OF ALL UTILITIES PRIOR TO CONSTRUCTION.

7. SHORING AND CRIBBING FOR UTILITY CONSTRUCTION SHALL BE IN ACCORDANCE WITH APPLICABLE REQUIREMENTS OF SECTION 2-09 OF THE STANDARD SPECIFICATIONS.

8. ALL PIPE BEDDING SHALL BE IN ACCORDANCE WITH THE CURRENT EDITION OF


CONSTRUCTION SPECIFICATIONS FOR SEWER LINES AS ADOPTED BY THE CITY OF SPOKANE. 9. ALL BACKFILL MATERIAL SHALL BE IN ACCORDANCE WITH THE CURRENT EDITION OF CONSTRUCTION SPECIFICATIONS FOR SEWER LINES AS ADOPTED BY THE CITY OF SPOKANE.

10. MARKING TAPE WILL BE PLACED IN THE EXCAVATION TRENCH AT MID-DEPTH LOCATION FOR ALL UNDERGROUND SEWER PIPE INSTALLATIONS FOR THE PURPOSE OF ALERTING ANY FUTURE EXCAVATION IN THE SPECIFIC AREA.


11. AREAS WHICH REQUIRE THE PLACEMENT OF EMBANKMENT IN ORDER TO INSTALL SEWER, (I.E; PIPELINE INVERTS ARE ABOVE EXISTING GROUND ELEVATIONS) SHALL BE CONSTRUCTED PER THESE SPECIFICATIONS TO AN ELEVATION THREE (3) FEET ABOVE THE TOP OF PROPOSED PIPE. AT THIS POINT, TRENCHING AND BACKFILL FOR PLACEMENT OF WATER AND SEWER MAY BEGIN.

12. ALL SLEEVING OF SEWER LINES, IF NECESSARY, SHALL BE PER THE CITY OF SPOKANE STANDARD A-5.

13. MANHOLE FABRICATION IS TO BE PER CITY OF SPOKANE STD. PLAN Z-111. 14. CONTRACTOR TO CONSTRUCT CUT-OFF WALLS WHERE DETERMINED BY THE CITY FIELD ENGINEER PER PLAN NO. B-19.

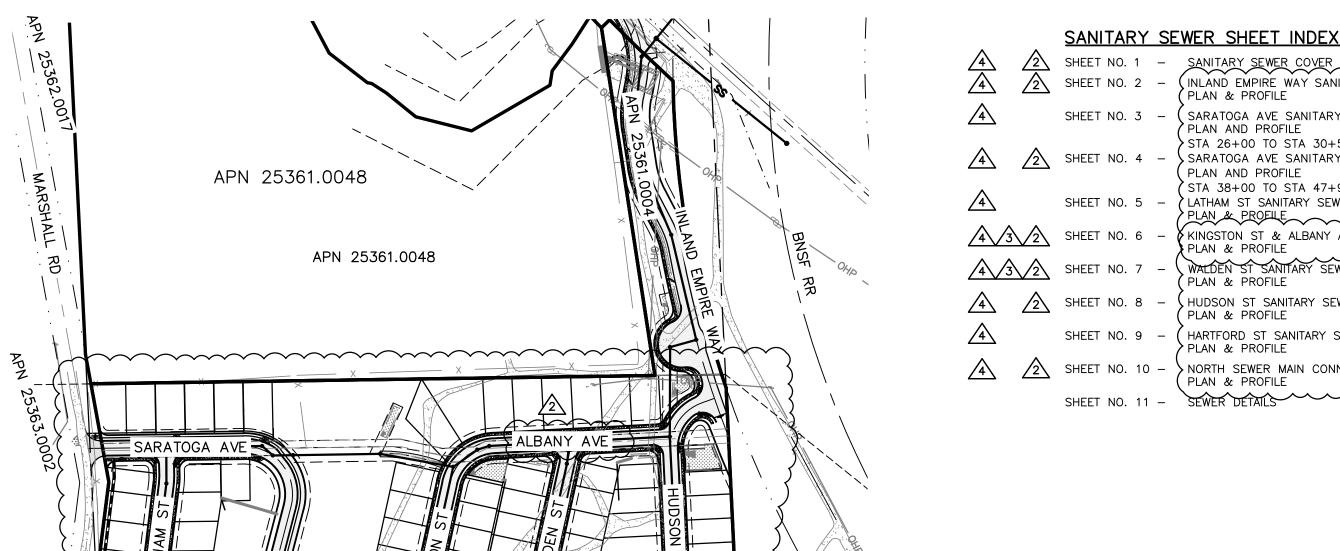

INLAND EMPIRE WAY SANITARY SEWER PLAN & PROFILE (SARATOGA AVE SANITARY SEWER PLAN AND PROFILE STA 26+00 TO STA 30+50 SARATOGA AVE SANITARY SEWER PLAN AND PROFILE STA 38+00 TO STA 47+92 LATHAM ST SANITARY SEWER PLAN & PROFILE KINGSTON ST & ALBANY AVE SANITARY SEWER PLAN & PROFILE WALDEN ST SANITARY SEWER HUDSON ST SANITARY SEWER PLAN & PROFILE (HARTFORD ST SANITARY SEWER PLAN & PROFILE NORTH SEWER MAIN CONNECTION PLAN & PROFILE SHEET NO. 11 - SEWER DETAILS

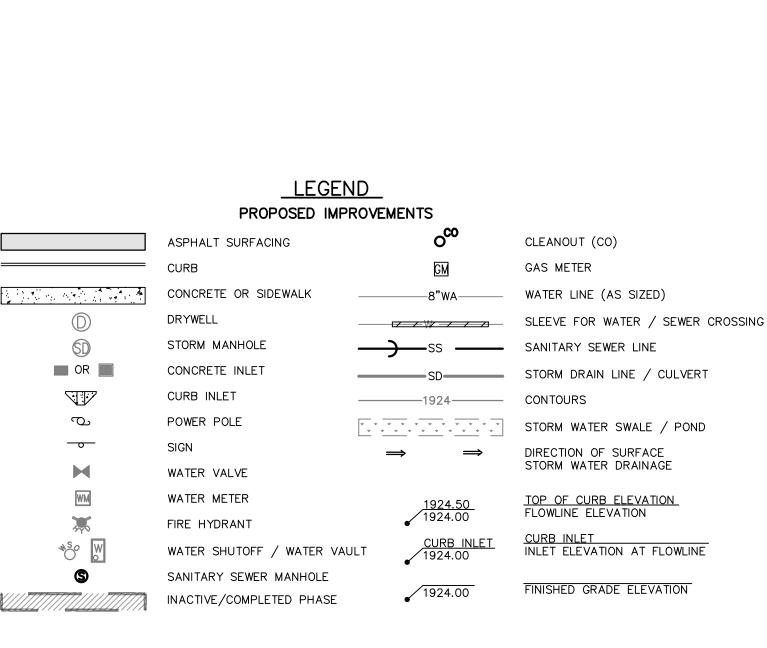

VICINITY MAP



<u>LEGEND</u>

= = = = = = CURB

4 4 4

APN 25364.0018

5/8" REBAR WITH

PLASTIC CAP

EXISTING FEATURES

ASPHALT SURFACING

SIDEWALK OR CONCRETE

POWER POLE/TELEPHONE POLE

TELEPHONE ENCLOSURE

SANITARY SEWER MANHOLE

ELECTRICAL TRANSFORMER

GRAVEL

DRYWELL

STORM MANHOLE

CATCH BASIN

WATER VALVE

FIRE HYDRANT

LIGHT POLE

UTILITY VAULT

WATER LINE

SIGN

SANITARY SEWER LINE


------ SD ------ STORM DRAIN LINE / CULVERT


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CALL BEFORE YOU DIG 1-800-424-5555


REVISIONS NAVD88 = ESTABLISHED FROM GPS SE#19-342 SE#19-342 SE#19-342 SE#19-342 SEMONO INVESTIGATION IN SECULAR IN				landscape architecture surveying	DATE: 6/11/24		
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DEPARTMENT OF ENGINEERING SERVICES 808 SANITARY SEWER COVER PROJECT NO. PROJECT				CITY OF SPOKANE WASHINGTON	SEGMENT LIMITS:	TYPE OF IMPROVEMENT:	SEWER
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Y 4/10/24 LC 19-342 ASI #1 CONTRACTOR QUESTIONS /1 NAVD88 DATUM SCALE (22 x 34) WASHINGTON 99201-3343 (509) 625-6700 PROJECT LIMITS: LATAH GLEN RESIDENTIAL WASHINGTON 99201-3343 (509) 625-6700	(4/10/24 LC 19-342 ASI #1 CONTRACTOR QUESTIONS /1 DATE BY PROJECT DESCRIPTION	NAVD88 DATUM SCALE IN FEET SCALE HORIZO		WASHINGTON 99201-3343 (509) 625-6700		2023517	36-25N-42E


APN 25364.0004

GRAPHIC SCALE

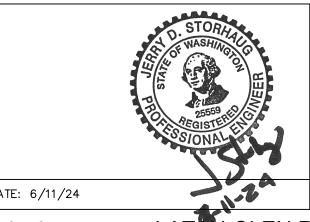(IN FEET)

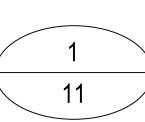1 inch = 200 ft.

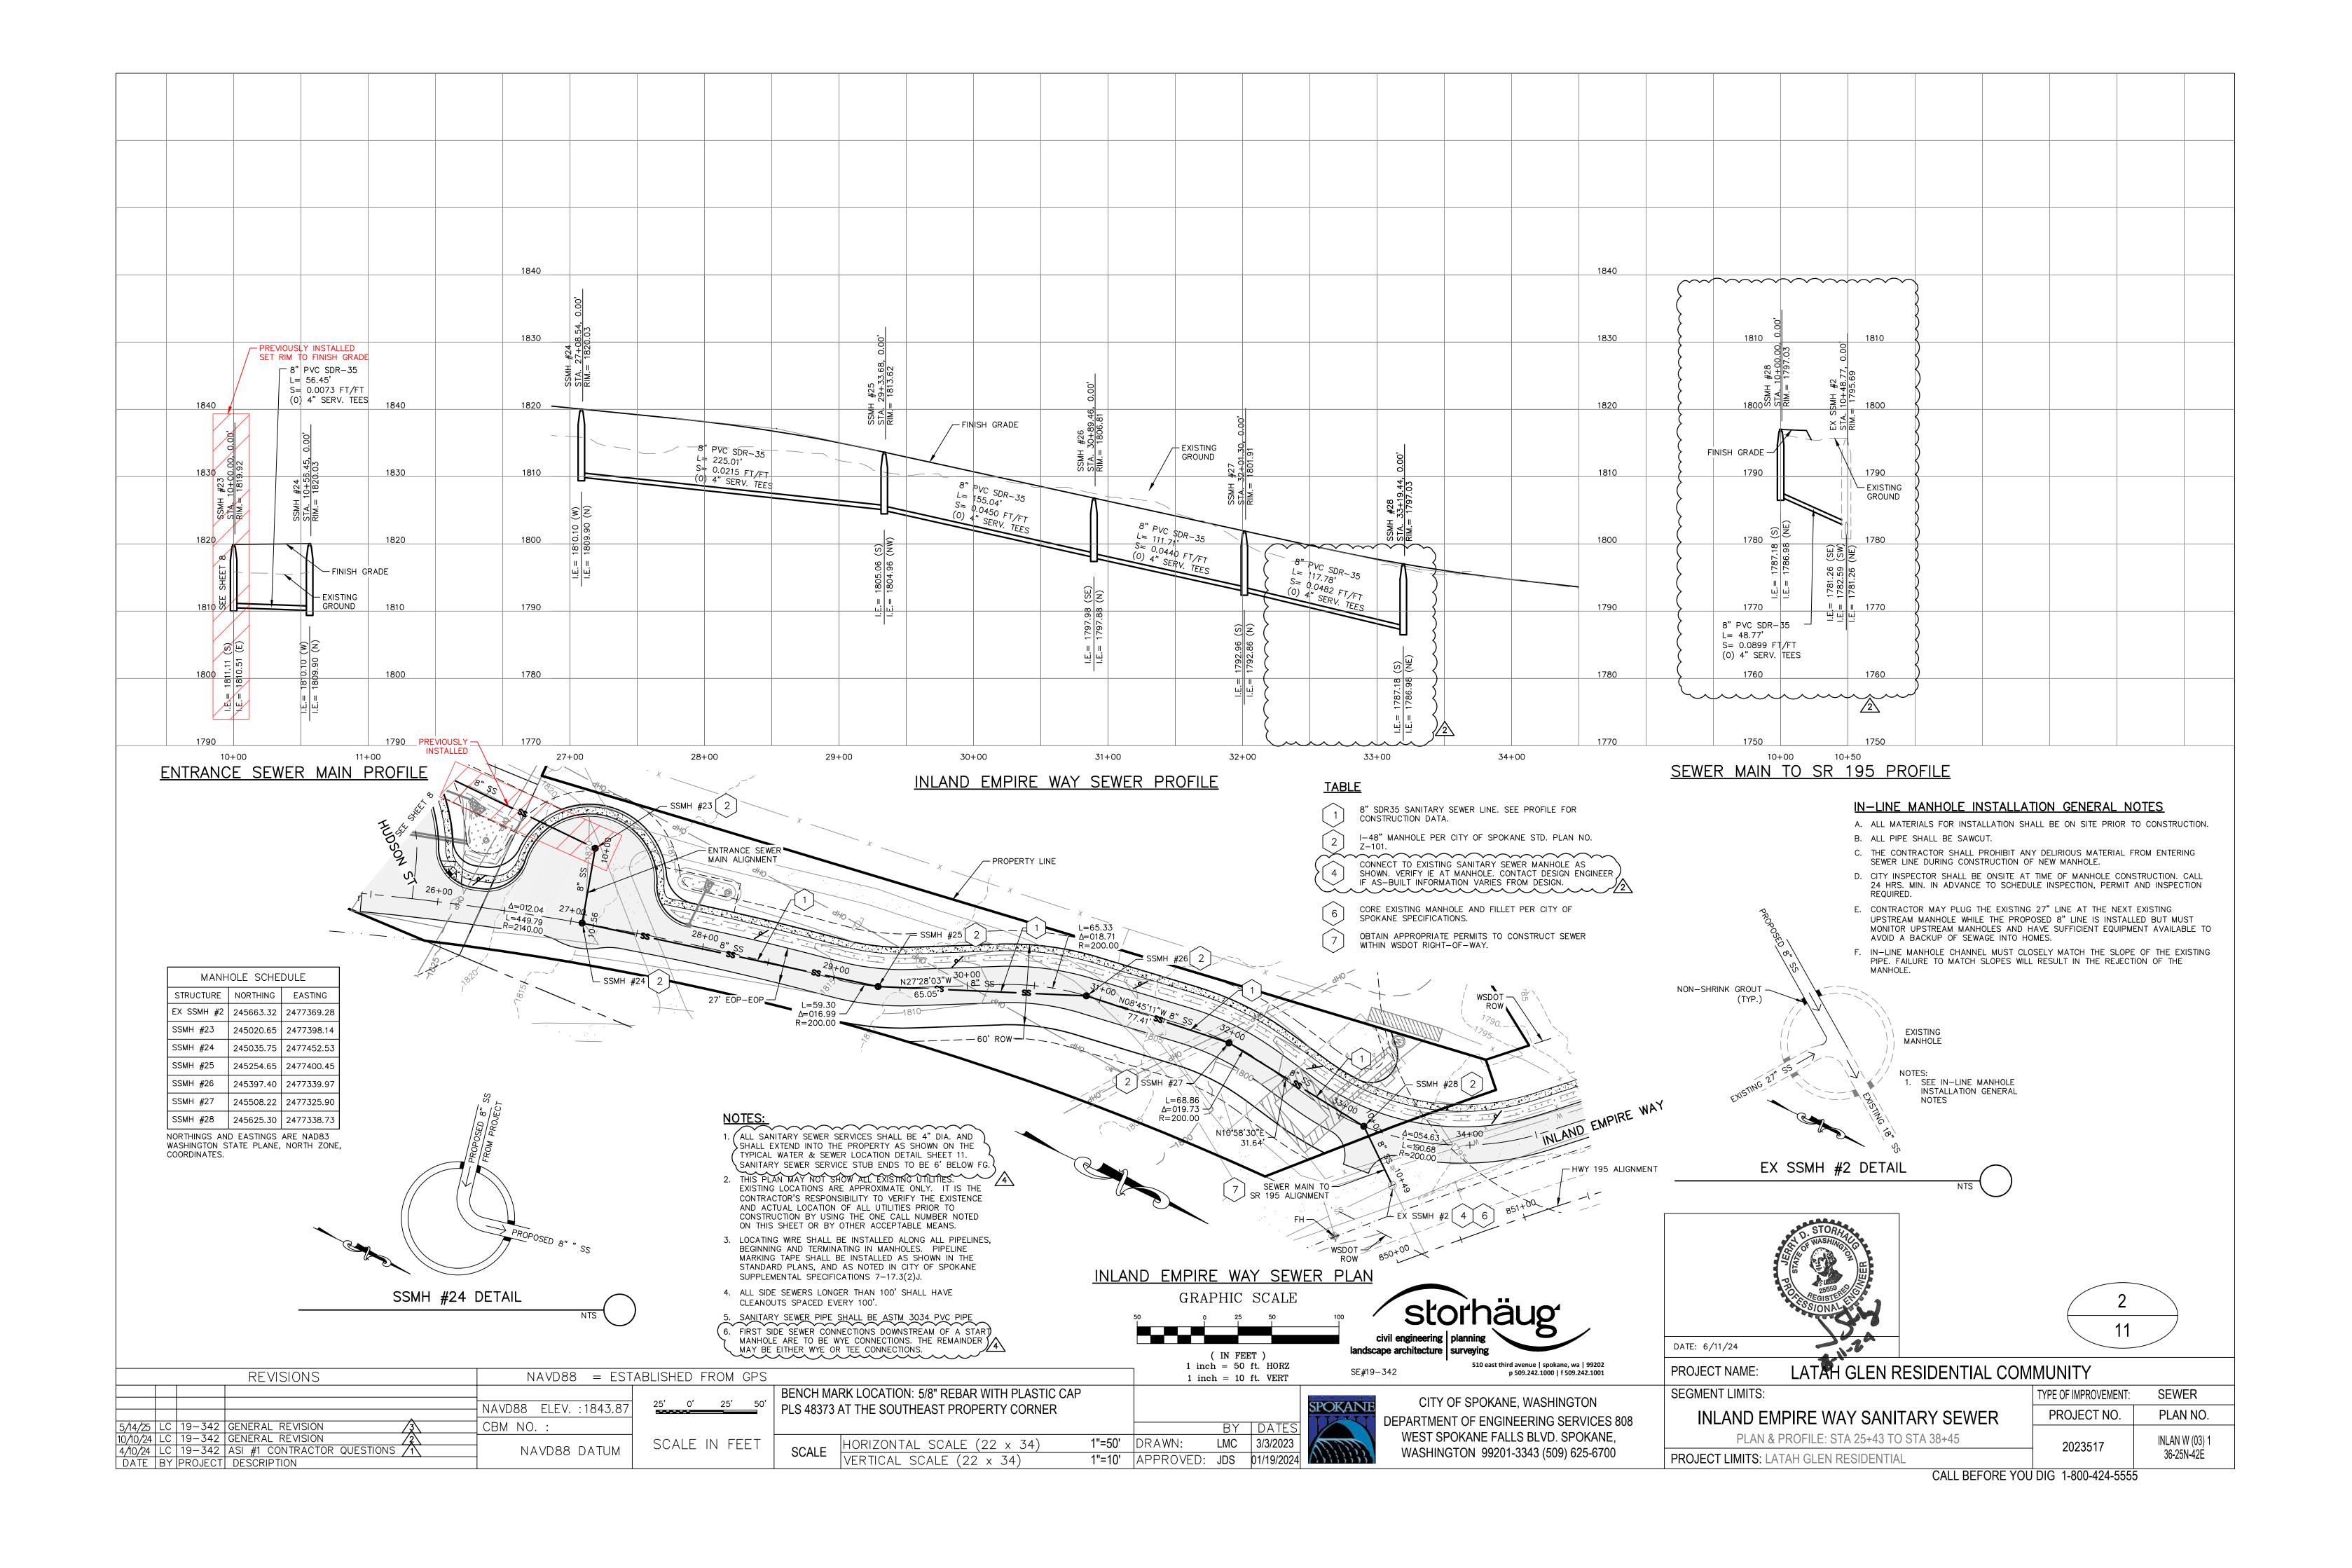

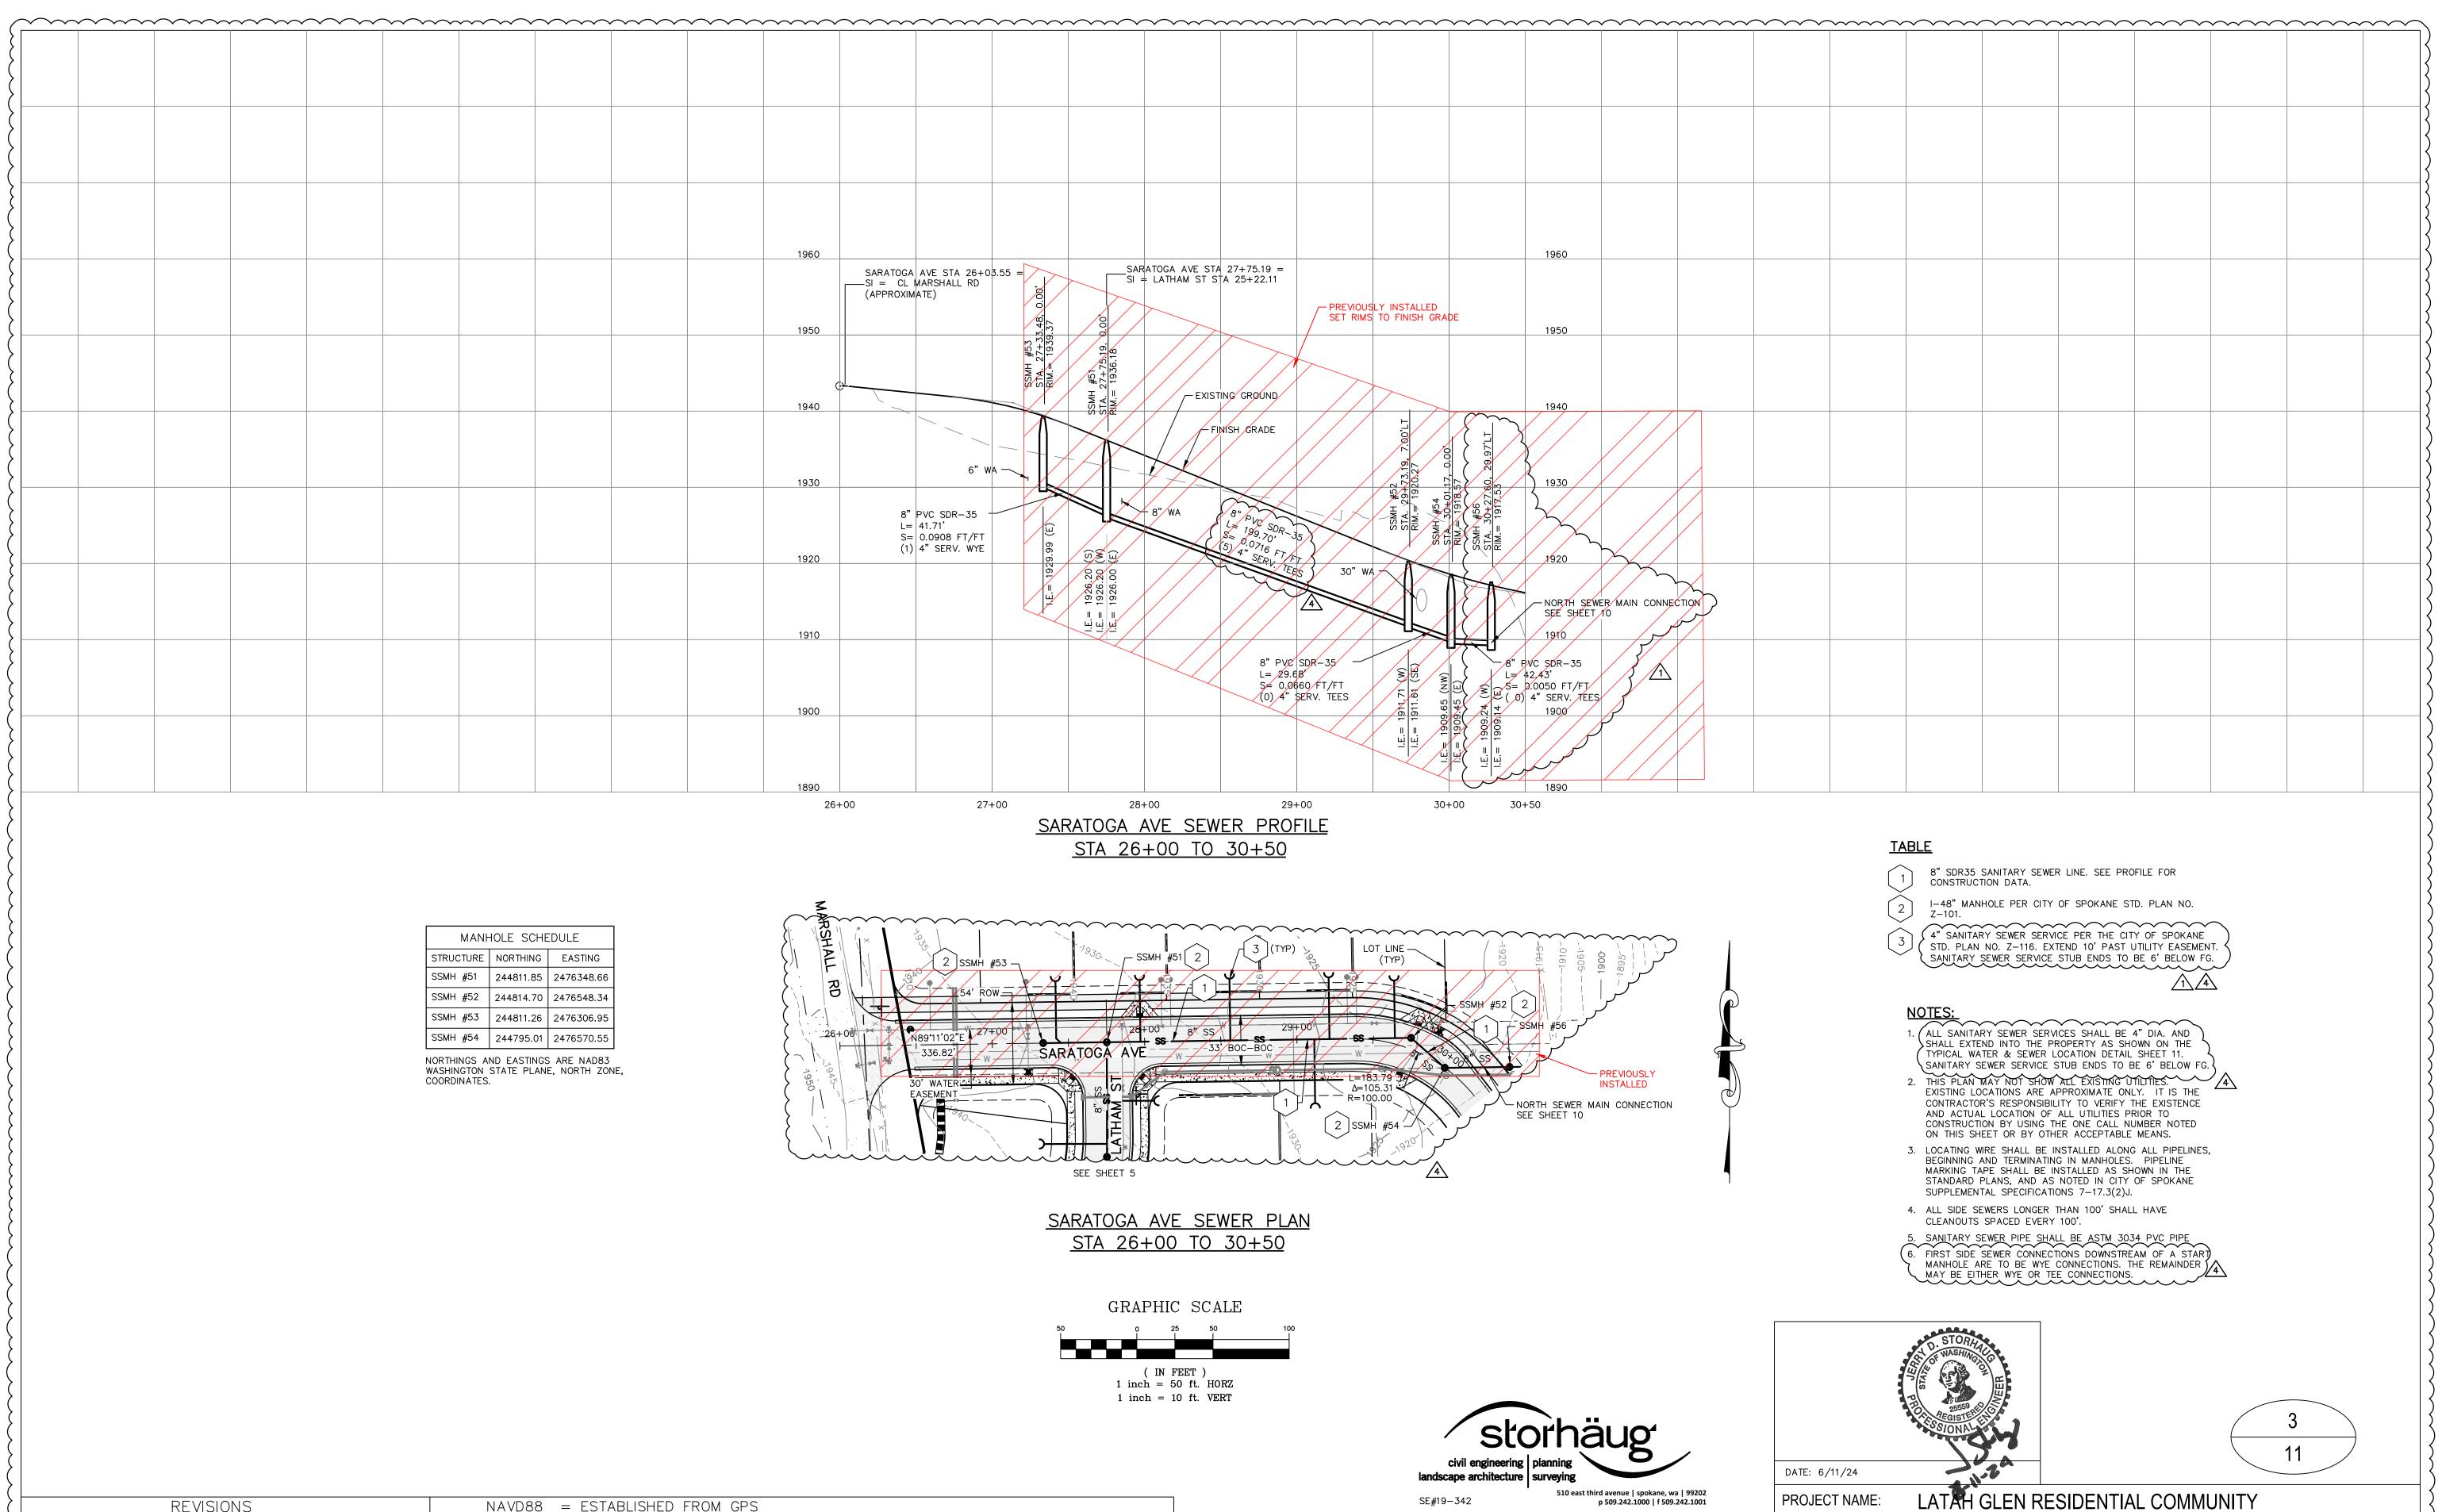


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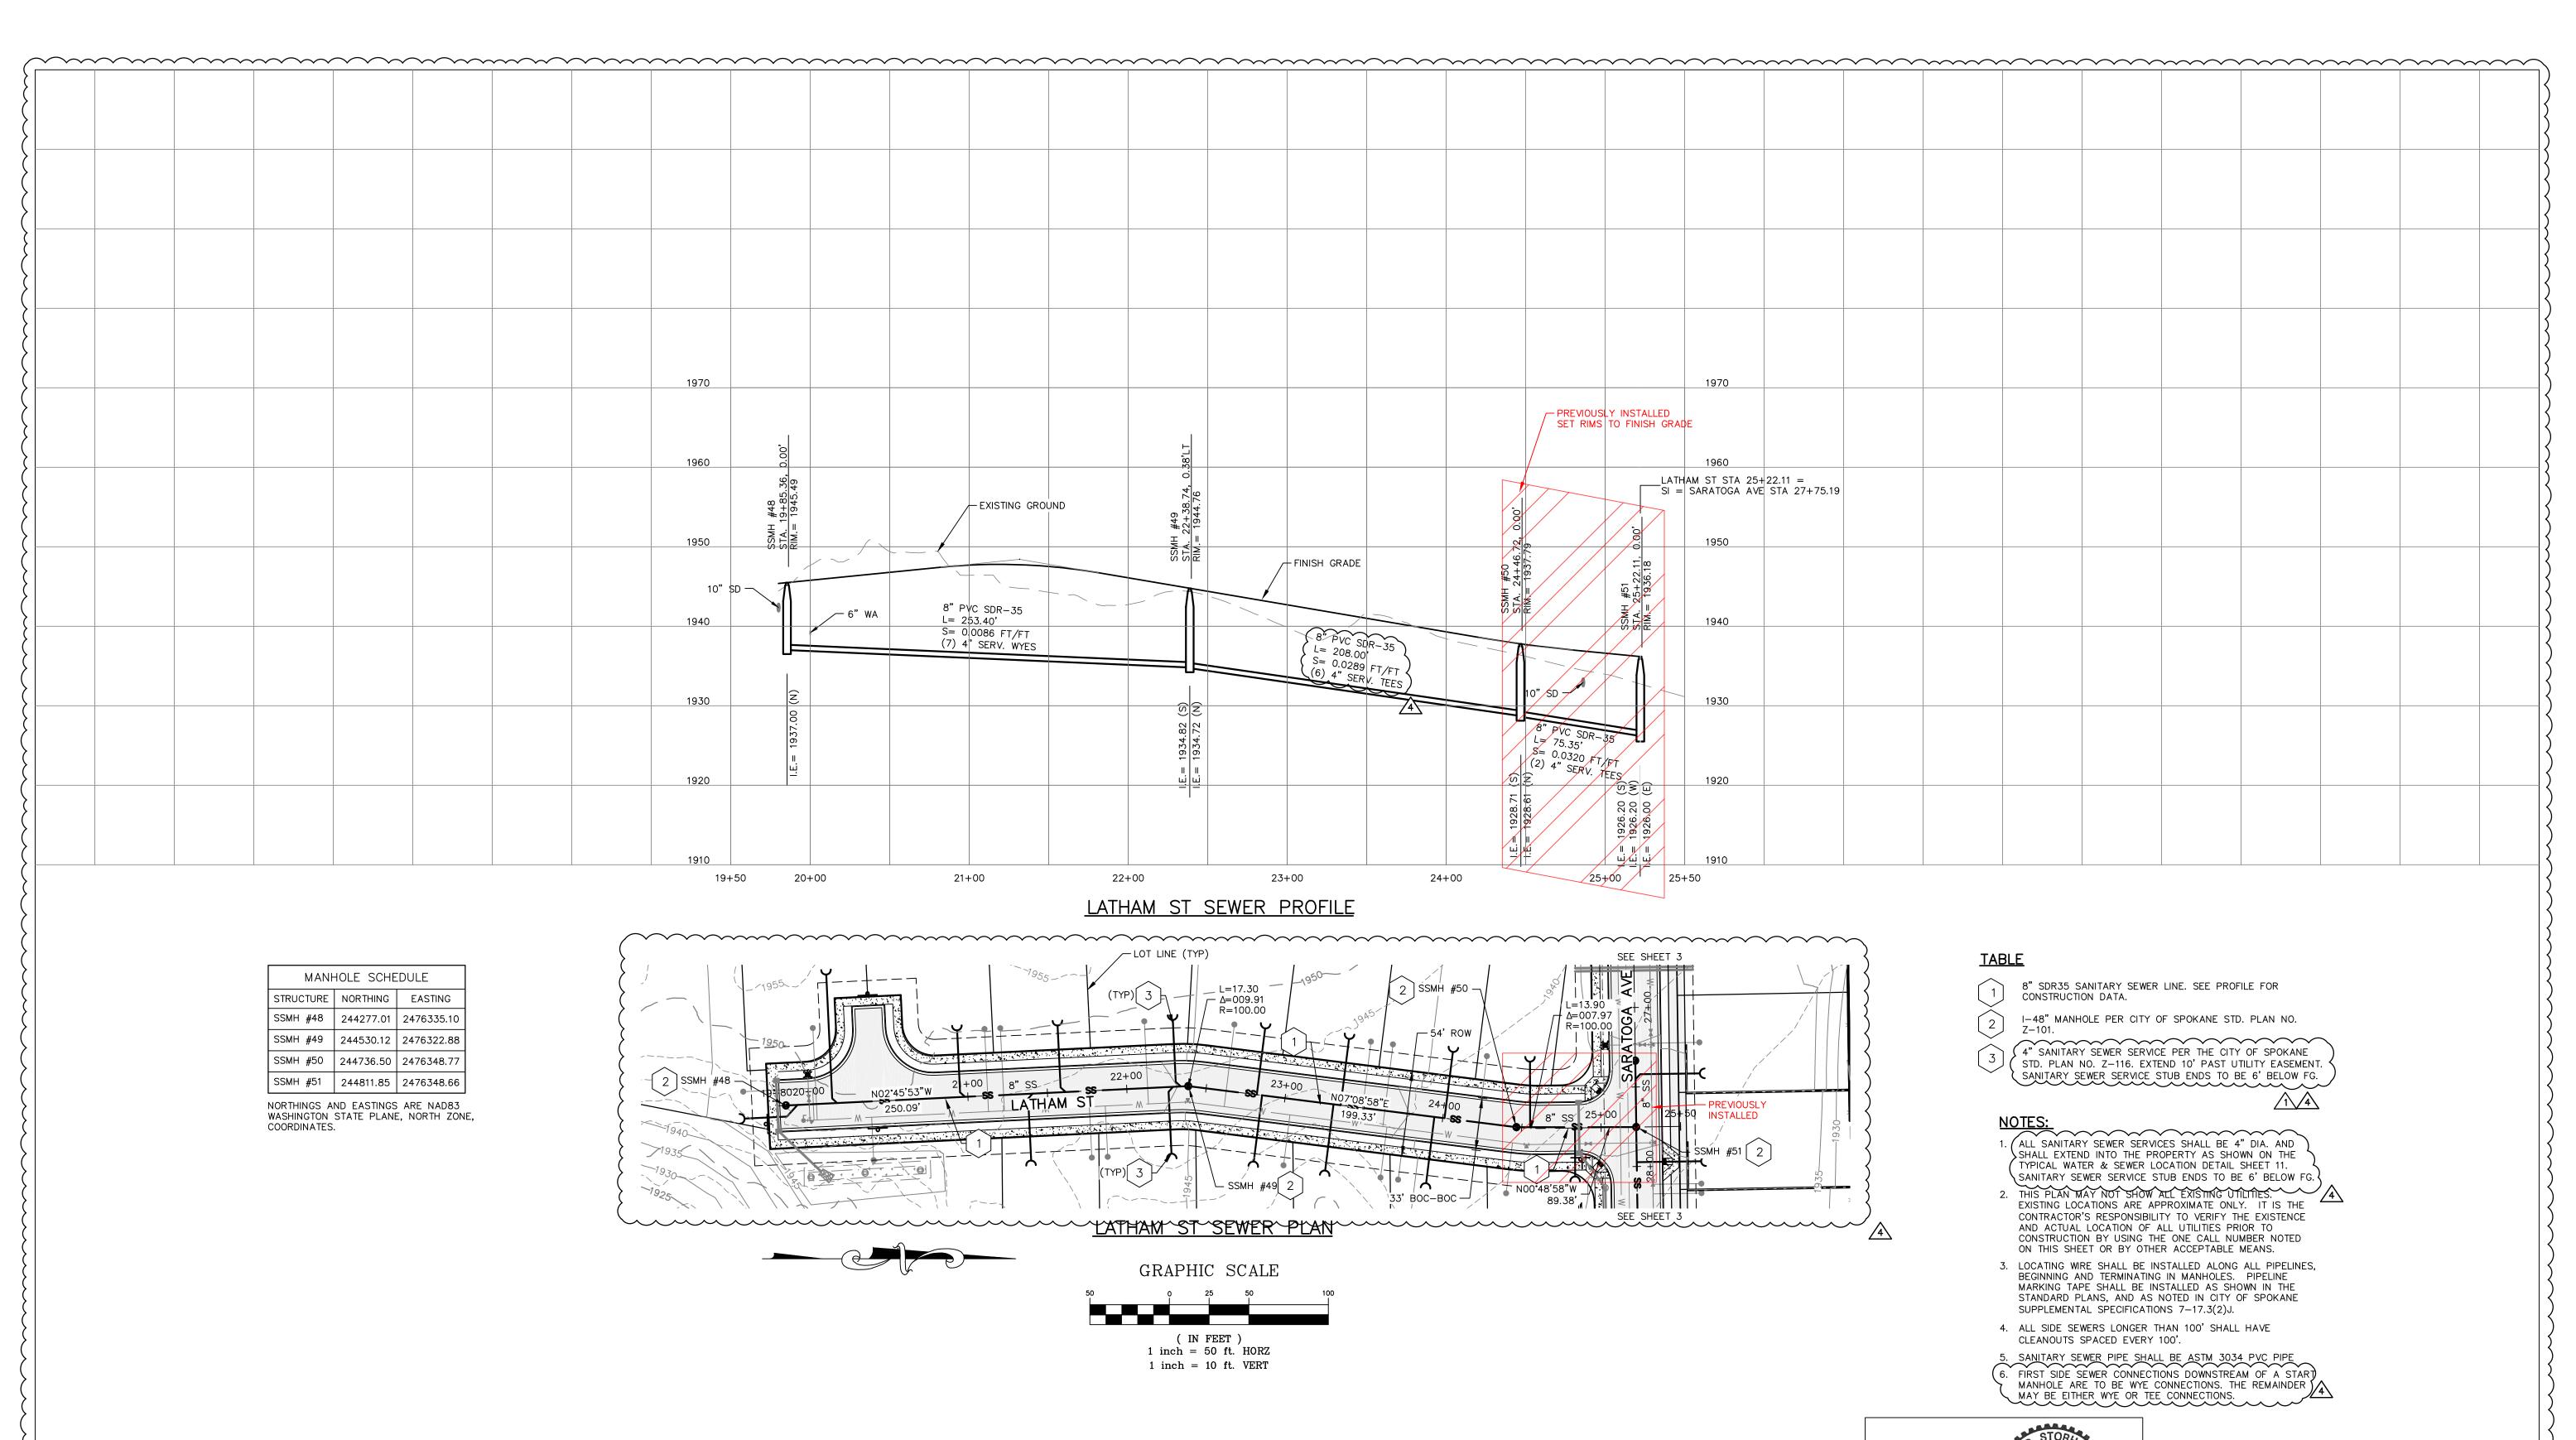
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36-25N-42E

REVISIONS NAVD88 = EST	TABLISHED FROM GPS					SE#19-342	510 east third avenue spokane, wa 99202 2 p 509.242.1000 f 509.242.1001	PROJECT NAME: LATAH GLEN RESIDENTIAL CO	MMUNITY	
		BENCH MARK LOCATION: 5/8" REBAR WITH PLASTIC CAP			group (ZANIT	CITY OF SPOKANE, WASHINGTON	SEGMENT LIMITS:	TYPE OF IMPROVEMENT:	
NAVD88 ELEV. :1843.87		PLS 48373 AT THE SOUTHEAST PROPERTY CORNER		5.7	SPOR	CAINE DE	EPARTMENT OF ENGINEERING SERVICES 808	SARATOGA AVE SANITARY SEWER	PROJECT NO.	
(5/14/25 LC 19-342 GENERAL REVISION /3 CBM NO. : (10/10/24 LC 19-342 GENERAL REVISION /2 CBM NO. : (10/10/24 LC 19-342 CBM NO. : (10/10/24 LC 19-342	SCALE IN FEET	HORIZONITAL SCALE (22 × 34)	1"=50' DR	AWN: IMC	3/3/2023		WEST SPOKANE FALLS BLVD. SPOKANE,	PLAN & PROFILE STA 26+00 TO STA 30+50	0000547	(
(4/10/24 LC 19-342 ASI #1 CONTRACTOR QUESTIONS /1 NAVD88 DATUM (DATE BY PROJECT DESCRIPTION	JOALL IN TELT	SCALE VERTICAL SCALE (22 x 34)	1"=10' APF	PROVED: JDS	01/19/2024		WASHINGTON 99201-3343 (509) 625-6700	PROJECT LIMITS: LATAH GLEN RESIDENTIAL	2023517	
	~~~~~							CALL BEFORE Y	OU DIG 1-800-424-5555	,5





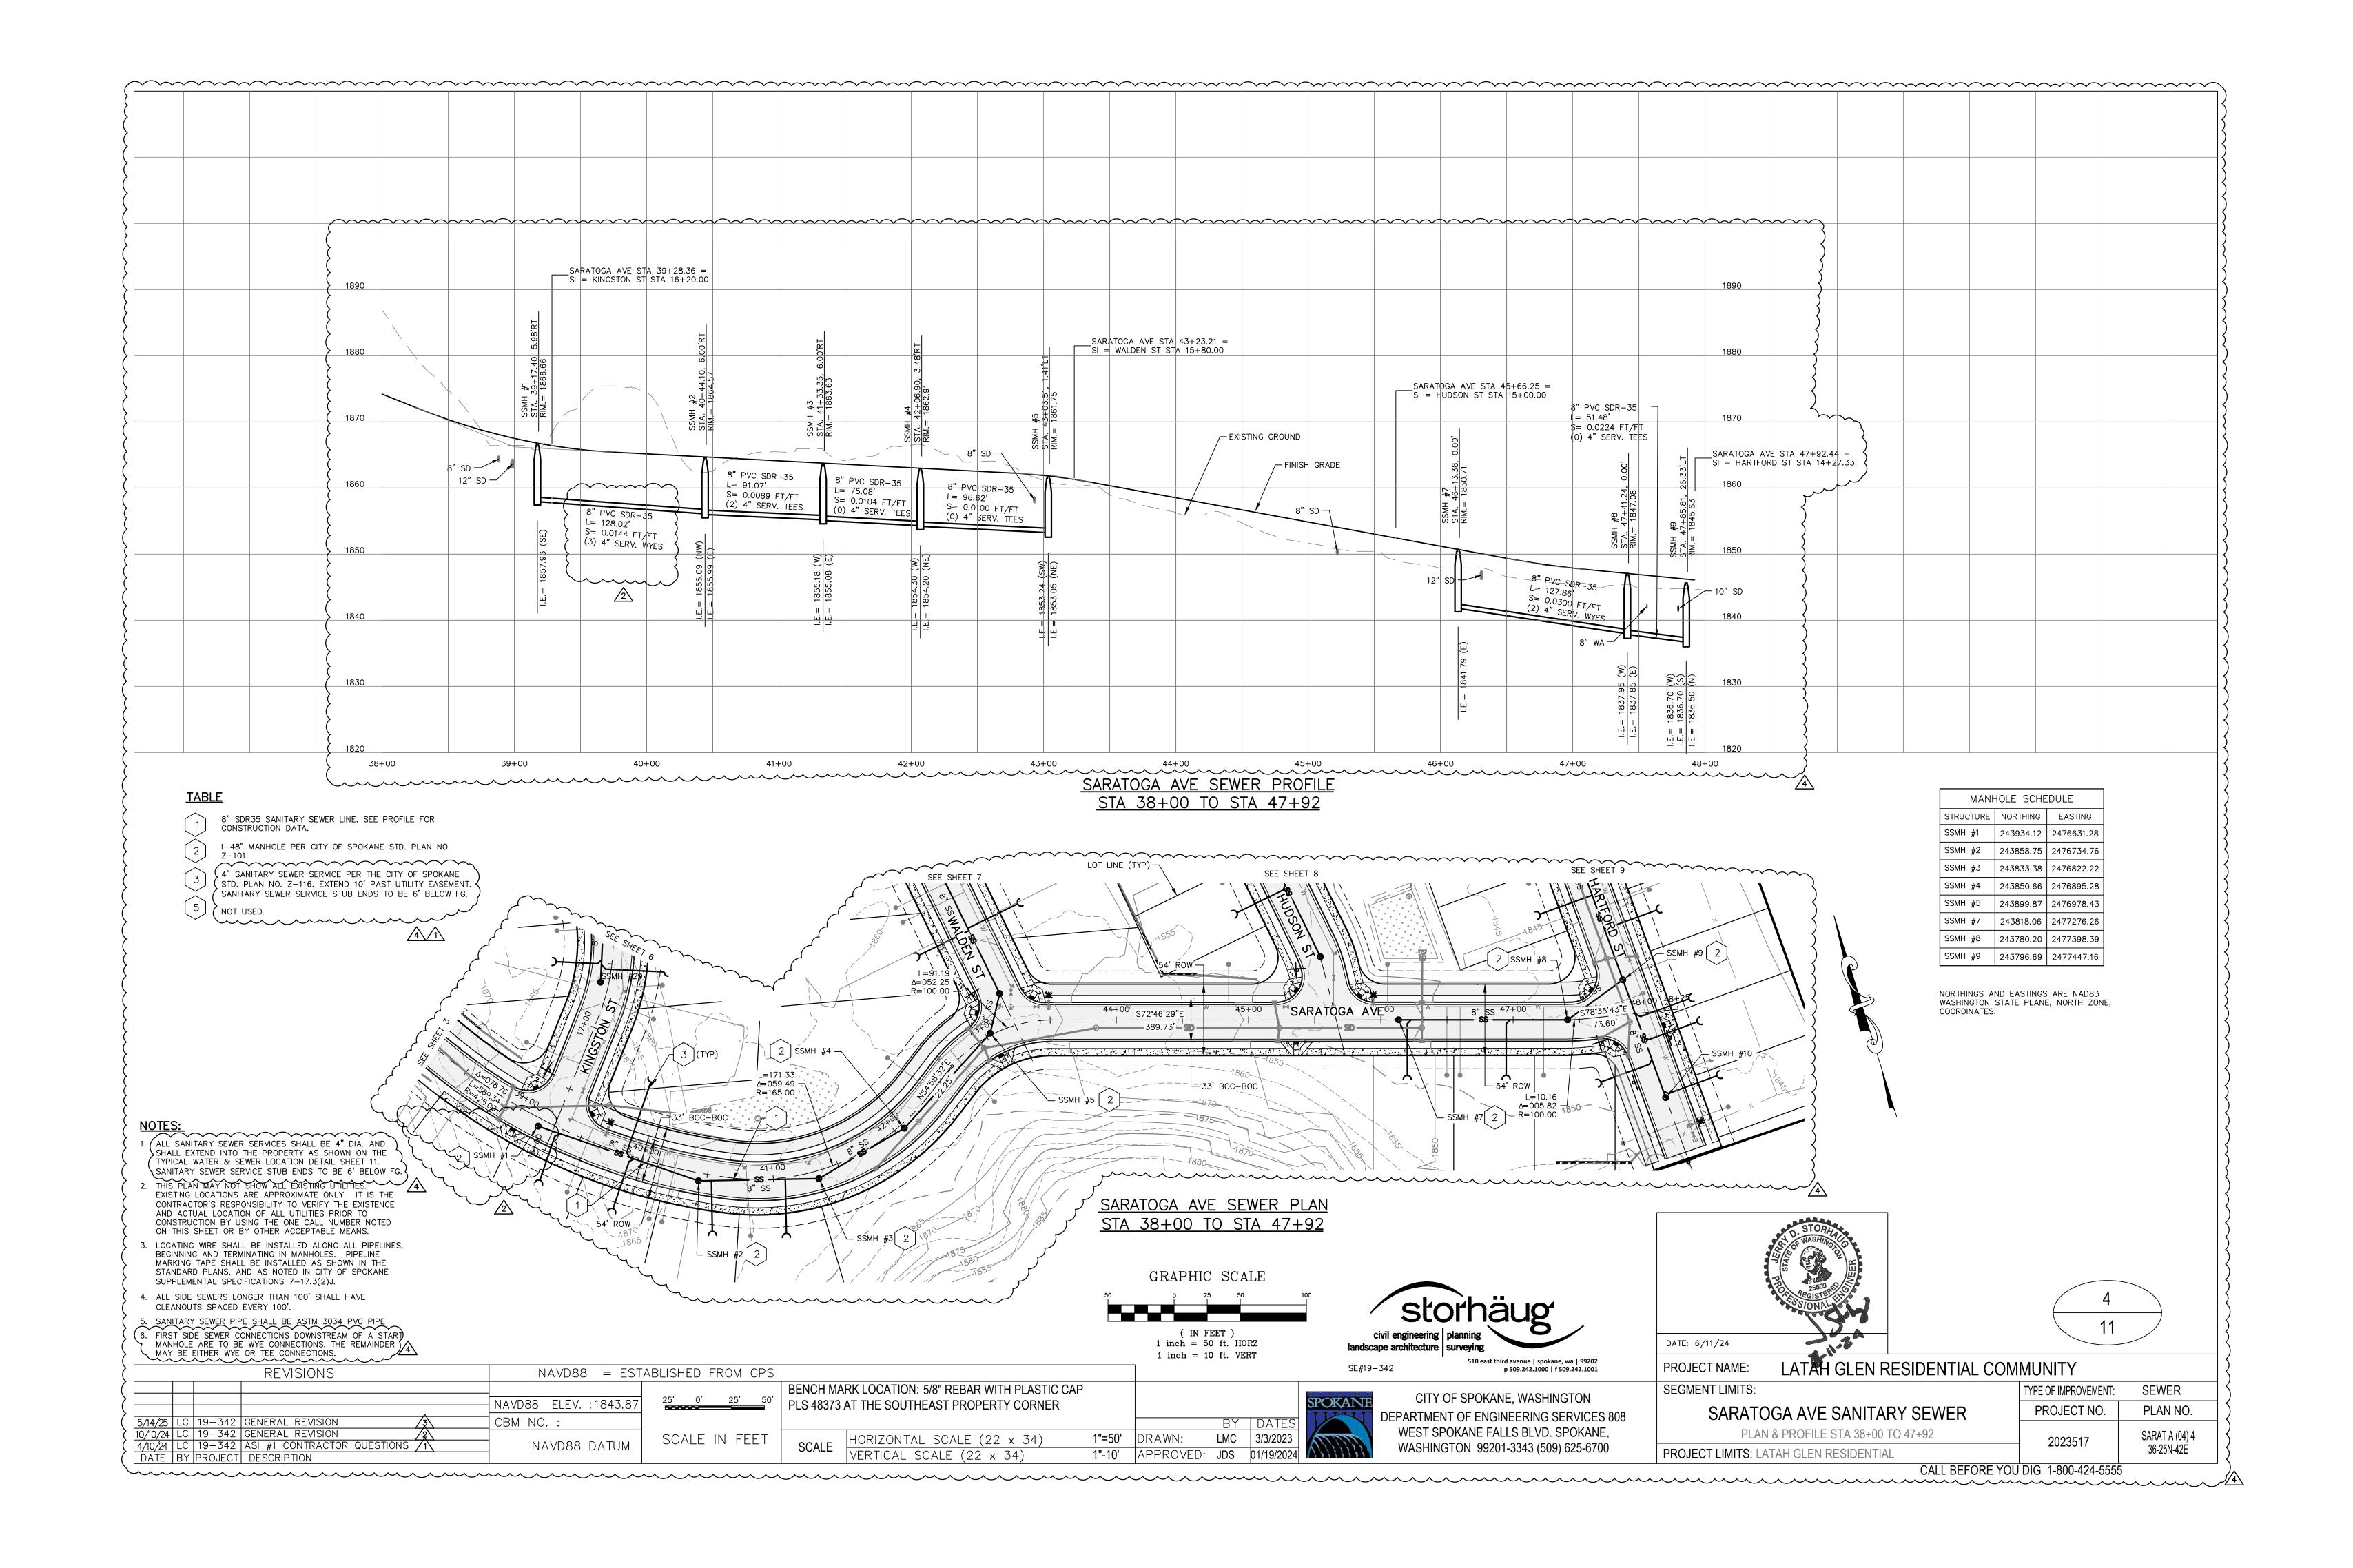

510 east third avenue | spokane, wa | 99202 p 509.242.1000 | f 509.242.1001

DATE: 6/11/24


PROJECT LIMITS: LATAH GLEN RESIDENTIAL

			REVISIONS	N	IAVD88	= EST	ABLISH	IED I	FROM	GPS
				NAVD88	FLFV	.1843.87	25'	0'	25'	50'
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43.87	25'	0'	25'	50'
TUM	SC/	ALE I	n fe	EΤ

BENCH MARK LOCATION: 5/8" REBAR WITH PLASTIC CAP PLS 48373 AT THE SOUTHEAST PROPERTY CORNER HORIZONTAL SCALE (22 x 34) VERTICAL SCALE (22 x 34)

1"=50' | DRAWN: LMC 3/3/2023 1"=10' APPROVED: JDS 01/19/2024 

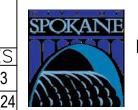


CITY OF SPOKANE, WASHINGTON DEPARTMENT OF ENGINEERING SERVICES 808 WEST SPOKANE FALLS BLVD. SPOKANE, WASHINGTON 99201-3343 (509) 625-6700


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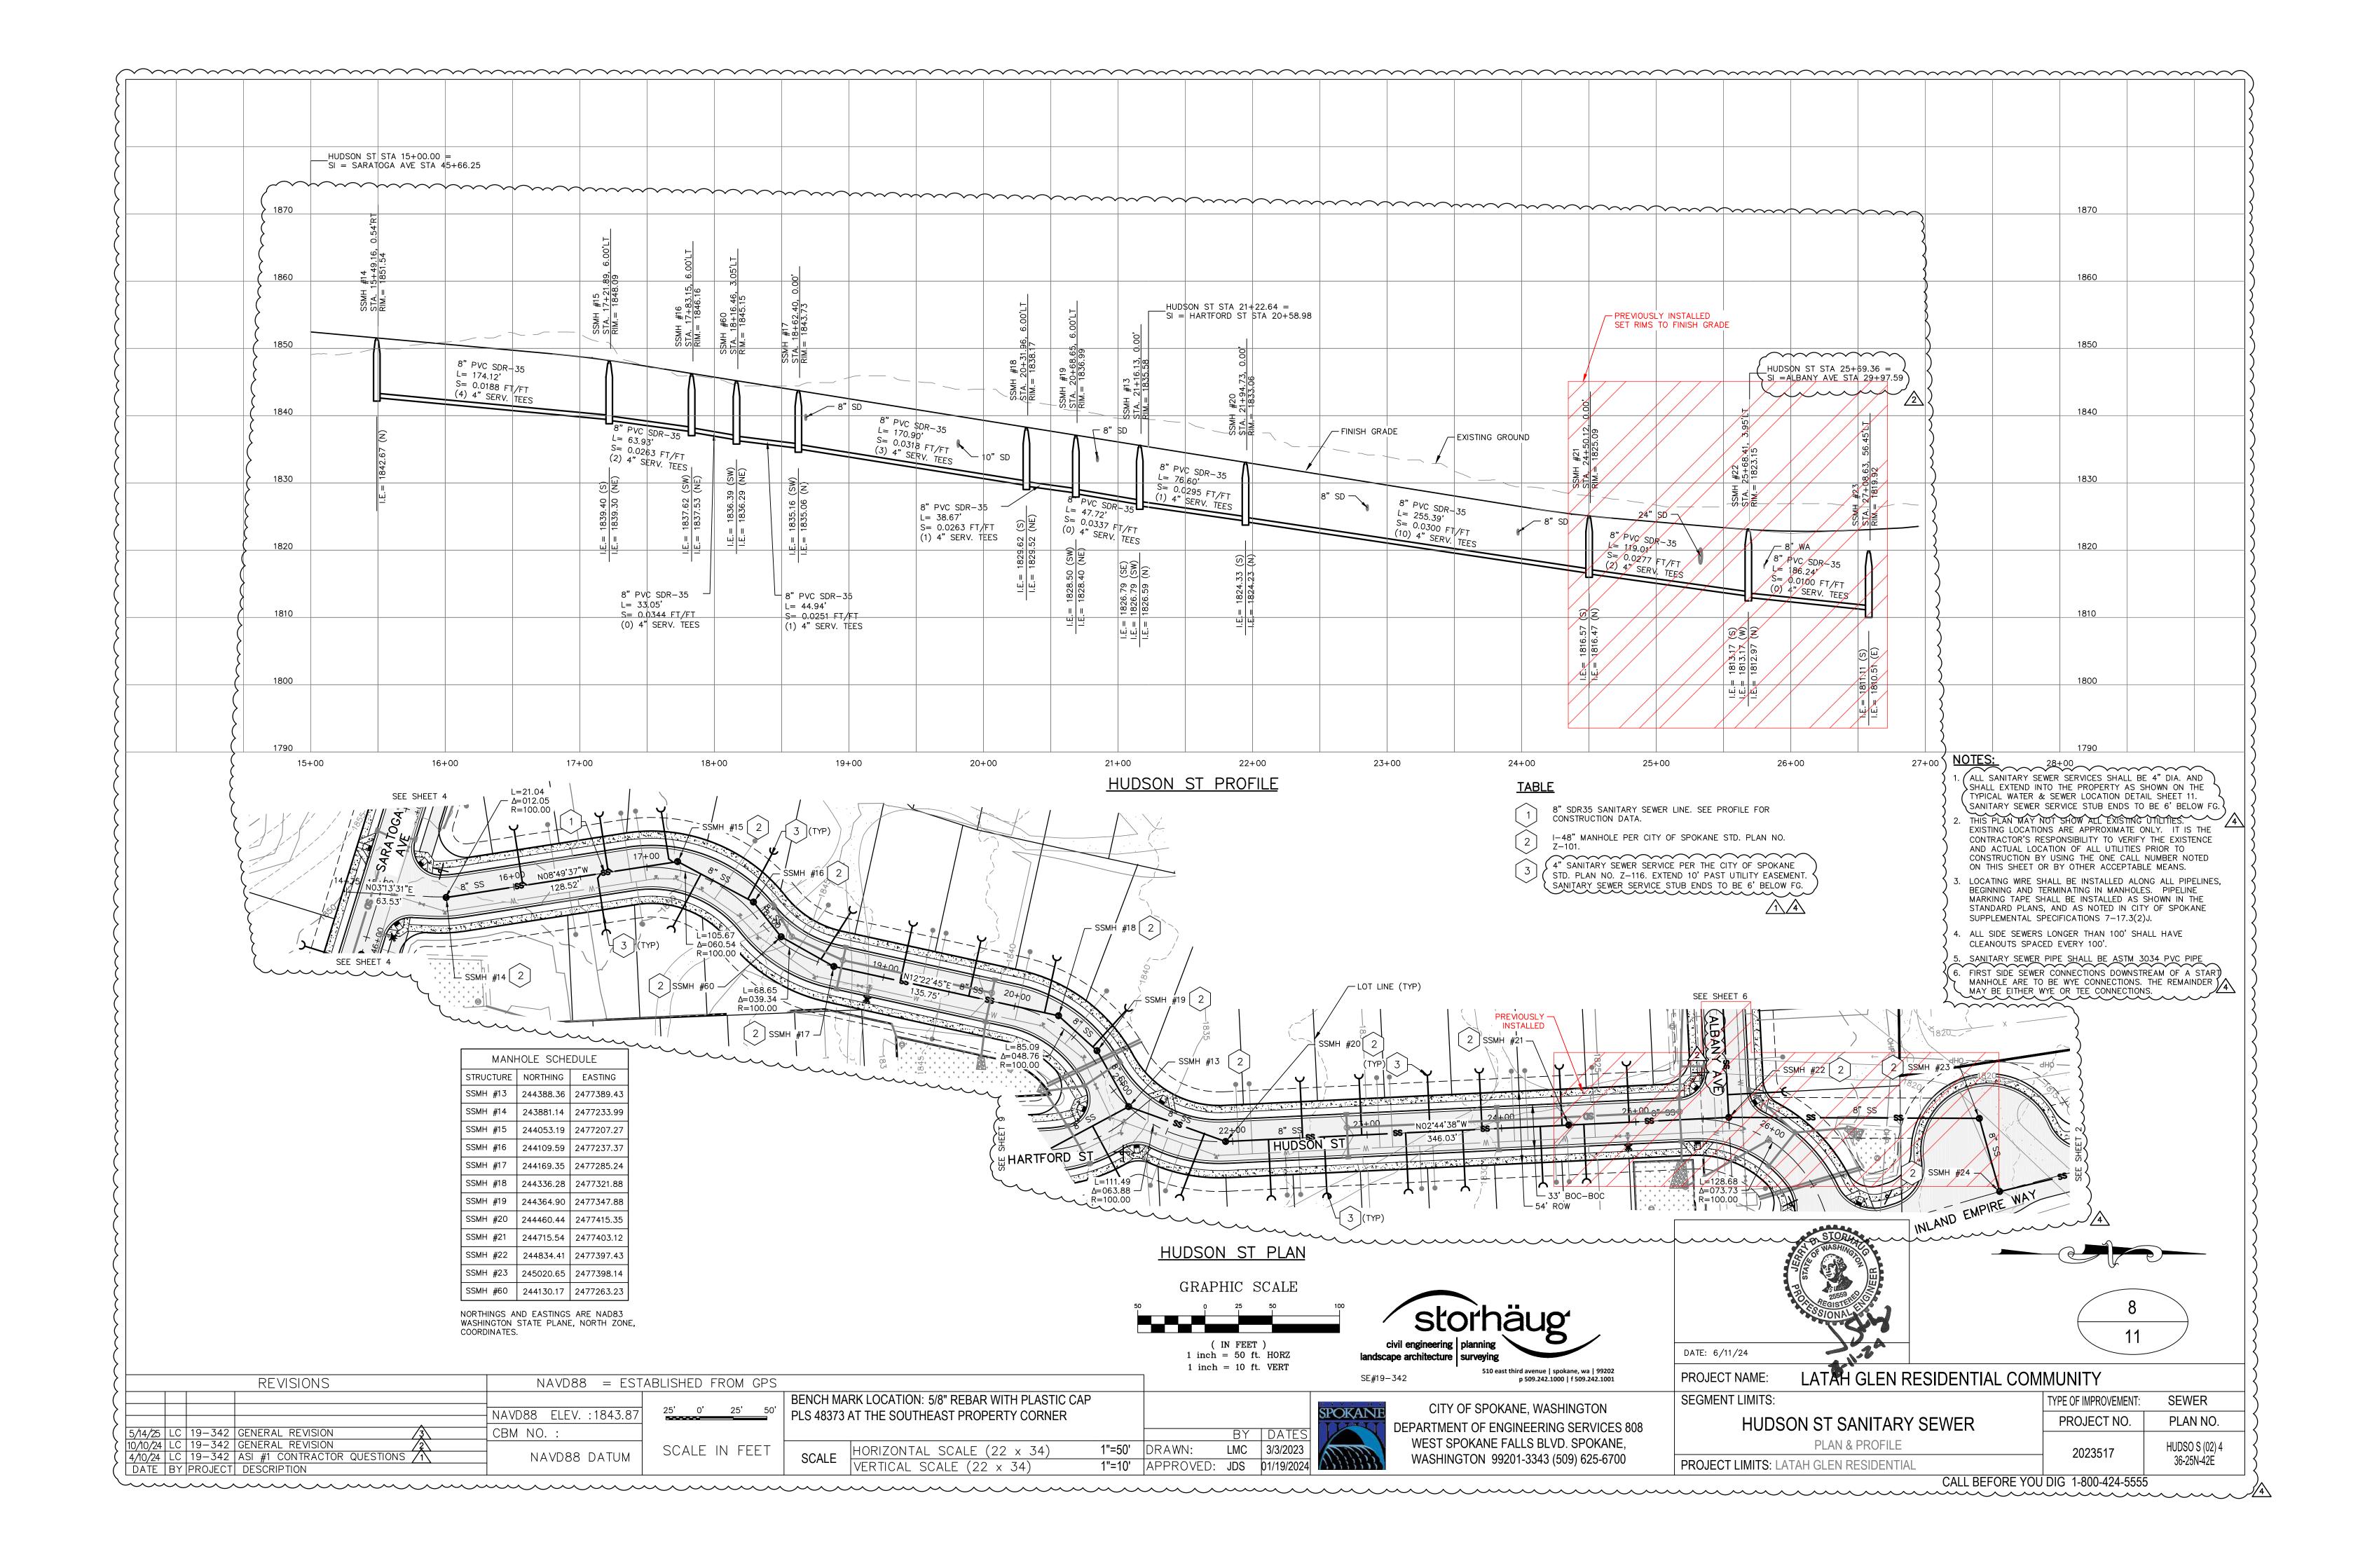
SEGMENT LIMITS:


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PLAN & PROFILE			


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PROJECT NO.	PLAN NO.
2023517	LATHA S (02) 4 36-25N-42E



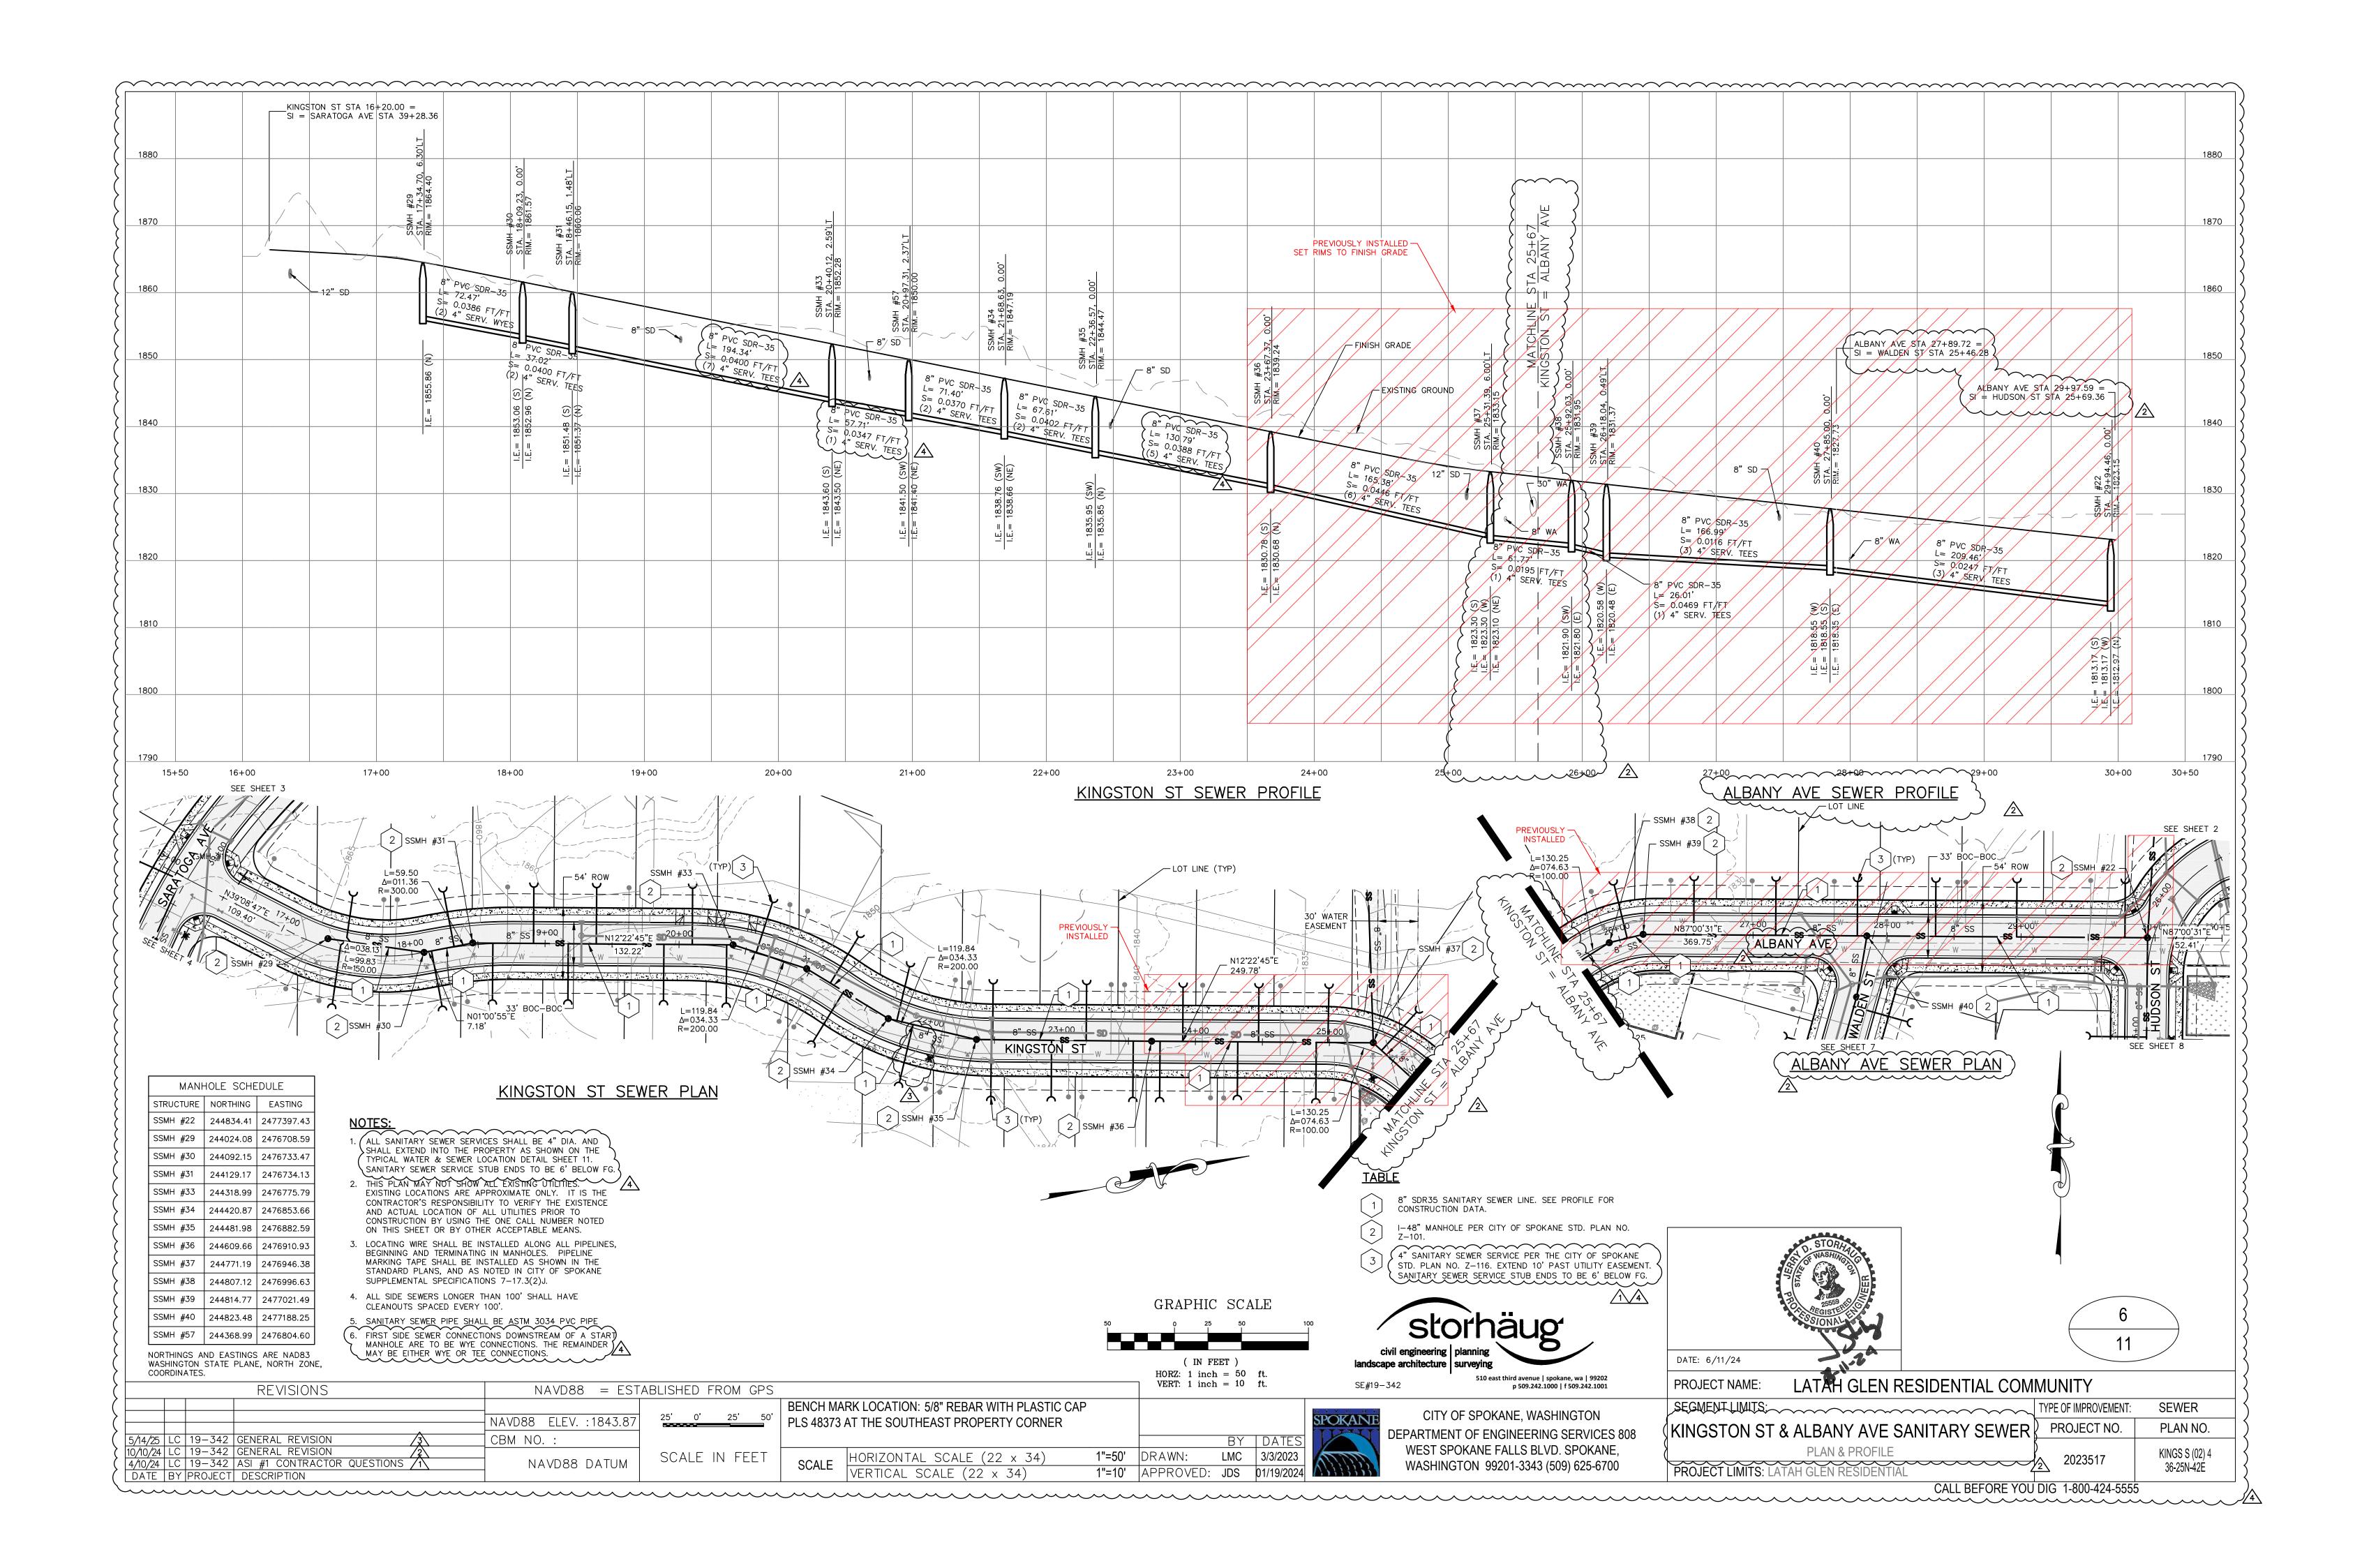

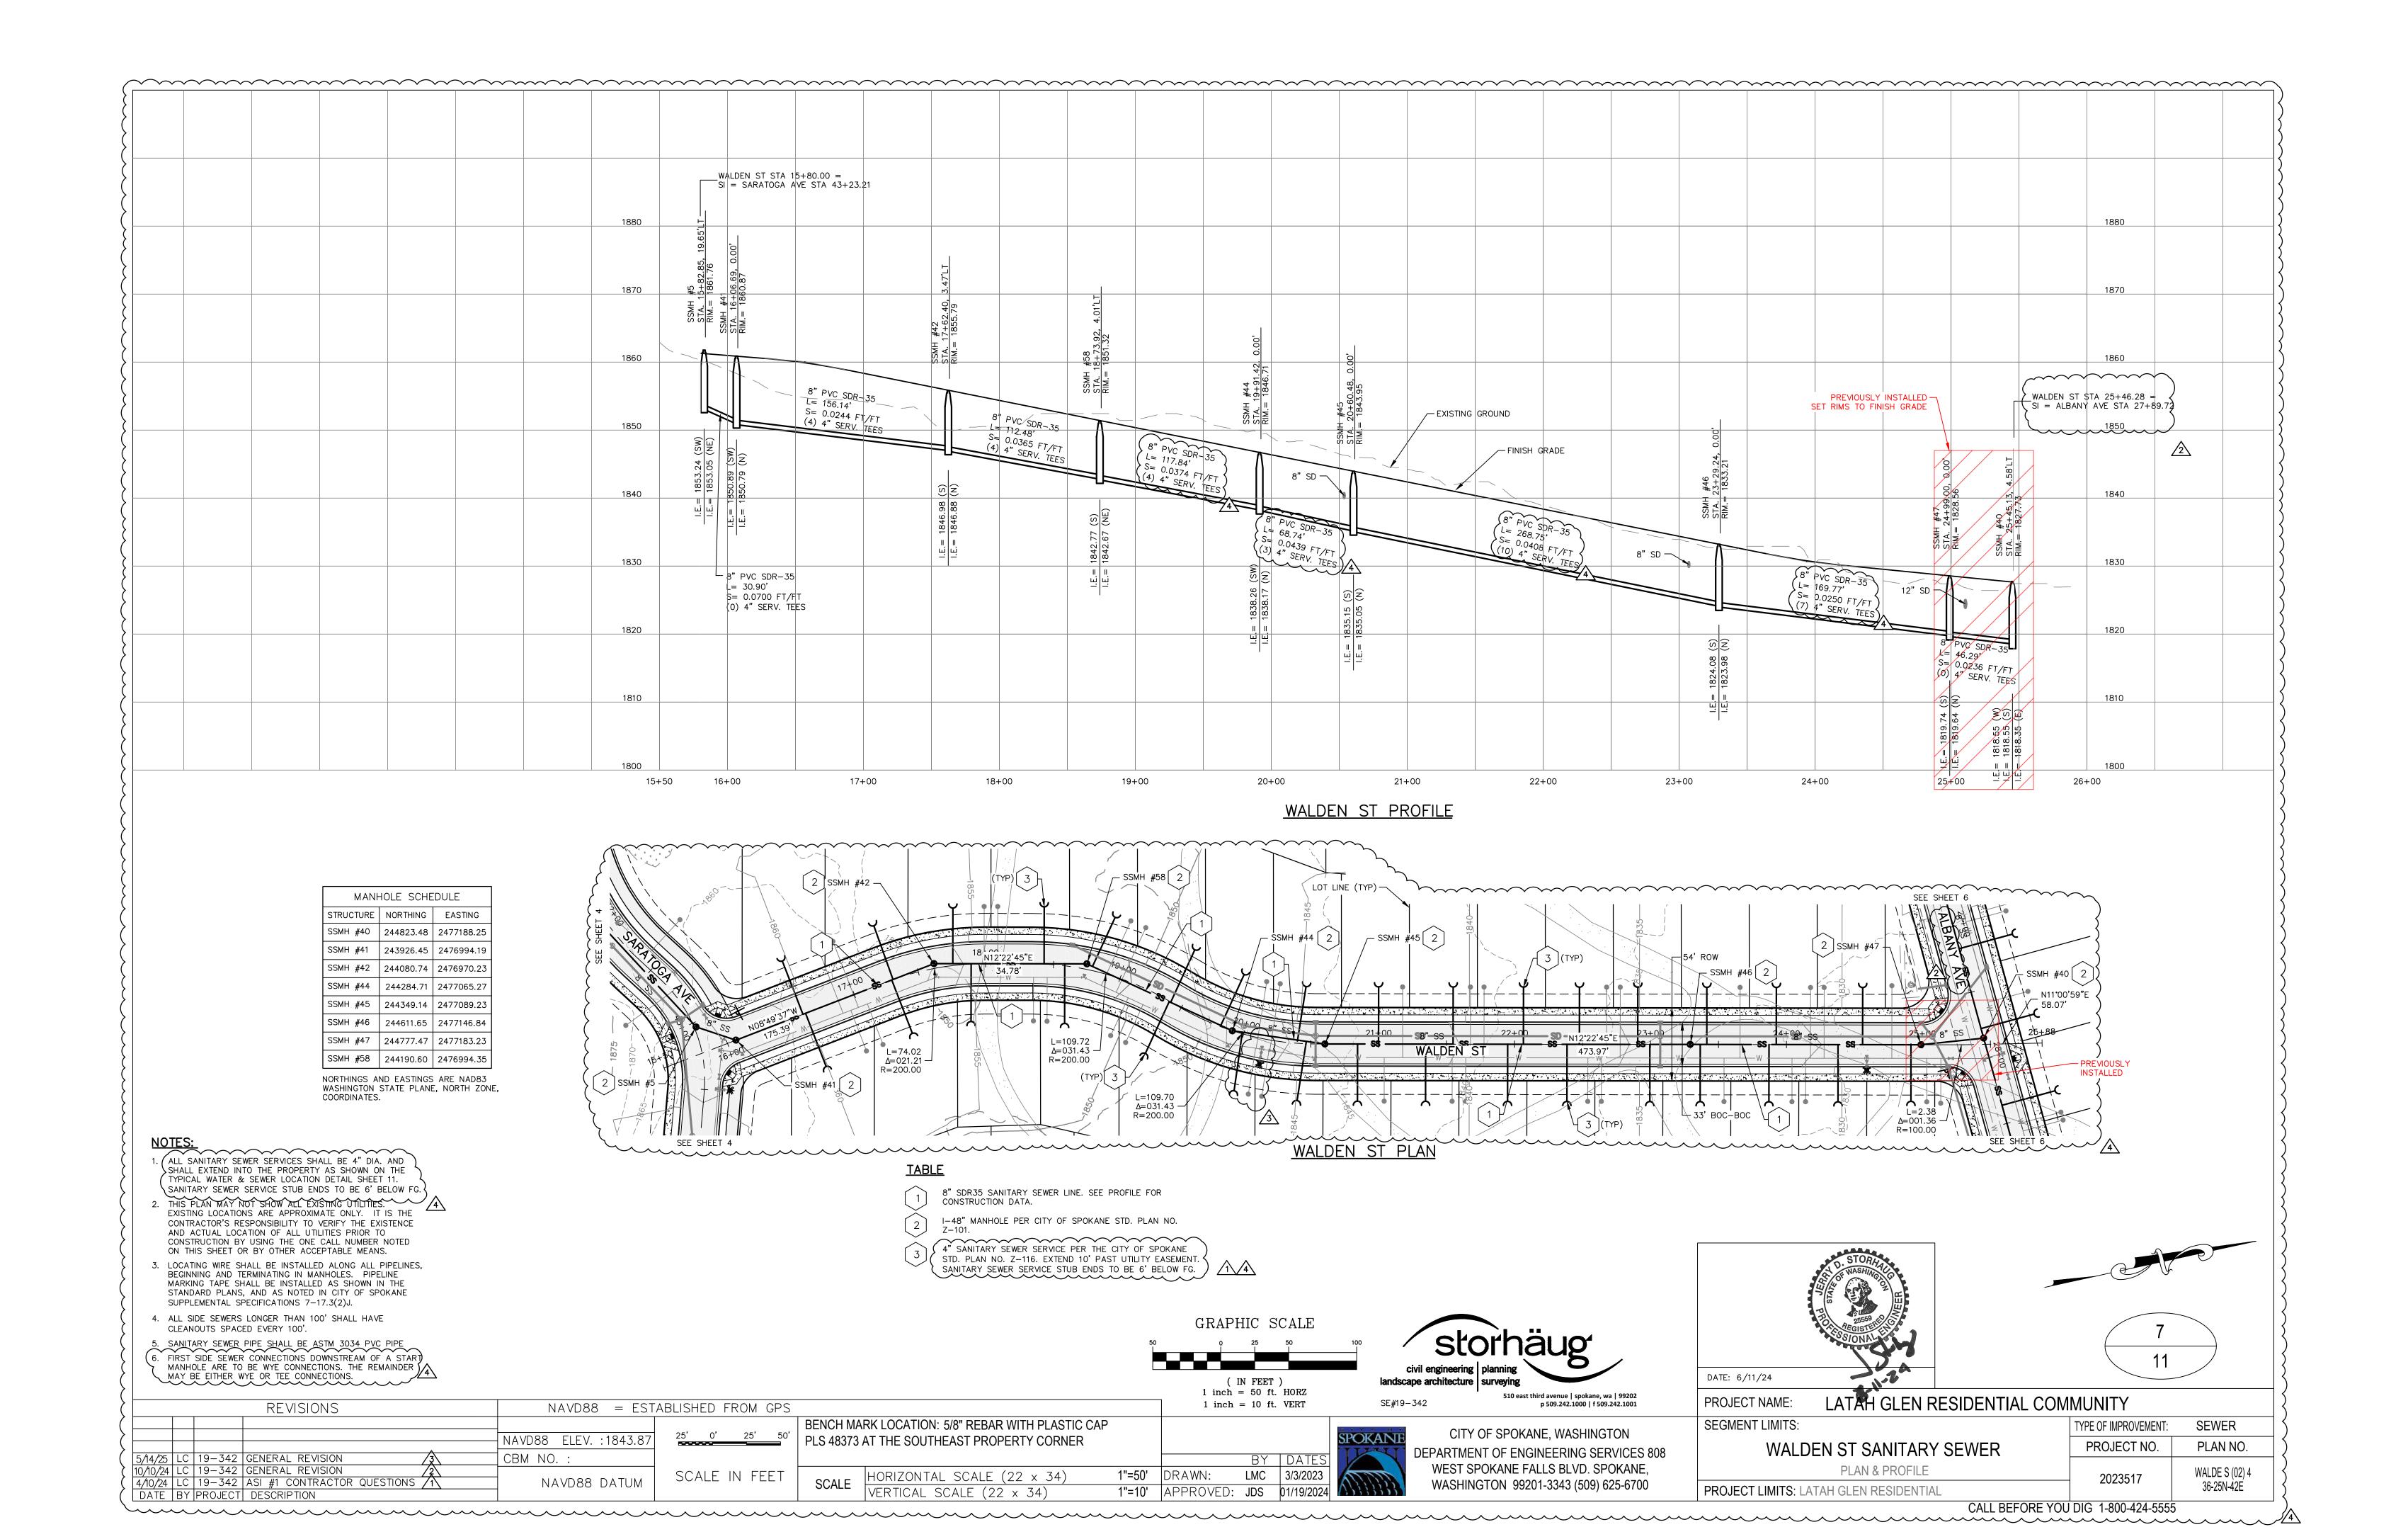

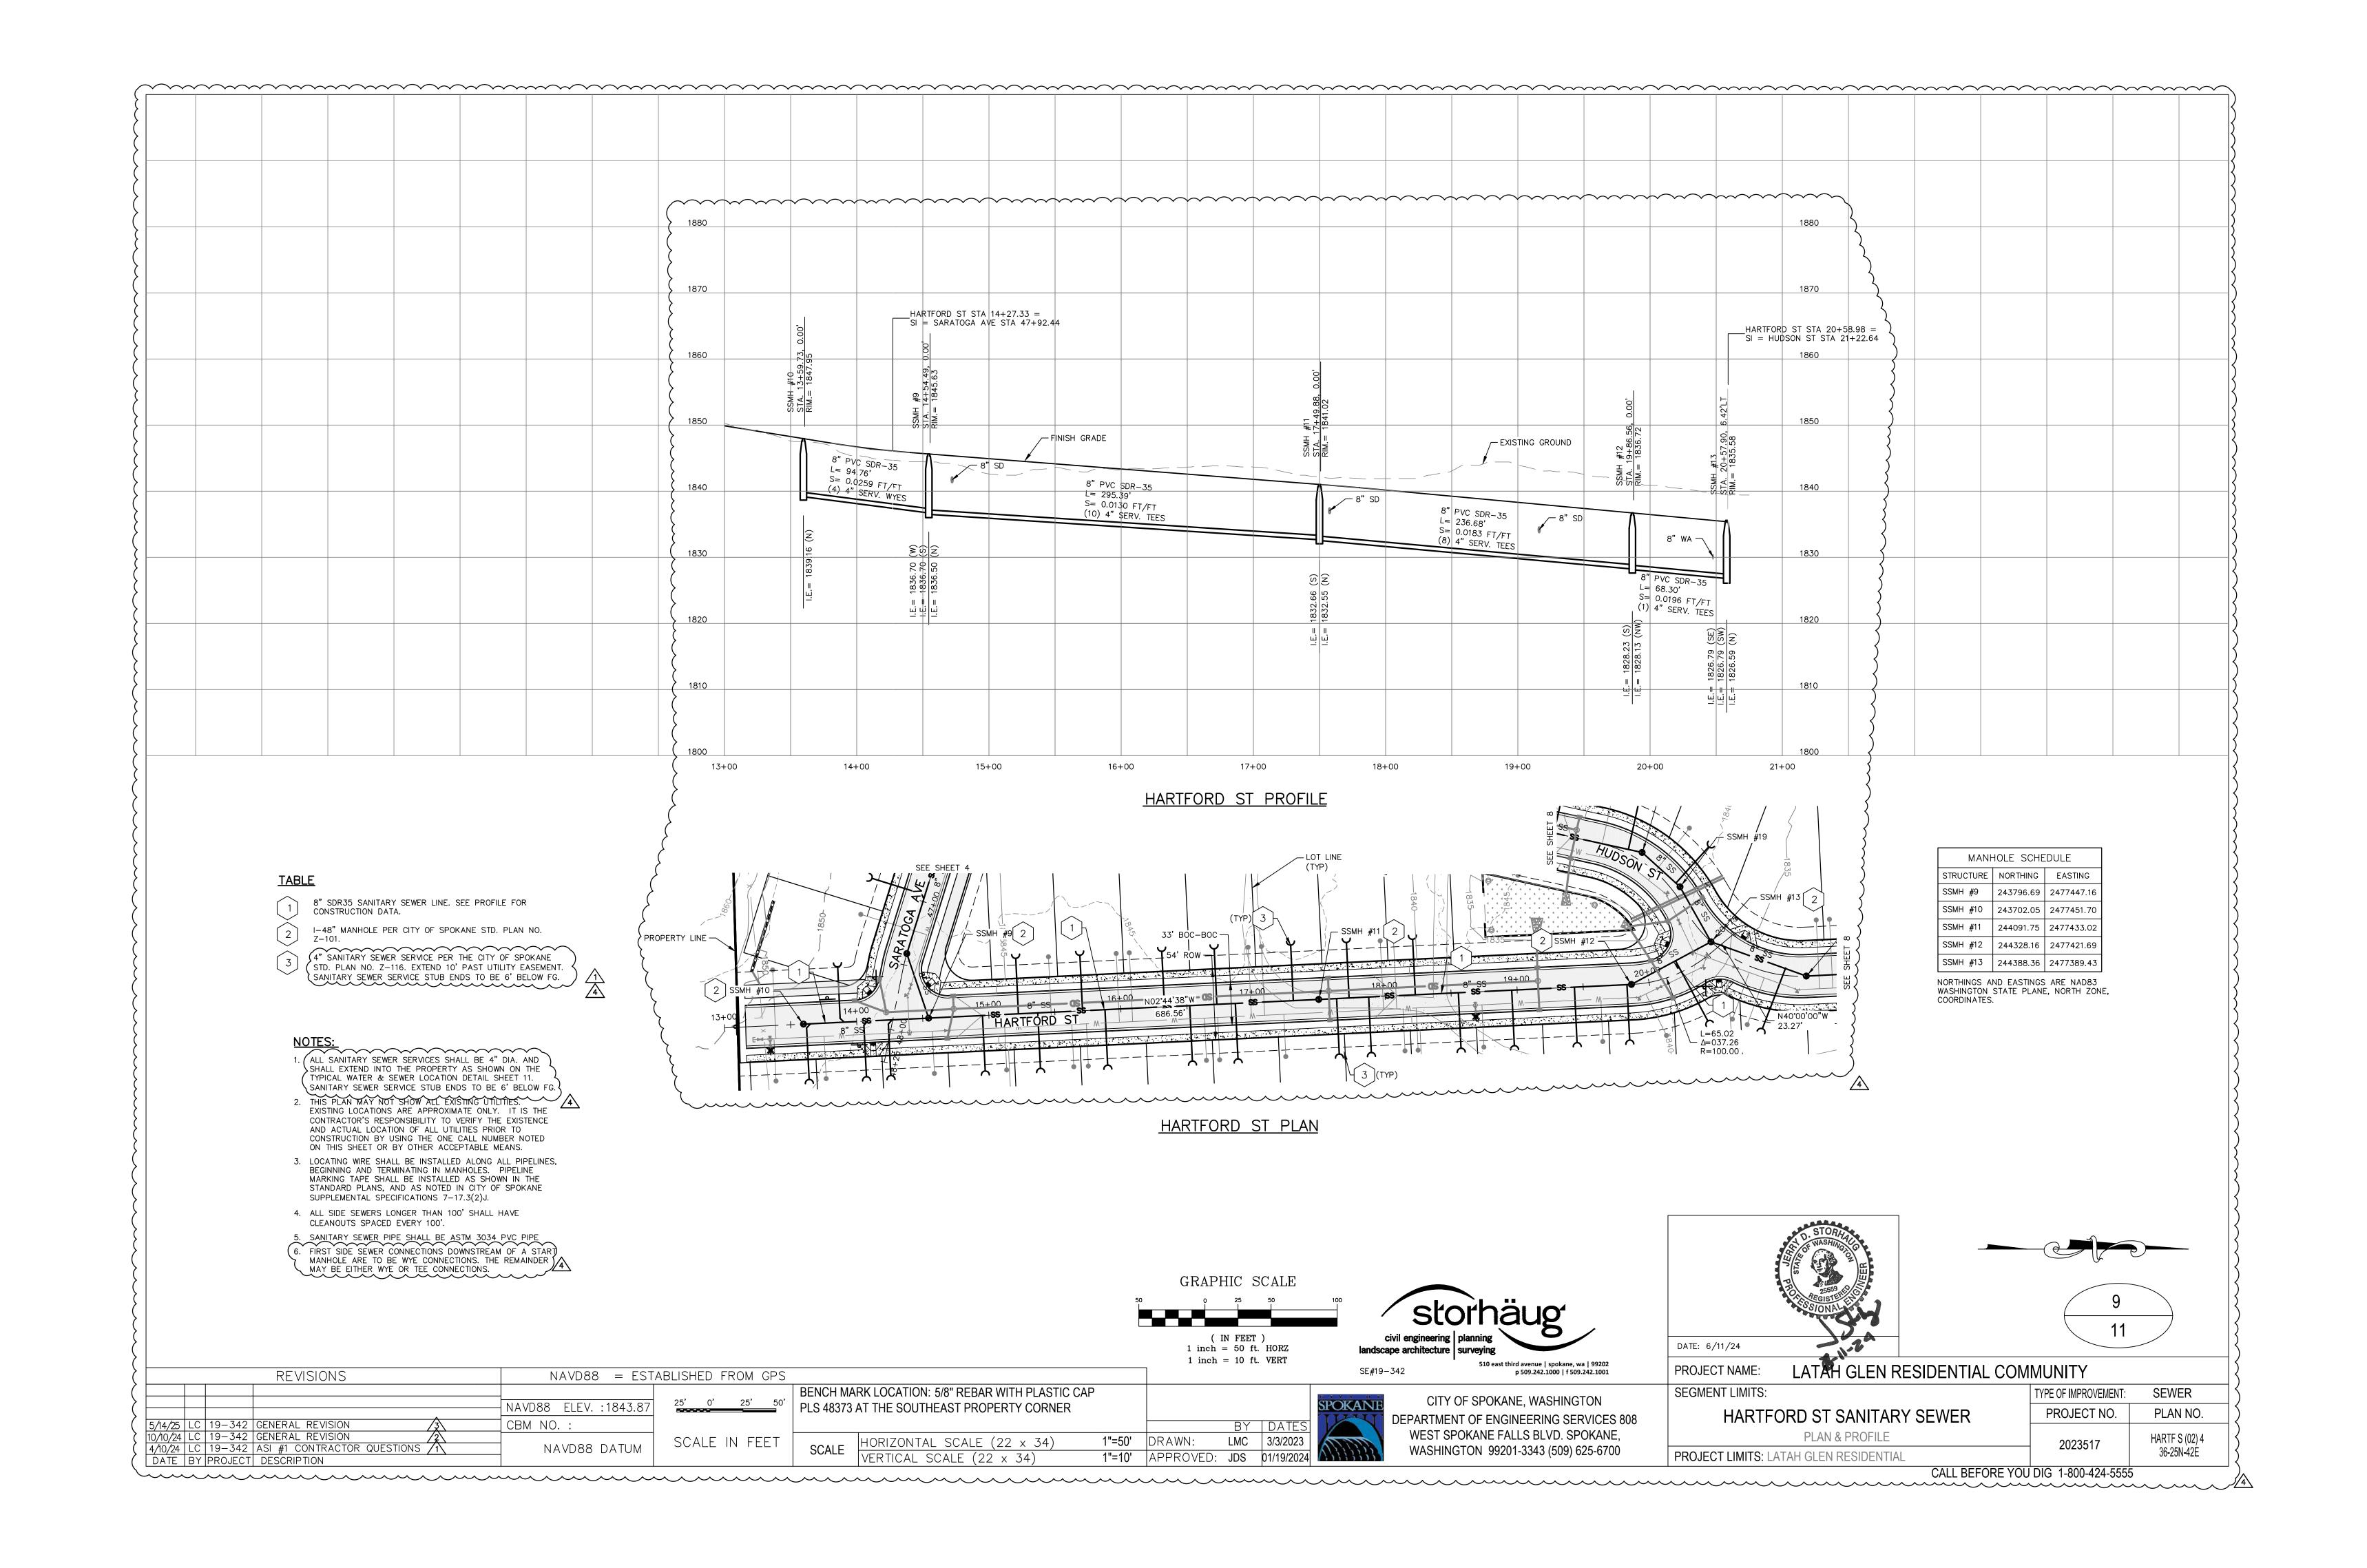

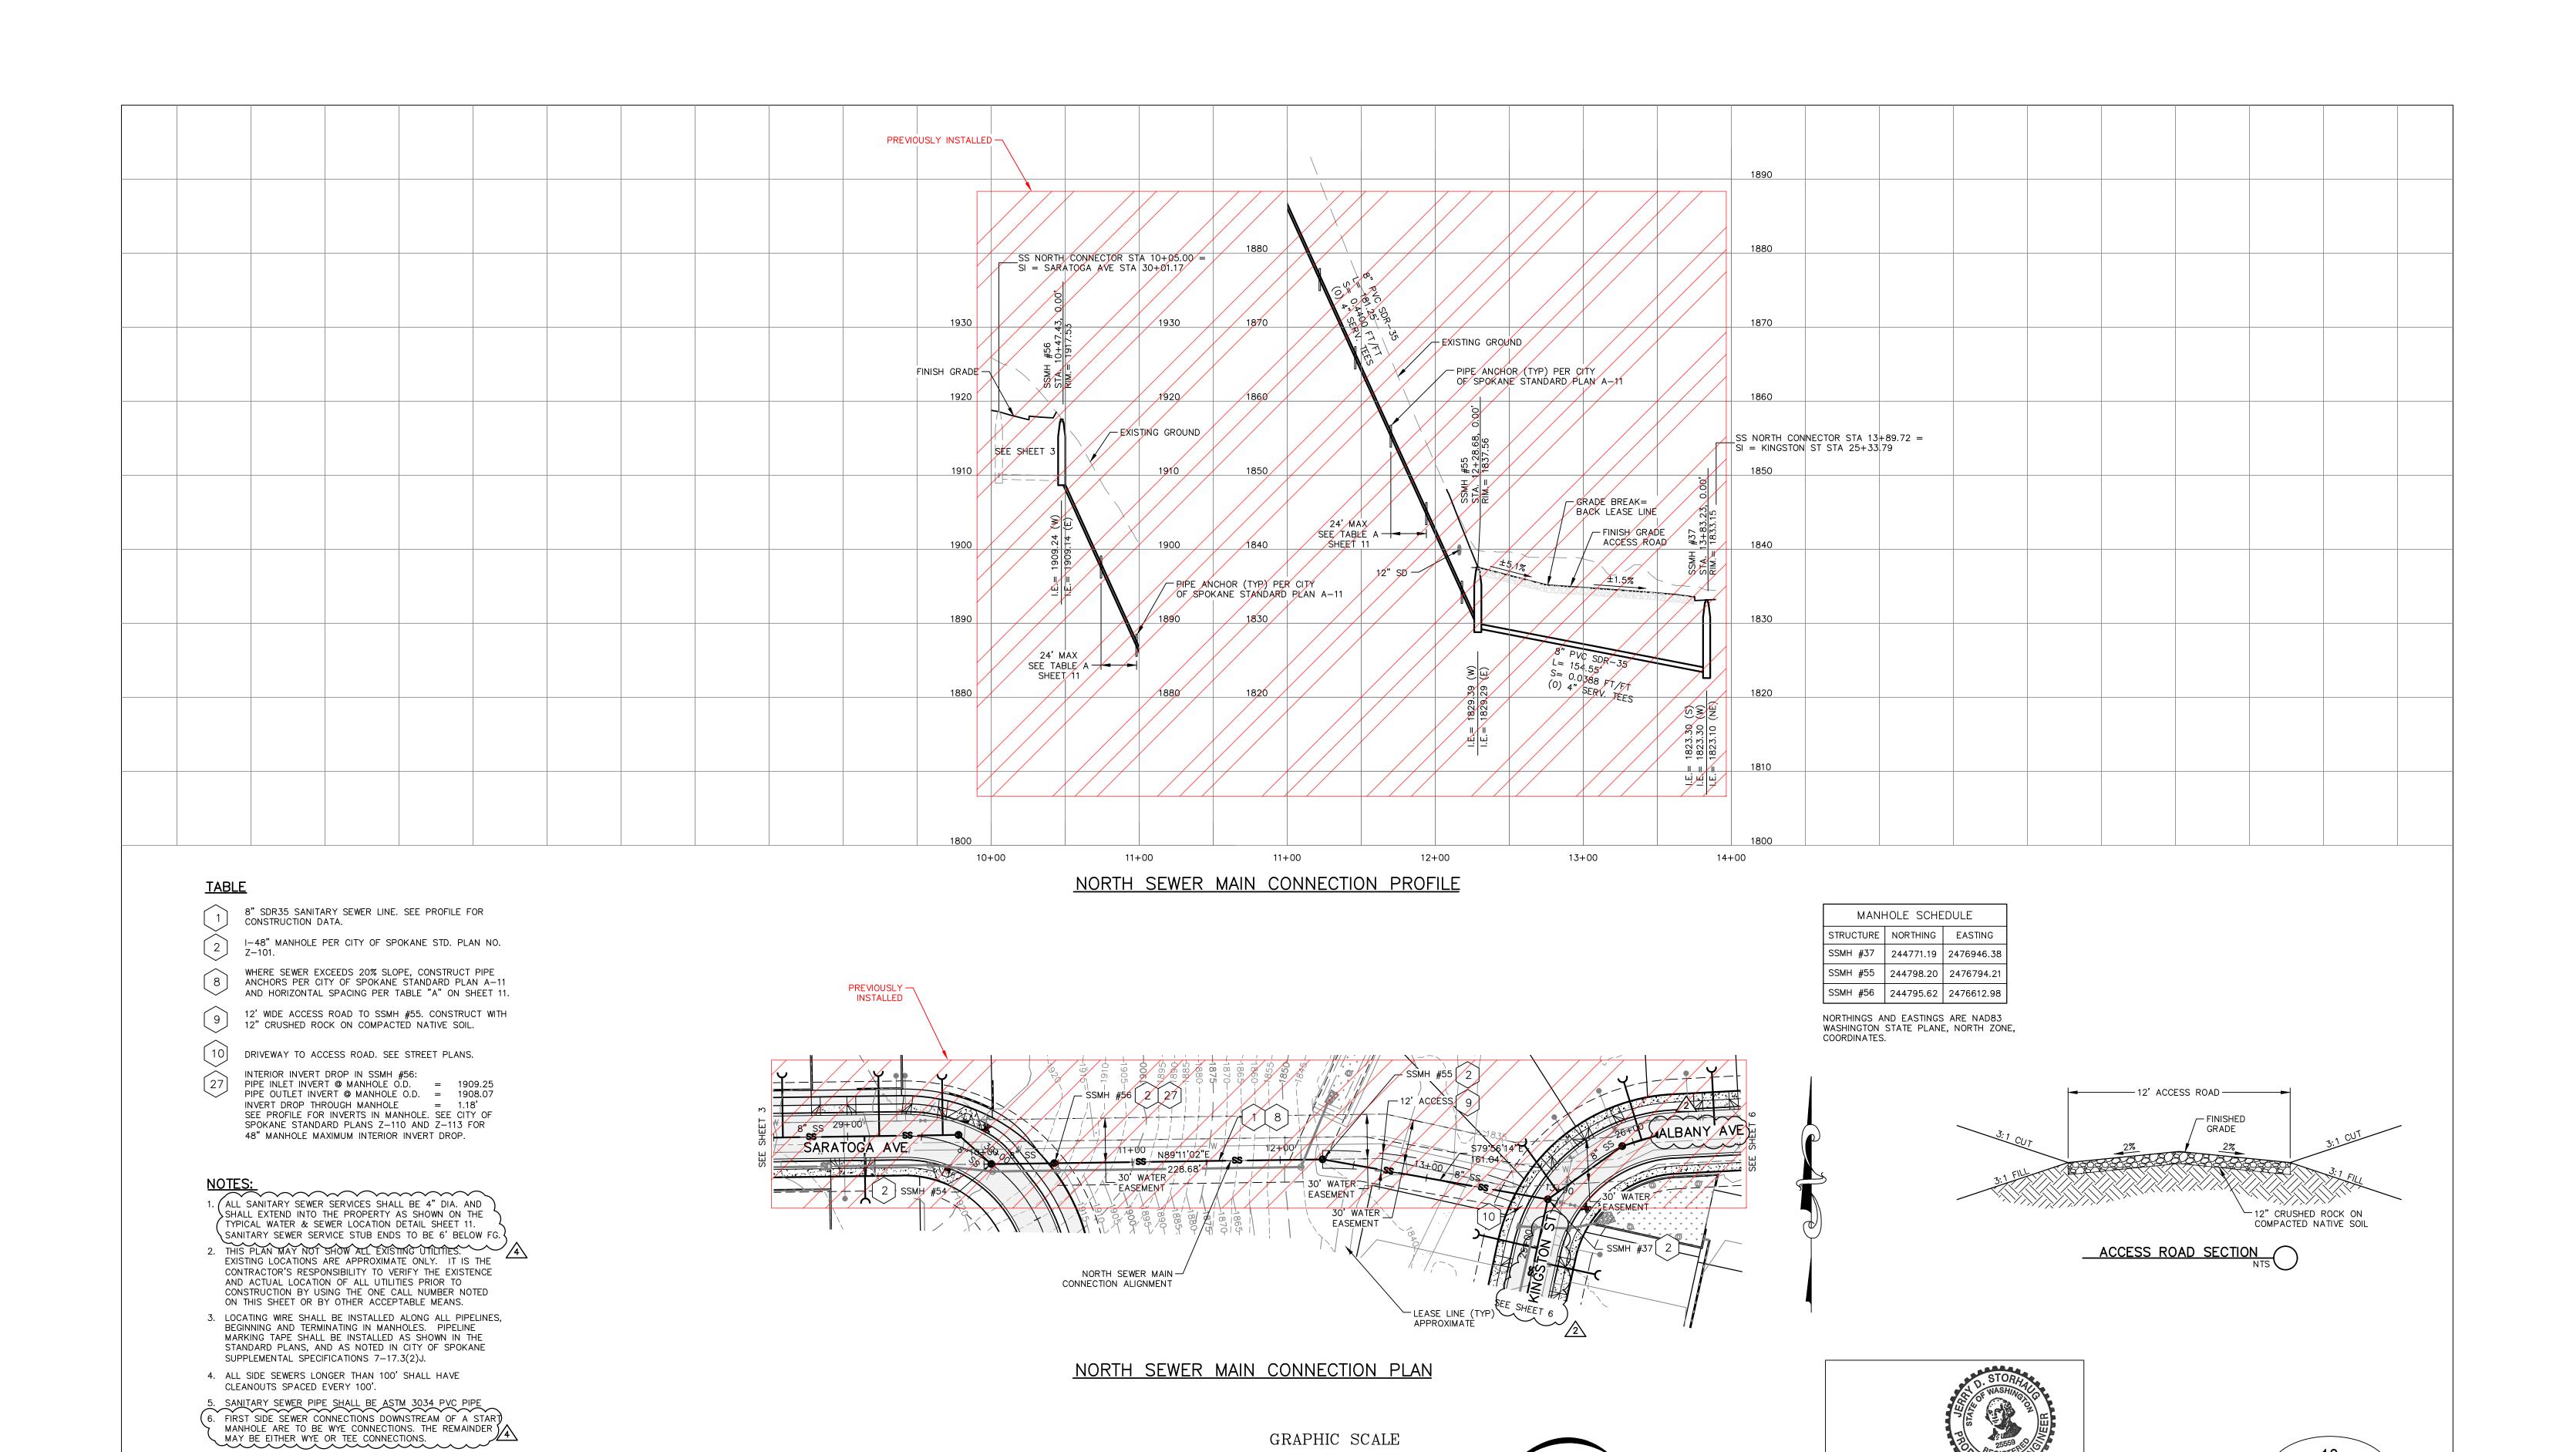


510 east third avenue | spokane, wa | 99202 p 509.242.1000 | f 509.242.1001 1 inch = 10 ft. VERTLATAH GLEN RESIDENTIAL COMMUNITY PROJECT NAME: REVISIONS NAVD88 = ESTABLISHED FROM GPS SEGMENT LIMITS: BENCH MARK LOCATION: 5/8" REBAR WITH PLASTIC CAP SEWER TYPE OF IMPROVEMENT: CITY OF SPOKANE, WASHINGTON PLS 48373 AT THE SOUTHEAST PROPERTY CORNER NAVD88 ELEV. :1843.87 NORTH SEWER MAIN CONNECTION PROJECT NO. PLAN NO. DEPARTMENT OF ENGINEERING SERVICES 808 5/14/25 LC 19-342 GENERAL REVISION
10/10/24 LC 19-342 GENERAL REVISION
2
4/10/24 LC 19-342 ASI #1 CONTRACTOR QUESTIONS
1
DATE BY PROJECT DESCRIPTION CBM NO. WEST SPOKANE FALLS BLVD. SPOKANE, PLAN & PROFILE SCALE IN FEET HORIZONTAL SCALE (22 x 34) LMC 3/3/2023 1"=50' |DRAWN: 2023517 NAVD88 DATUM WASHINGTON 99201-3343 (509) 625-6700 36-25N-42E 1"=10' APPROVED: JDS 01/19/2024 VERTICAL SCALE (22 x 34) PROJECT LIMITS: LATAH GLEN RESIDENTIAL CALL BEFORE YOU DIG 1-800-424-5555


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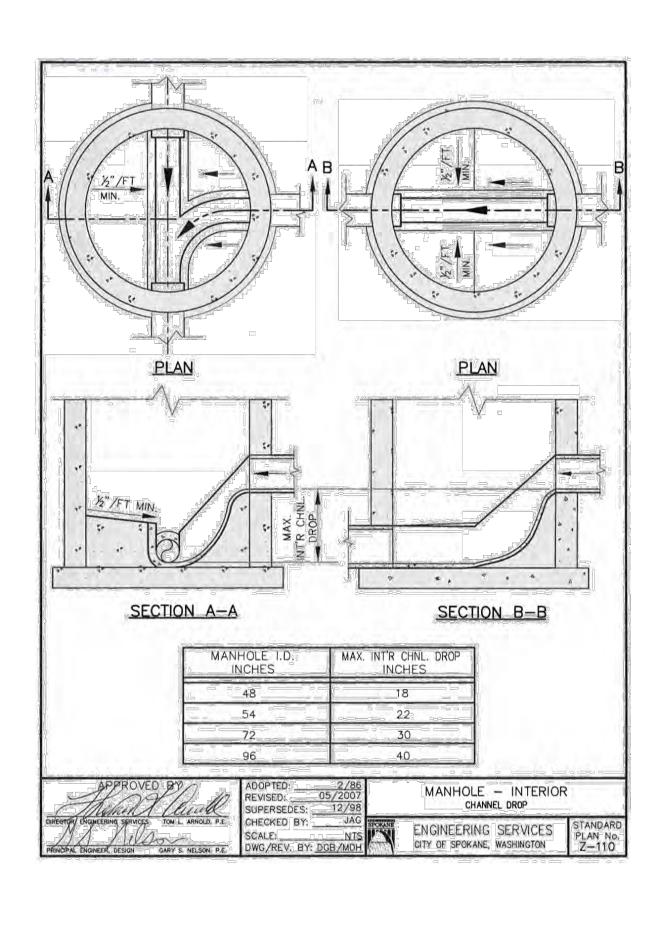
landscape architecture | surveying


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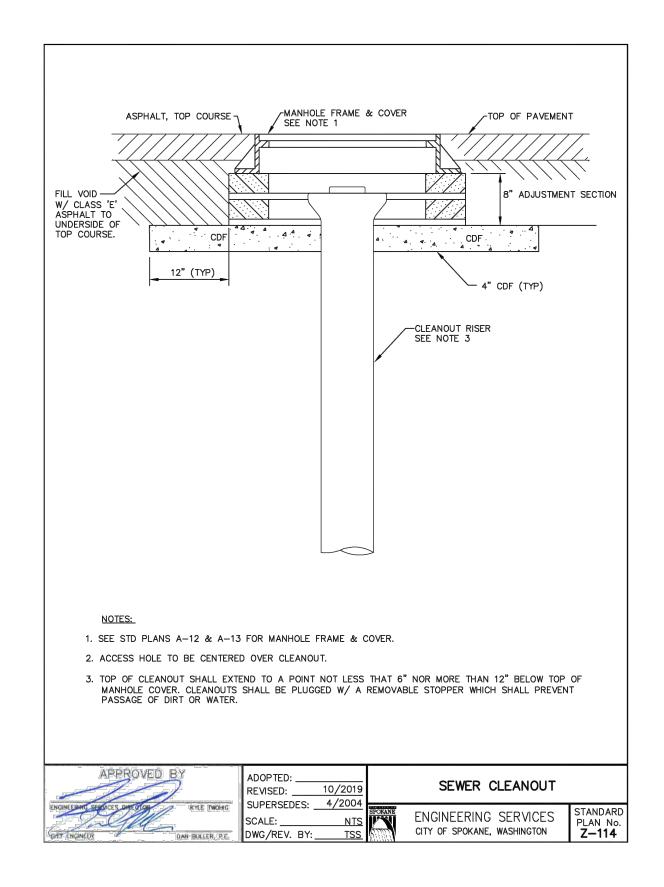





SUPERSEDES _ _ _ ENGR. DIVISION SPOKANE, WA

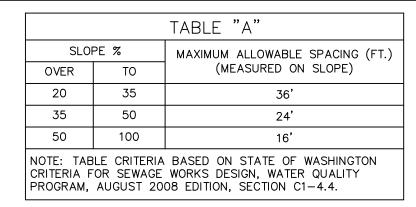


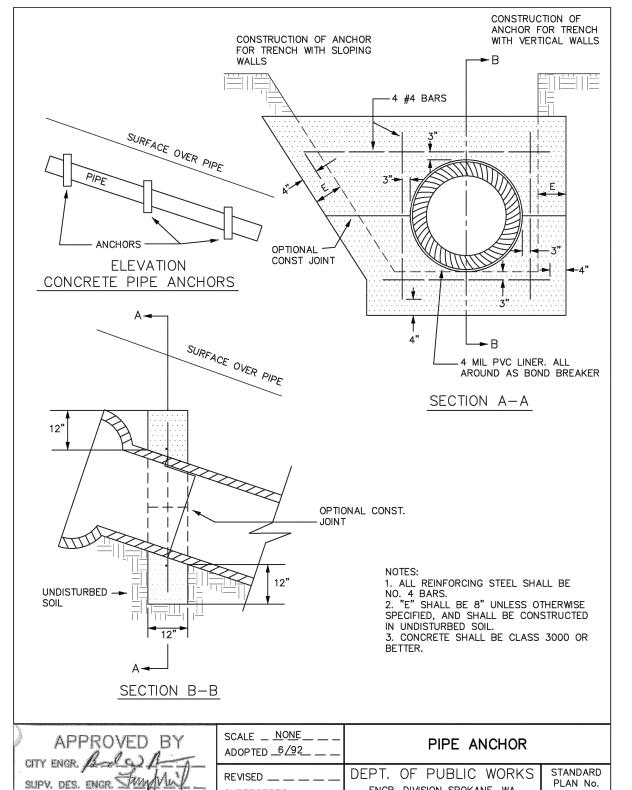

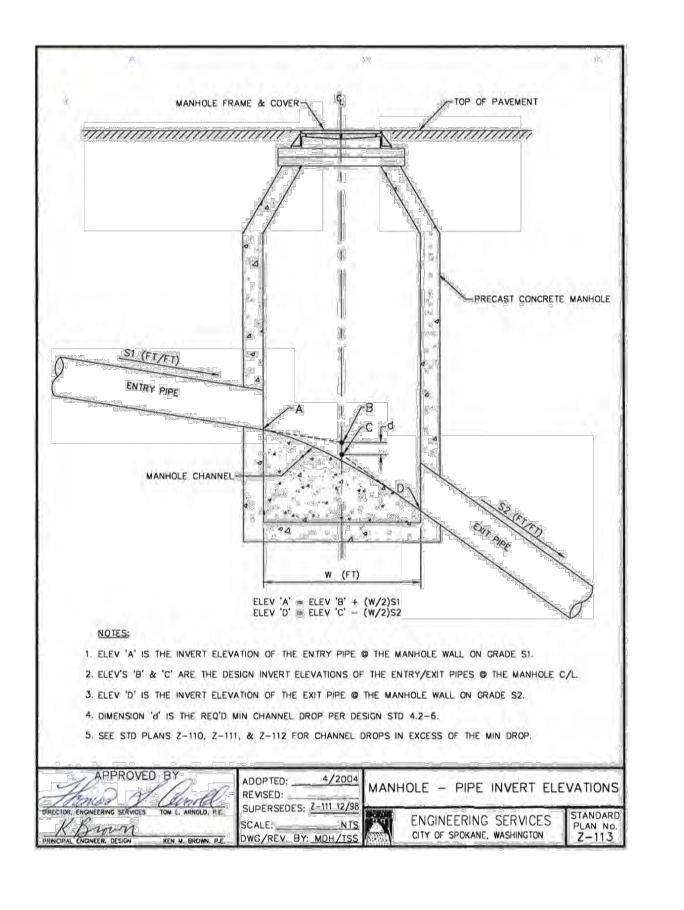

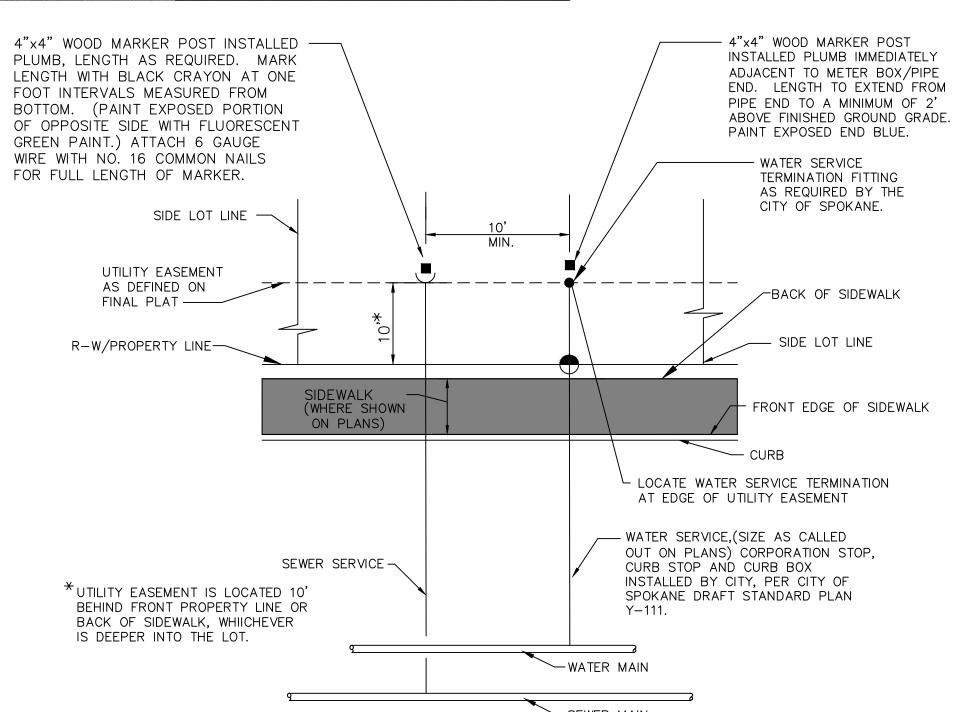




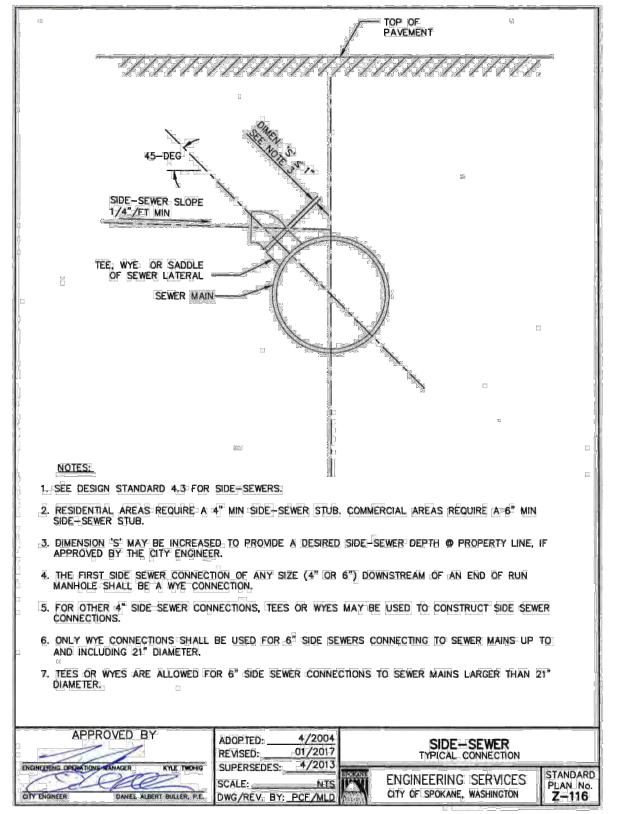



CITY OF SPOKANE, WASHINGTON
DEPARTMENT OF ENGINEERING SERVICES 808
WEST SPOKANE FALLS BLVD. SPOKANE,
WASHINGTON 99201-3343 (509) 625-6700



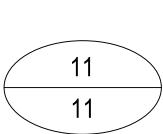

SEGMENT LIMITS:

SEWER DETAILS

PROJECT LIMITS: LATAH GLEN RESIDENTIAL

 TYPE OF IMPROVEMENT:
 SEWER

 PROJECT NO.
 PLAN NO.

 2023517
 36-25N-42E

CALL BEFORE YOU DIG 1-800-424-5555

			REVISIONS			N	AVD88	= EST	ABLISH	HED	FROM	GP
						NAVD88	ELEV.	:1843.87	25'	0'	25'	5
5/14/25	LC	19-342	GENERAL REVISION	<b>1</b> 3	\	СВМ NO.	. :		1			
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	RK LOCATION: 5/8" REBAR WITH PLASTIC CAP AT THE SOUTHEAST PROPERTY CORNER				SPO	
				BY	DATES	
SCALE	HORIZONTAL SCALE (22 x 34)	NTS	DRAWN:	LMC	3/3/2023	
SCALE	VERTICAL SCALE (22 x 34)	NTS	APPROVED:	JDS	01/19/2024	1

### WATER IMPROVEMENTS

# LATAH GLEN RESIDENTIAL COMMUNITY

SECTION 36, TOWNSHIP 25 NORTH, RANGE 42 EAST, W.M., CITY OF SPOKANE, SPOKANE COUNTY, WASHINGTON

# PROJECT AREA

### VICINITY MAP

### GENERAL NOTES


- 1. THE CONTRACTOR SHALL BE RESPONSIBLE FOR OBTAINING ALL NECESSARY PERMITS FROM ALL APPLICABLE AGENCIES. THE CONTRACTOR SHALL NOTIFY THE CITY OF SPOKANE PUBLIC WORKS INSPECTOR AT LEAST 48 HOURS PRIOR TO THE START OF ANY EARTH DISTURBING ACTIVITY, OR CONSTRUCTION ON ANY AND ALL SEWER AND WATER IMPROVEMENTS.
- 2. THE CONTRACTOR SHALL COORDINATE AND COOPERATE WITH THE CITY OF SPOKANE, SPOKANE COUNTY AND ALL UTILITY COMPANIES INVOLVED WITH REGARD TO RELOCATIONS OR ADJUSTMENTS OF EXISTING UTILITIES DURING CONSTRUCTION AND TO ASSURE THAT THE WORK IS ACCOMPLISHED IN A TIMELY FASHION AND WITH A MINIMUM DISRUPTION OF SERVICE. THE CONTRACTOR SHALL BE RESPONSIBLE FOR CONTACTING ALL PARTIES AFFECTED BY ANY DISRUPTION OF ANY UTILITY SERVICE.
- 3. THE CONTRACTOR SHALL HAVE ONE (1) SIGNED COPY OF THE APPROVED PLANS, ONE (1) COPY OF THE APPROPRIATE STANDARDS AND SPECIFICATIONS, AND A COPY OF ANY PERMITS AND EXTENSION AGREEMENTS NEEDED FOR THE JOB ON—SITE AT ALL TIMES.
- 4. IF, DURING THE CONSTRUCTION PROCESS, CONDITIONS ARE ENCOUNTERED BY THE CONTRACTOR, HIS SUBCONTRACTORS, OR OTHER AFFECTED PARTIES, WHICH COULD INDICATE A SITUATION THAT IS NOT IDENTIFIED IN THE PLANS OR SPECIFICATIONS, THE CONTRACTOR SHALL CONTACT THE ENGINEER IMMEDIATELY.
- 5. THE CONTRACTOR SHALL SUBMIT A TRAFFIC CONTROL PLAN IN ACCORDANCE WITH M.U.T.C.D. TO THE APPROPRIATE RIGHT—OF—WAY AUTHORITY (CITY, COUNTY, OR STATE) FOR APPROVAL PRIOR TO ANY CONSTRUCTION ACTIVITIES WITHIN, OR AFFECTING, THE RIGHT—OF—WAY. THE CONTRACTOR SHALL BE RESPONSIBLE FOR PROVIDING ANY AND ALL TRAFFIC CONTROL DEVICES AS MAY BE REQUIRED BY THE CONSTRUCTION ACTIVITIES.
- 6. THE CONTRACTOR SHALL BE RESPONSIBLE FOR KEEPING ROADWAYS FREE AND CLEAR OF ALL CONSTRUCTION DEBRIS AND DIRT TRACKED FROM THE SITE.
- 7. THE CONTRACTOR SHALL BE RESPONSIBLE FOR RECORDING AS—BUILT INFORMATION ON A SET OF RECORD DRAWINGS KEPT AT THE CONSTRUCTION SITE, AND MADE AVAILABLE TO THE CITY OF SPOKANE PUBLIC WORKS INSPECTOR AT ALL TIMES.
- 8. ALL STRUCTURAL EROSION CONTROL MEASURES SHALL BE INSTALLED, AT THE LIMITS OF CONSTRUCTION, PRIOR TO ANY OTHER GROUND—DISTURBING ACTIVITY. ALL EROSION CONTROL MEASURES SHALL BE MAINTAINED IN GOOD REPAIR BY THE CONTRACTOR, UNTIL SUCH TIME AS THE ENTIRE DISTURBED AREAS ARE STABILIZED WITH HARD SURFACE OR LANDSCAPING.
- 9. ALL WORK WITHIN THE PUBLIC RIGHT-OF-WAY IS SUBJECT TO THE JURISDICTION OF SPOKANE COUNTY.
- 10. ALL OPERATIONS CONDUCTED ON THE PREMISES, INCLUDING THE WARMING UP, REPAIR, ARRIVAL, DEPARTURE OR RUNNING OF TRUCKS, EARTHMOVING EQUIPMENT, CONSTRUCTION EQUIPMENT AND ANY OTHER ASSOCIATED EQUIPMENT SHALL GENERALLY BE LIMITED TO THE PERIOD BETWEEN 7:00 A.M. AND 10:00 P.M. WEEKDAYS, 9:00AM AND 10:00PM WEEKENDS, UNLESS OTHERWISE APPROVED BY THE COUNTY.
- 11. NO REVISIONS SHALL BE MADE TO THESE PLANS WITHOUT THE APPROVAL OF THE CITY ENGINEER AND NOTIFICATION OF THE ENGINEER OF RECORD.
- 12. STATIONING AND OFFSET IS BASED ON STATIONING FOR THE REFERENCED STREET ALIGNMENT.
- 13. EXISTING UTILITIES CONFLICTING WITH PROPOSED IMPROVEMENTS SHALL BE RELOCATED AS NEED PRIOR TO CONSTRUCTION. COORDINATE WITH APPLICABLE UTILITY COMPANY.
- 14. RESTRAINTS SHALL BE INSTALLED ON ALL PRESSURE PIPELINES IN ACCORDANCE WITH CITY OF SPOKANE STANDARDS. REFER TO RESTRAINED JOINT TABLE ON THESE PLANS.


### CITY OF SPOKANE GENERAL WATER NOTES

- UNLESS SPECIFICALLY EXCEPTED IN THE PLANS OR CONTRACT DOCUMENTS, ALL CONSTRUCTION METHODS AND MATERIALS SHALL BE IN ACCORDANCE WITH STANDARD SPECIFICATIONS AND STANDARD PLANS FOR ROAD, BRIDGE, AND MUNICIPAL CONSTRUCTION PROMULGATED BY THE WASHINGTON STATE DEPARTMENT OF TRANSPORTATION, THE WASHINGTON CHAPTER OF THE AMERICAN PUBLIC WORKS ASSOCIATION (LATEST EDITION), THE CITY OF SPOKANE SUPPLEMENTAL SPECIFICATIONS AND THE CITY OF SPOKANE GENERAL SPECIAL PROVISIONS FOR PRIVATE CONTRACTS.
- 2. THESE PLANS ARE SCHEMATIC AND ARE NOT INTENDED TO DEPICT ALL DETAILS OF THE WORK REQUIRED. THE CONTRACTOR SHALL BE RESPONSIBLE TO FAMILIARIZE HIMSELF WITH ACTUAL SITE CONDITIONS, REQUIREMENTS AND FACTORS AFFECTING THE WORK. WHERE LACK OF DETAIL OR CONFLICT EXISTS BETWEEN THESE AND OTHER PLANS. THE CONTRACTOR SHALL NOTIFY THE OWNER & ENGINEER TO RESOLVE THE ISSUE PRIOR TO PROCEEDING.
- 3. THE CONTRACTOR IS RESPONSIBLE FOR PROVIDING ALL LABOR, MATERIALS AND EQUIPMENT NECESSARY FOR THE COMPLETION OF THE INTENDED IMPROVEMENTS SHOWN ON THESE DRAWINGS OR DESIGNATED TO BE PROVIDED, INSTALLED OR CONSTRUCTED, UNLESS SPECIFICALLY NOTED OTHERWISE.
- 4. EXCAVATION AND EMBANKMENT SHALL BE IN ACCORDANCE WITH APPLICABLE REQUIREMENTS OF SECTION 2-03 OF THE STANDARD SPECIFICATIONS. ALL COMPACTION SHALL BE IN ACCORDANCE WITH SECTION 2-03.3(14)C. METHOD B, AND 2-03.3(14)A, FOR ROCK EMBANKMENT.
- 5. THESE PLANS MAY NOT SHOW ALL EXISTING UTILITIES. EXISTING UTILITY LOCATIONS SHOWN ARE APPROXIMATE ONLY. IT IS THE CONTRACTOR'S RESPONSIBILITY TO VERIFY THE EXISTENCE AND ACTUAL LOCATION OF ALL UTILITIES PRIOR TO CONSTRUCTION.
- 6. SHORING AND CRIBBING FOR UTILITY CONSTRUCTION SHALL BE IN ACCORDANCE WITH APPLICABLE REQUIREMENTS OF SECTION 2.09 OF THE STANDARD SPECIFICATIONS.
- 7. ALL PIPE BEDDING SHALL BE IN ACCORDANCE WITH THE CURRENT EDITION OF CONSTRUCTION SPECIFICATIONS FOR WATER AND SEWER LINES AS ADOPTED BY THE CITY OF SPOKANE.
- 8. ALL BACKFILL MATERIAL SHALL BE IN ACCORDANCE WITH THE CURRENT EDITION OF CONSTRUCTION
- SPECIFICATIONS FOR WATER AND SEWER LINES AS ADOPTED BY THE CITY OF SPOKANE.

  9. MARKING TAPE WILL BE PLACED IN THE EXCAVATION TRENCH AT MID—DEPTH LOCATION FOR ALL UNDERGROUND WATER MAIN INSTALLATIONS FOR THE PURPOSE OF ALERTING ANY FUTURE EXCAVATION IN THE SPECIFIC AREA.
- 10. AREAS WHICH REQUIRE THE PLACEMENT OF EMBANKMENT IN ORDER TO INSTALL WATER AND SEWER, (I.E; PIPELINE INVERTS ARE ABOVE EXISTING GROUND ELEVATIONS) SHALL BE CONSTRUCTED PER THESE SPECIFICATIONS TO AN ELEVATION THREE (3) FEET ABOVE THE TOP OF PROPOSED PIPE. AT THIS POINT, TRENCHING AND BACKFILL FOR PLACEMENT OF WATER AND SEWER MAY BEGIN.
- 11. ALL SLEEVING OF SEWER AND WATER LINES, IF NECESSARY, SHALL BE PER THE CITY OF SPOKANE STANDARD A-5.
- 12. CONTRACTOR MUST NOTIFY THE GOVERNING FIRE DISTRICT WHEN FIRE HYDRANTS HAVE BEEN INSTALLED AND REQUEST TESTING OF FIRE HYDRANT FLOW REQUIREMENTS.
- 13. FIRE HYDRANTS TO BE EQUIPPED WITH STORZ FITIINGS PER THE CITY OF SPOKANE SPECIFICATIONS AND STANDARDS.
- 14. CONTRACTOR TO CONSTRUCT CUT-OFF WALLS WHERE DETERMINED BY THE CITY FIELD ENGINEER PER PLAN
- 15. ALL CONNECTIONS TO THE CITY OF SPOKANE WATER SYSTEM SHALL BE MADE BY THE CITY OF SPOKANE WATER DEPARTMENT AND PAID FOR BY DEVELOPER. THE CITY COMPLETES CONNECTION AND CHLORINATION, CONTRACTOR TO PROVIDE PARTS, EXCAVATION & BEDDING/BACKFILL/RESTORATION. PROVIDE RESTRAINED MJ CAP ON NEW PIPE (OR PLUG ON LAST NEW VALVE) AND 2" THREADED PORT WITH BALL VALVE ASSEMBLY FOR TESTING (SHALL CONSIST OF 2" DIAM. NPT 6-INCH LONG NIPPLE AND 2" NPT VALVE (CURBSTOP OR BALL TYPE) FOR TESTING/DISINFECTION). MINIMUM 48-HOUR NOTICE IS REQUIRED.


### SARATOGA AVE WATERLINE PLAN AND PROFILE STA 26+00 TO STA 38+00 SHEET NO. 3 - SARATOGA AVE WATERLINE PLAN AND PROFILE STA 38+00 TO STA 47+92 APN 25361.0048 LATHAM ST WATERLINE PLAN & PROFILE KINGSTON ST & ALBANY AVE WATERLINE PLAN & PROFILE WALDEN ST WATERLINE APN 25361.0048 SHEET NO. 7 - HUDSON ST WATERLINE PLAN & PROFILE HARTFORD ST WATERLINE PLAN & PROFILE SHEET NO. 9 - WATER METER CONNECTIONS SHEET NO. 10 - DOMESTIC WATER DETAILS BENCH BENCH SARATOGA AVE

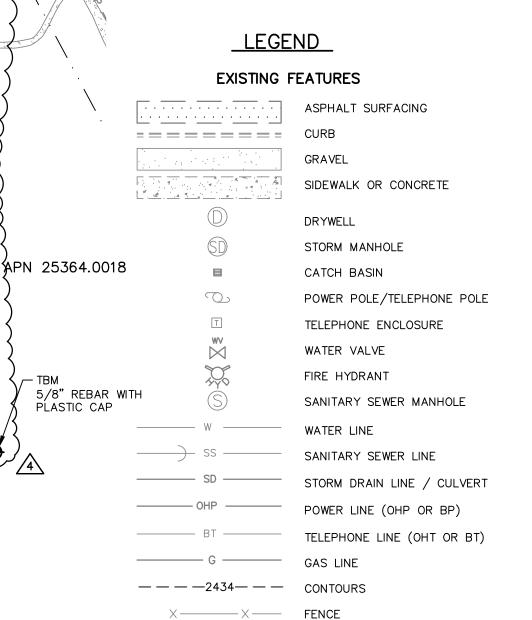


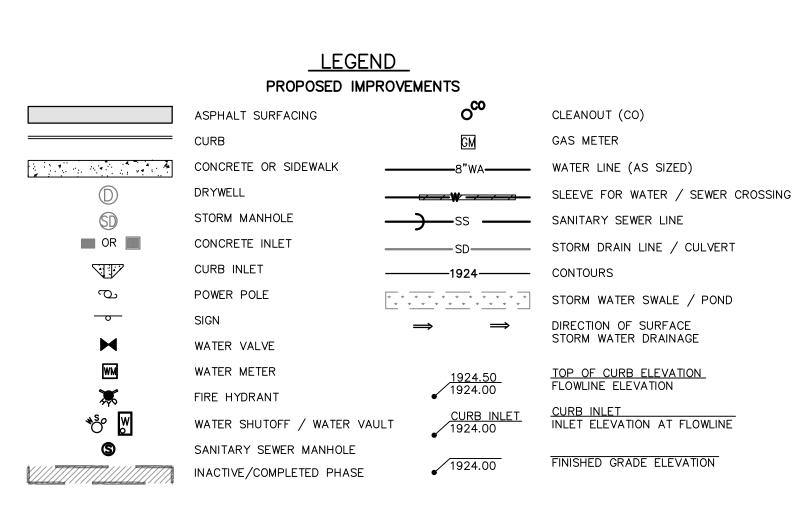



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REVISIONS	NAVD88 = ESTABLIS	SHED FROM GPS	SE#19-342	510 east third avenue   spokane, wa   99202 p 509.242.1000   f 509.242.1001	PROJECT NAME: LATAH GLEN RES	IDENTIAL COMMUNITY	
	NAVD88 ELEV. :1843.87	BENCH MARK LOCATION: 5/8" REBAR WITH PLASTIC CAP PLS 48373 AT THE SOUTHEAST PROPERTY CORNER	SPOKANE	CITY OF SPOKANE, WASHINGTON EPARTMENT OF ENGINEERING SERVICES 808	SEGMENT LIMITS: WATERLINE COVER	TYPE OF IMPROVEMENT: PROJECT NO.	WATER PLAN NO.
5/14/25 LC 19-342 GENERAL REVISION /3 10/10/24 LC 19-342 GENERAL REVISION /2 4/10/24 LC 19-342 ASI #1 CONTRACTOR QUESTIONS /1	CBM NO. :  NAVD88 DATUM  SC	CALE IN FEET SCALE HORIZONTAL SCALE (22 x 34)	DRAWN: IMC 3/3/2023	WEST SPOKANE FALLS BLVD. SPOKANE, WASHINGTON 99201-3343 (509) 625-6700		2023518	36-25N-42E
DATE BY PROJECT DESCRIPTION		VERTICAL SCALE (22 x 34)	APPROVED: JDS  01/19/2024		PROJECT LIMITS: LATAH GLEN RESIDENTIAL	CALL BEFORE YOU DIG 1-800-424-5555	

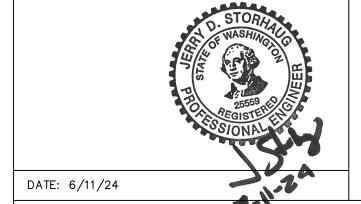
APN 25364.0001

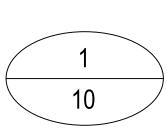APN 25364.0004

GRAPHIC SCALE

( IN FEET )

1 inch = 200 ft.

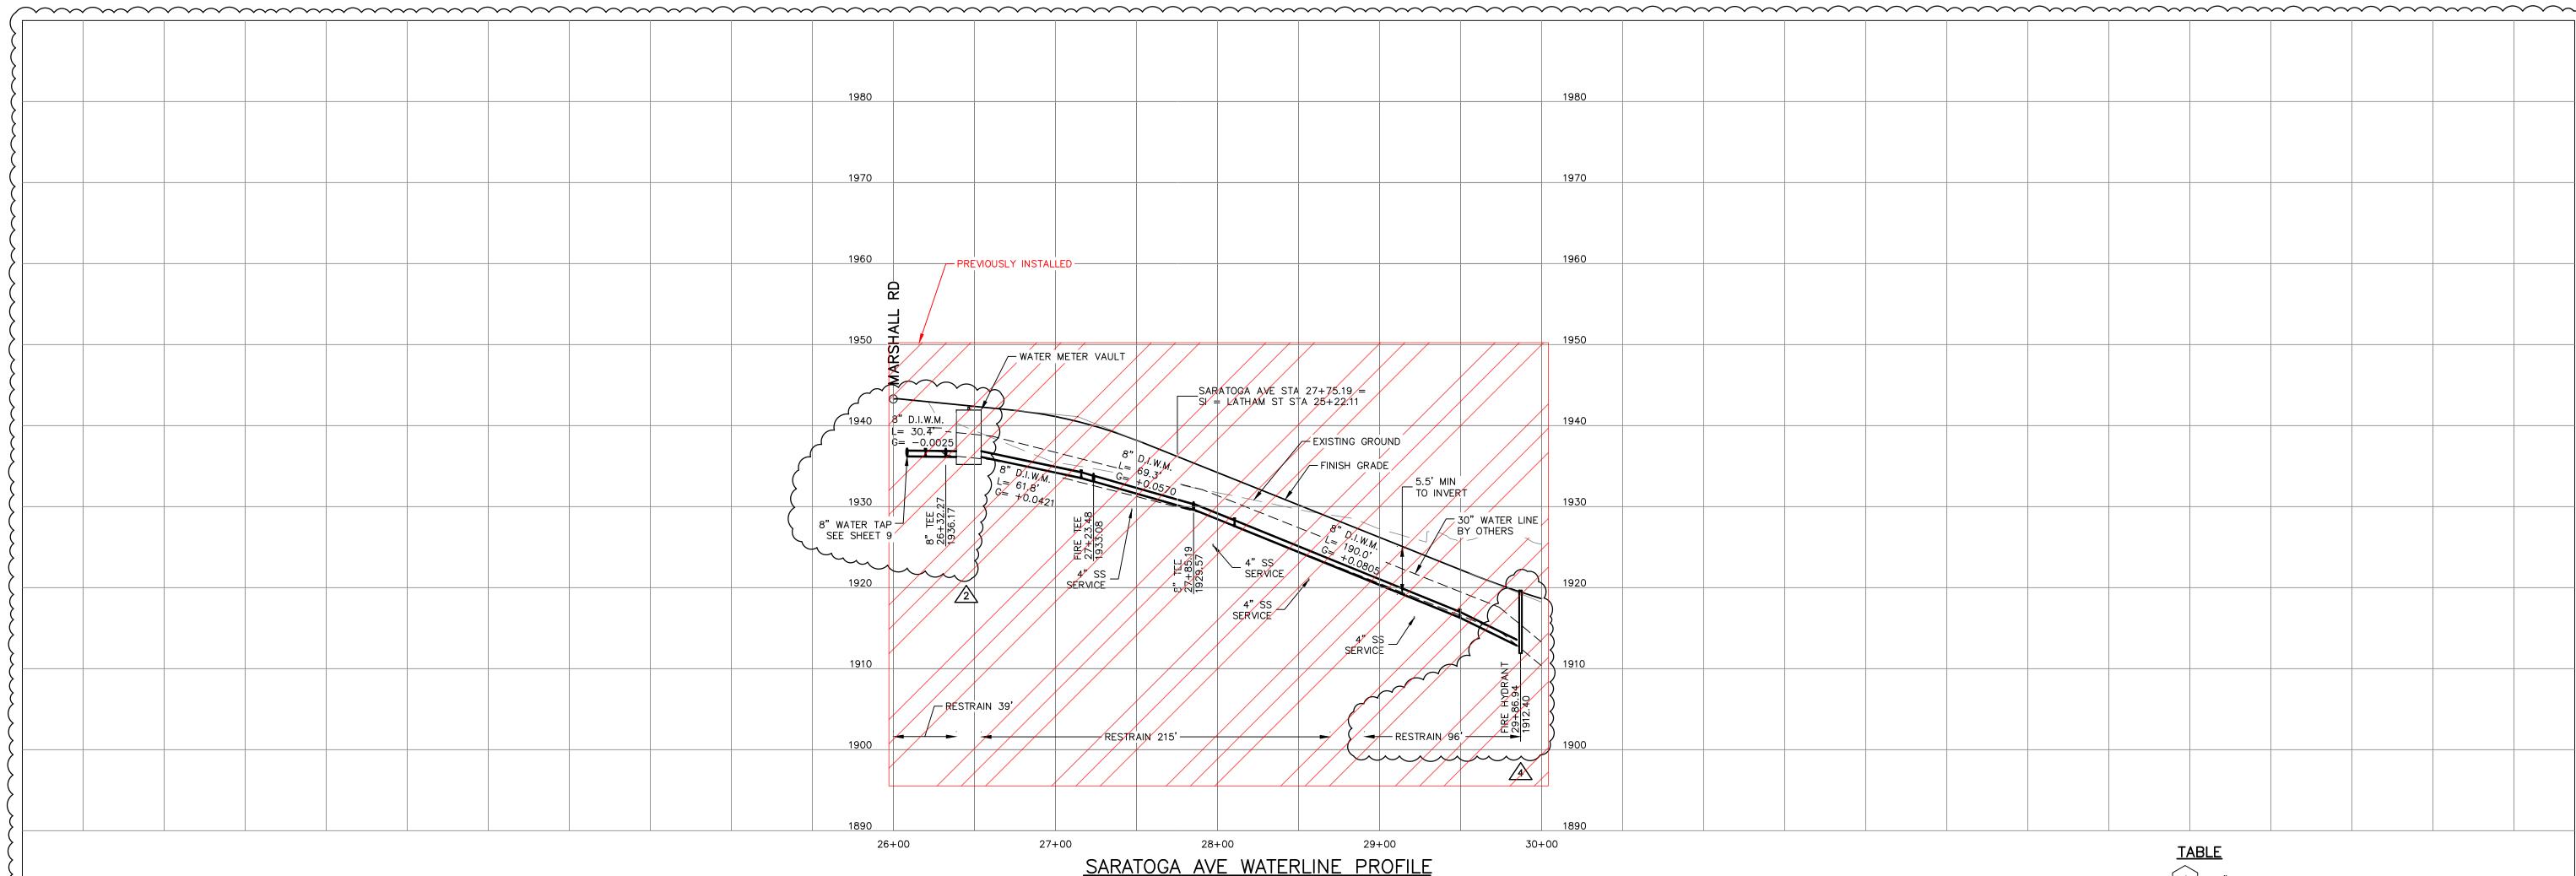

FITTING TYPE / SIZE	PIPE SIZE					
	12" & 10"	8" *	6"	4"		
	Length (feet) of Restrained Pipe Required Each Direction:					
90° bends, tee branches, valves and dead-ends 11-1/4° bends	150' 10'	59'' 3'	<del>74'</del> 6'	53' -4' -8' -14'		
22-1/2° bends	<del>10'</del>	6'	10'	8'		
45° bends	40'	🧯 11' 🤚	20'	14'		

For static system pressures greater than 85 psi, adjust as follows:

 Add 1 foot of restraint length for each psi over 85 psi for all pipe diameters in the table. For locations that are served by a Pressure Reducing Valve (PRV) restrained lengths shall reflect PRV failure. Restrained lengths shown are required each side of fitting

For pipe diameters greater than 12" restraint shall be calculated For static pressures greater than 120 psi restraint shall be calculated

THIS RESTRAINED JOINT TABLE REFLECTS CALCULATED LENGTHS FOR THE DOMESTIC WATER SYSTEM DESIGNED FOR LATAH GLEN RESIDENTIAL COMMUNITY ONLY.

SOIL TYPE = ML, GRANULAR FILL PIPE MATERIAL = DUCTILE IRON SAFETY FACTOR = 2.5TRENCH TYPE = 5


PROJECT RESTRAINED JOINT DATA:


DEPTH OF BURY = 5' DESIGN PRESSURE = 175 P.S.I. NOMINAL SIZE = 8" DIAMETER

* THE LENGTHS ARE BASED ON DESIGN PRESSURE RESULTS FROM PROJECT RESTRAINED JOINT DATA ENTERED INTO THE CALCULATOR AT WEBSITE https://rlc.ebaa.com/calculator.php.

### RESTRAINED JOINT TABLE

CALCULATED PRESSURE (UPPER BENCH) = 67 PSI - DESIGN PRESSURE = 175 PSI CALCULATED PRESSURE (LOWER BENCH) = 118 PSI - DESIGN PRESSURE = 175 PSI SEE COVER SHEET FOR BENCH DELINEATION

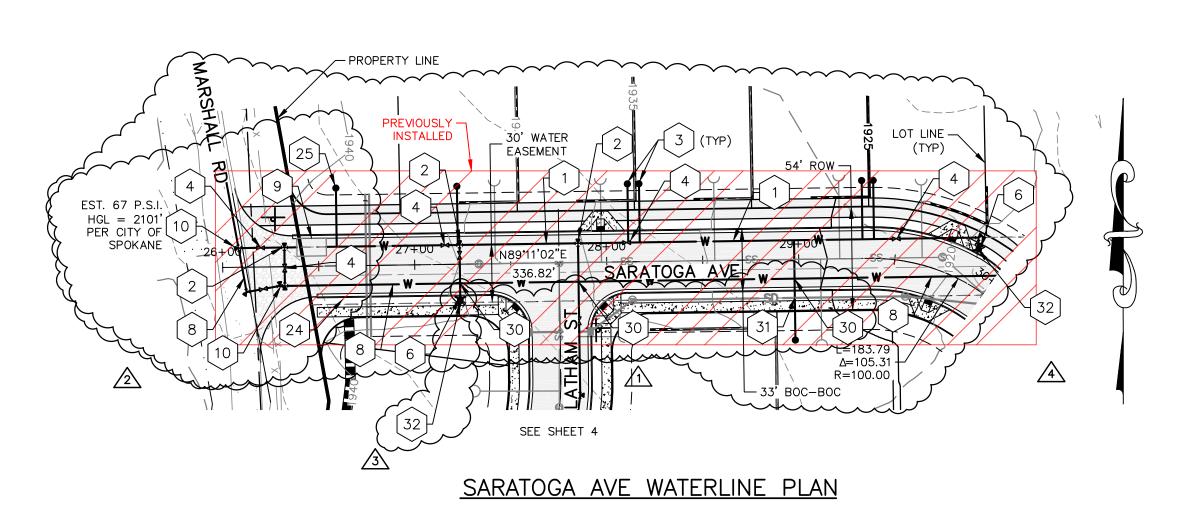

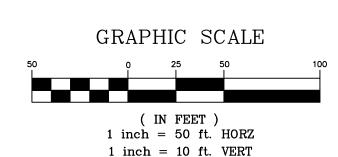



CITY OF SPOKANE, WASHINGTON WEST SPOKANE FALLS BLVD. SPOKANE,

# [ 1 ] 8" DUCTILE IRON WATERLINE.

8" TEE ALL MJ WITH RESTRAINT.

PLAN Y-111. SEE SHEET 10.

1" DOMESTIC WATER SERVICE PER CITY OF SPOKANE STD.

8" GATE VALVE.

SLEEVE WATERLINE CROSSING PER CITY OF SPOKANE STD.

PLAN A-5. SEE SHEET 10.

FIRE HYDRANT ASSEMBLY PER CITY OF SPOKANE STD. PLAN Y-101. SEE SHEET 10.

8" 90° BEND.

30" TRANSMISSION WATER MAIN TO BE INSTALLED BY THE

CITY OF SPOKANE. ( 8'x14' (INTERIOR) TRAFFIC RATED WATER METER VAULT -

PIPE STRAIGHT THROUGH FIFE STRAIGHT INKUUGH 8" WATER TAP TO BE INSTALLED BY THE CITY OF SPOKANE. TAPS TO BE LOCATED ON EITHER SIDE OF 30 VALVE. SEE SHEET 9 FOR DETAIL.

24 (2) 6" PVC CONDUITS FOR IRRIGATION SLEEVES. 2" IRRIGATION SERVICE WITH BACKFLOW PREVENTER. SEE

LANDSCAPE PLANS FOR MORE DETAIL. WATER LINE CROSSING, PRIVATE WATERLINE SHALL BE BELOW PUBLIC WATER, PER CITY OF SPOKANE STD. PLAN A-5, SEE SHEET 10.

SLEEVE WATER SERVICE UNDER THE STORM LINE, MUST BE WRAPPED WITH SPLIT FOAM PIPE INSULATION. THE END OF THE SLEEVES MUST BE SEALED WITH WATERPROOF FOAM. WATER/SEWER CROSSINGS MUST MEET CITY OF SPOKANE

STANDARD PLAN A-5. EXTEND PREVIOUSLY INSTALLED FIRE HYDRANT TO NEW _____

LATAH GLEN RESIDENTIAL COMMUNITY PROJECT NAME:

SEGMENT LIMITS:

PROJECT LIMITS: LATAH GLEN RESIDENTIAL

SARATOGA AVE WATERLINE

PLAN & PROFILE STA 26+00 TO 38+00

TYPE OF IMPROVEMENT:	WATER
PROJECT NO.	PLAN NO.
2023518	SARAT A (03) 4 36-25N-42E

CALL BEFORE YOU DIG 1-800-424-5555 

	REVISIONS			NAVD88	= ES	TABLISH	ED F	ROM
						05'	٥,	051

	REVISIONS	NAVD88 = EST	ABLISH
		NAVD88 ELEV. :1843.87	25'
9-342	GENERAL REVISION	CBM NO.:	
9-342	GENERAL REVISION /2		SCA
9-342	ASI #1 CONTRACTOR QUESTIONS /1	NAVD88 DATUM	$3CF$
ROJECT	DESCRIPTION		

87	25' 0'	2	25'	50'	
Л	SCALE	IN	FE	ΞΤ	

GPS

_	RK LOCATION: 5/8" REBAR WITH PLASTIC CAP AT THE SOUTHEAST PROPERTY CORNER				
				BY	DATES
SCALE	HORIZONTAL SCALE (22 x 34)	1"=50'	DRAWN:	LMC	3/3/2023
SCALE	VERTICAL SCALE (22 x 34)	1"-10'	APPROVED:	JDS	01/19/2024



DEPARTMENT OF ENGINEERING SERVICES 808 WASHINGTON 99201-3343 (509) 625-6700

WATER NOTES

THIS PLAN MAY NOT SHOW ALL EXISTING UTILITIES. EXISTING

3. ALL VALVES AND TEES SHALL HAVE MECHANICAL JOINT FITTINGS.

5. INDIVIDUAL PRESSURE REDUCING VALVES ARE REQUIRED ON ALL

4. WATER SERVICES SHALL BE 1" DIA. TYPE "K" COPPER OR 2" HDPE CTS AND SHALL BE EXTENDED INSIDE THE PROPERTY LINE PER CITY

6. ALL HYDRANTS SHALL BE EQUIPPED WITH STORZ FITTINGS PER CITY

7. ALL CONNECTIONS TO LIVE MAINS SHALL BE MADE BY CITY FORCES.

8. NO UTILITIES ARE TO BE INSTALLED WITHIN 5' PARALLEL TO WATER

MAINS AND SERVICE LINES. SEPARATION TO SEWERS MUST BE

WATER/SEWER LINES OR THEIR CASING SHALL HAVE 6" MINIMUM

9. WATER LINES MAY BE INSTALLED AT A MAXIMUM OF 75% OF

10. WATER LOWERINGS TO BE CONSTRUCTED PER CITY OF SPOKANE

MAINTAINED PER CITY OF SPOKANE PLANS A-4 AND A-5 CROSSING

DATE: 6/11/24

OF ALL UTILITIES PRIOR TO CONSTRUCTION.

SERVICES THAT EXCEED 80 PSI STATIC.

MANUFACTURERS MAXIMUM DEFLECTION.


STANDARD PLAN A-5. SEE DETAILS SHEET 10.


OF SPOKANE STANDARDS.

2. ALL PIPE AND APPURTENANCES SHALL BE DUCTILE IRON.

OF SPOKANE STANDARD PLAN Y-111, SEE SHEET 10.

LOCATIONS ARE APPROXIMATE ONLY. IT IS THE CONTRACTOR'S RESPONSIBILITY TO VERIFY THE EXISTENCE AND ACTUAL LOCATION

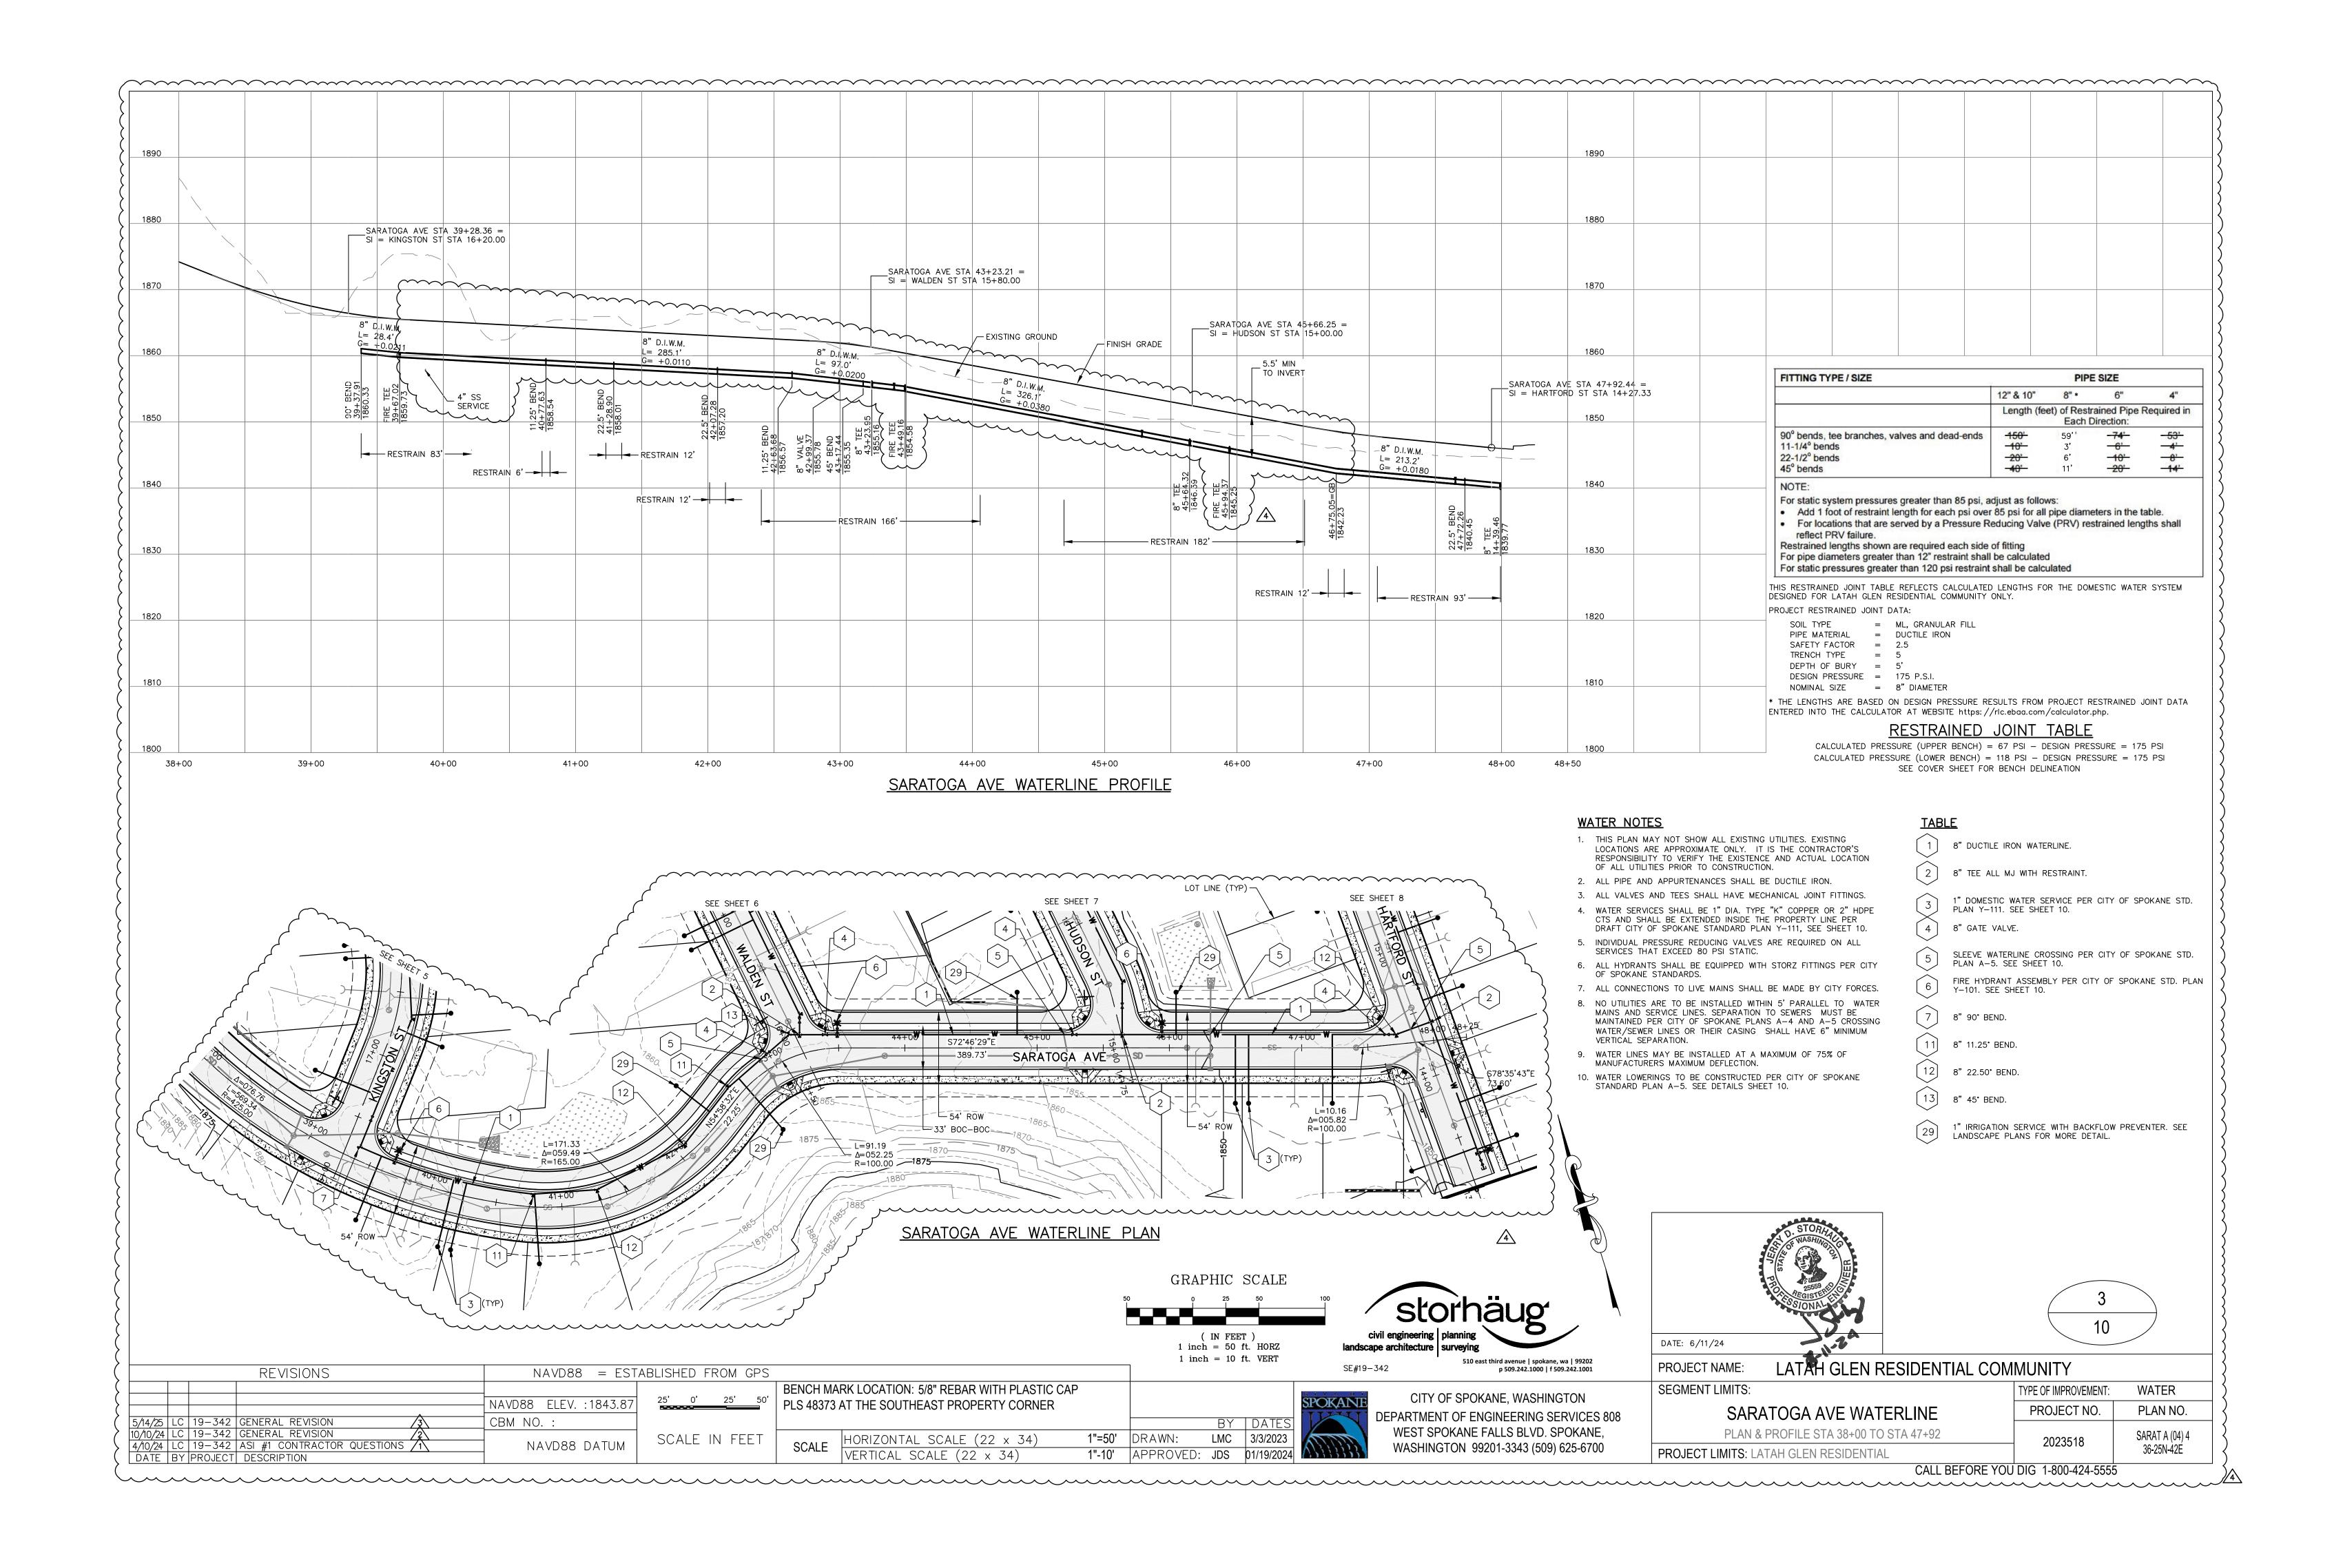

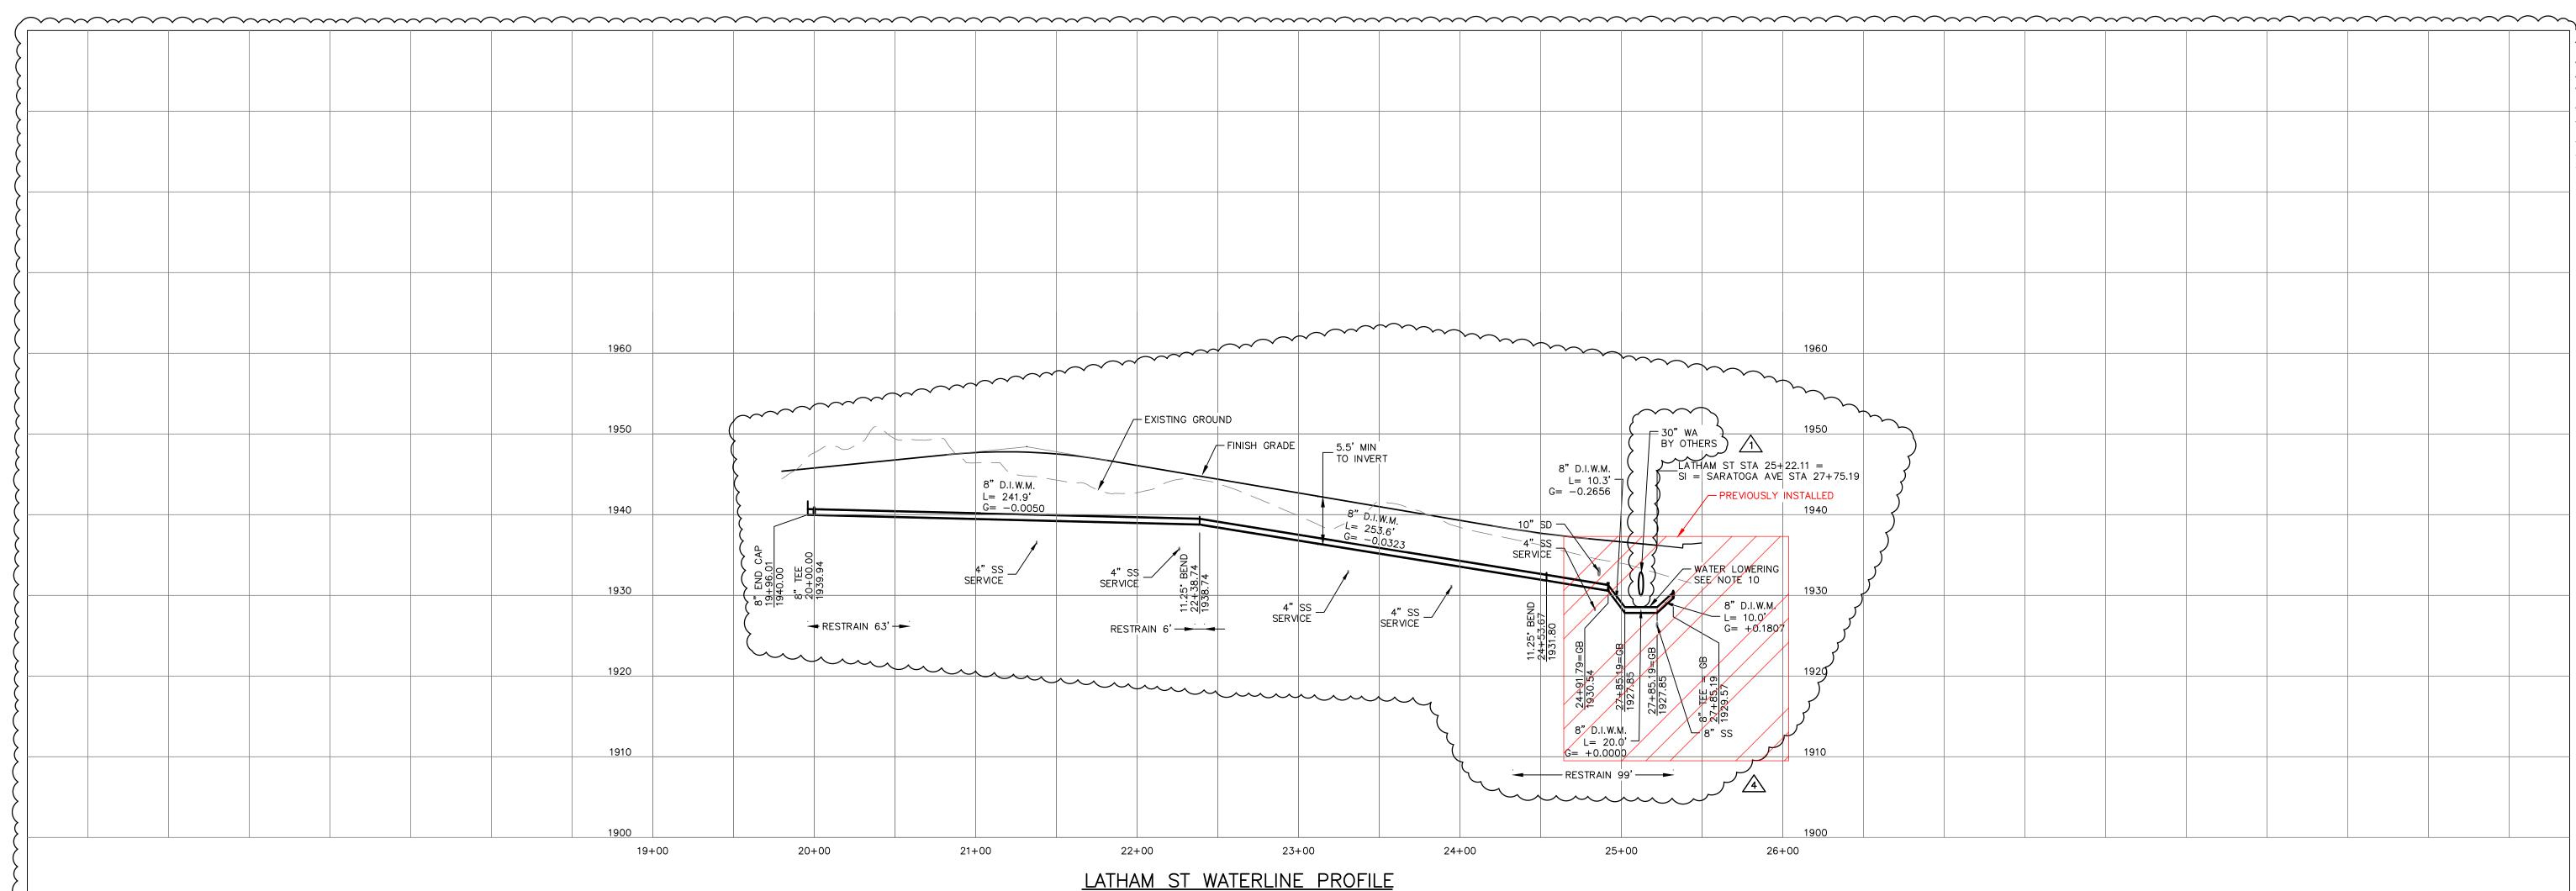

FITTING TYPE / SIZE	PIPE SIZE					
	12" & 10"	8" *	6"	4"		
	Length (feet) of Restrained Pipe Required Each Direction:					
90° bends, tee branches, valves and dead-ends	<del>-150'</del>	59''	74'	<del>- 53'</del>		
11-1/4° bends	10'	3'	6'	4'		
22-1/2° bends	20'	6'	10'	<del>4'</del> 8'		
45° bends	401	11'	201			

### NOTE:

For static system pressures greater than 85 psi, adjust as follows:

 Add 1 foot of restraint length for each psi over 85 psi for all pipe diameters in the table. For locations that are served by a Pressure Reducing Valve (PRV) restrained lengths shall reflect PRV failure.

Restrained lengths shown are required each side of fitting For pipe diameters greater than 12" restraint shall be calculated For static pressures greater than 120 psi restraint shall be calculated

THIS RESTRAINED JOINT TABLE REFLECTS CALCULATED LENGTHS FOR THE DOMESTIC WATER SYSTEM DESIGNED FOR LATAH GLEN RESIDENTIAL COMMUNITY ONLY. PROJECT RESTRAINED JOINT DATA:

SOIL TYPE = ML, GRANULAR FILL PIPE MATERIAL = DUCTILE IRON SAFETY FACTOR = 2.5TRENCH TYPE = 5 DEPTH OF BURY = 5' DESIGN PRESSURE = 175 P.S.I. NOMINAL SIZE = 8" DIAMETER

* THE LENGTHS ARE BASED ON DESIGN PRESSURE RESULTS FROM PROJECT RESTRAINED JOINT DATA ENTERED INTO THE CALCULATOR AT WEBSITE https://rlc.ebaa.com/calculator.php.

### RESTRAINED JOINT TABLE


CALCULATED PRESSURE (UPPER BENCH) = 67 PSI - DESIGN PRESSURE = 175 PSI CALCULATED PRESSURE (LOWER BENCH) = 118 PSI - DESIGN PRESSURE = 175 PSI SEE COVER SHEET FOR BENCH DELINEATION

# SEE SHEET 2 — Δ=009.91 R=100.00 -√33' BOC+BOC,/ – Δ=007.97 N00°48'58"W PREVIOUSLY INSTALLED <u>LATHAM ST WATERLINE PLAN</u>


## WATER NOTES

- 1. THIS PLAN MAY NOT SHOW ALL EXISTING UTILITIES. EXISTING LOCATIONS ARE APPROXIMATE ONLY. IT IS THE CONTRACTOR'S RESPONSIBILITY TO VERIFY THE EXISTENCE AND ACTUAL LOCATION OF ALL UTILITIES PRIOR TO CONSTRUCTION.
- 2. ALL PIPE AND APPURTENANCES SHALL BE DUCTILE IRON.
- 3. ALL VALVES AND TEES SHALL HAVE MECHANICAL JOINT FITTINGS. 4. WATER SERVICES SHALL BE 1" DIA. TYPE "K" COPPER OR 2" HDPE CTS AND SHALL BE EXTENDED INSIDE THE PROPERTY LINE PER
- DRAFT CITY OF SPOKANE STANDARD PLAN Y-111, SEE SHEET 10. 5. INDIVIDUAL PRESSURE REDUCING VALVES ARE REQUIRED ON ALL
- SERVICES THAT EXCEED 80 PSI STATIC. 6. ALL HYDRANTS SHALL BE EQUIPPED WITH STORZ FITTINGS PER CITY
- OF SPOKANE STANDARDS.
- 7. ALL CONNECTIONS TO LIVE MAINS SHALL BE MADE BY CITY FORCES. 8. NO UTILITIES ARE TO BE INSTALLED WITHIN 5' PARALLEL TO WATER MAINS AND SERVICE LINES. SEPARATION TO SEWERS MUST BE MAINTAINED PER CITY OF SPOKANE PLANS A-4 AND A-5 CROSSING WATER/SEWER LINES OR THEIR CASING SHALL HAVE 6" MINIMUM VERTICAL SEPARATION.
- 9. WATER LINES MAY BE INSTALLED AT A MAXIMUM OF 75% OF MANUFACTURERS MAXIMUM DEFLECTION.
- 10. WATER LOWERINGS TO BE CONSTRUCTED PER CITY OF SPOKANE STANDARD PLAN A-5. SEE DETAILS SHEET 10.

- 1 8" DUCTILE IRON WATERLINE.
- 8" TEE ALL MJ WITH RESTRAINT.
- 1" DOMESTIC WATER SERVICE PER CITY OF SPOKANE STD. PLAN Y-111. SEE SHEET 10.
- 8" GATE VALVE.
- SLEEVE WATERLINE CROSSING PER CITY OF SPOKANE STD. PLAN A-5. SEE SHEET 10.
- FIRE HYDRANT ASSEMBLY PER CITY OF SPOKANE STD. PLAN Y-101. SEE SHEET 10.
- 8" 90° BEND.
- 11 8" 11.25° BEND.
- 2" IRRIGATION SERVICE WITH BACKFLOW PREVENTER. SEE LANDSCAPE PLANS FOR MORE DETAIL.

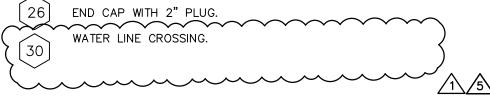



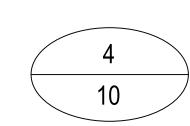

REVISIONS	<u> </u>	IAVD88	= ES	TABLISH	HED	FROM	GPS
	N A V / D O O		40470	7 25'	o'	25'	50'

				NAVD88 ELEV. :1843.8
5/14/25	LC	19-342	GENERAL REVISION 3	CBM NO. :
10/10/24			GENERAL REVISION  ASI #1 CONTRACTOR QUESTIONS 1	N
4/10/24 DATE	_	+	DESCRIPTION	NAVD88 DATUM

.87	25' 0'	25' 50'
M	SCALE	IN FEET

25' 50'		RK LOCATION: 5/8" REBAR WITH PLASTIC CAI AT THE SOUTHEAST PROPERTY CORNER	P			
					BY	DATES
IN FEET	SCALE	HORIZONTAL SCALE (22 x 34)	1"=50'	DRAWN:	LMC	3/3/2023
	SUALE	VERTICAL SCALE (22 x 34)	1"-10'	APPROVED:	JDS	01/19/2024



GRAPHIC SCALE

( IN FEET )

1 inch = 50 ft. HORZ

1 inch = 10 ft. VERT

CITY OF SPOKANE, WASHINGTON DEPARTMENT OF ENGINEERING SERVICES 808 WEST SPOKANE FALLS BLVD. SPOKANE, WASHINGTON 99201-3343 (509) 625-6700

510 east third avenue | spokane, wa | 99202 p 509.242.1000 | f 509.242.1001


LATAH GLEN RESIDENTIAL COMMUNITY PROJECT NAME: SEGMENT LIMITS:


LATHAM ST WATERLINE PLAN & PROFILE


PROJECT LIMITS: LATAH GLEN RESIDENTIAL


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	TYPE OF IMPROVEMENT:	WATER			
	PROJECT NO.	PLAN NO.			
	2023518	LATHA S (02) 4 36-25N-42E			


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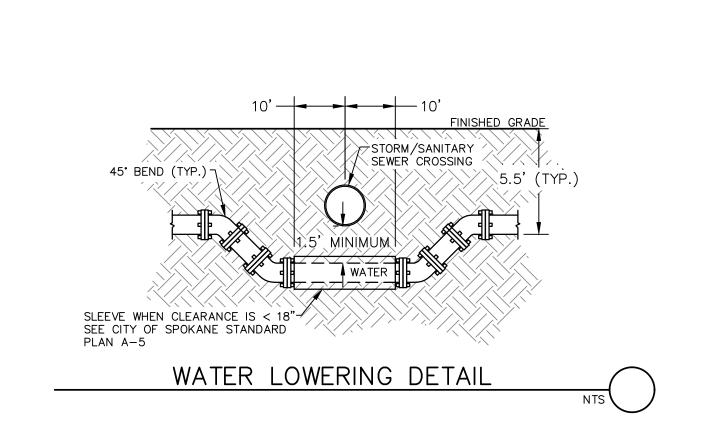


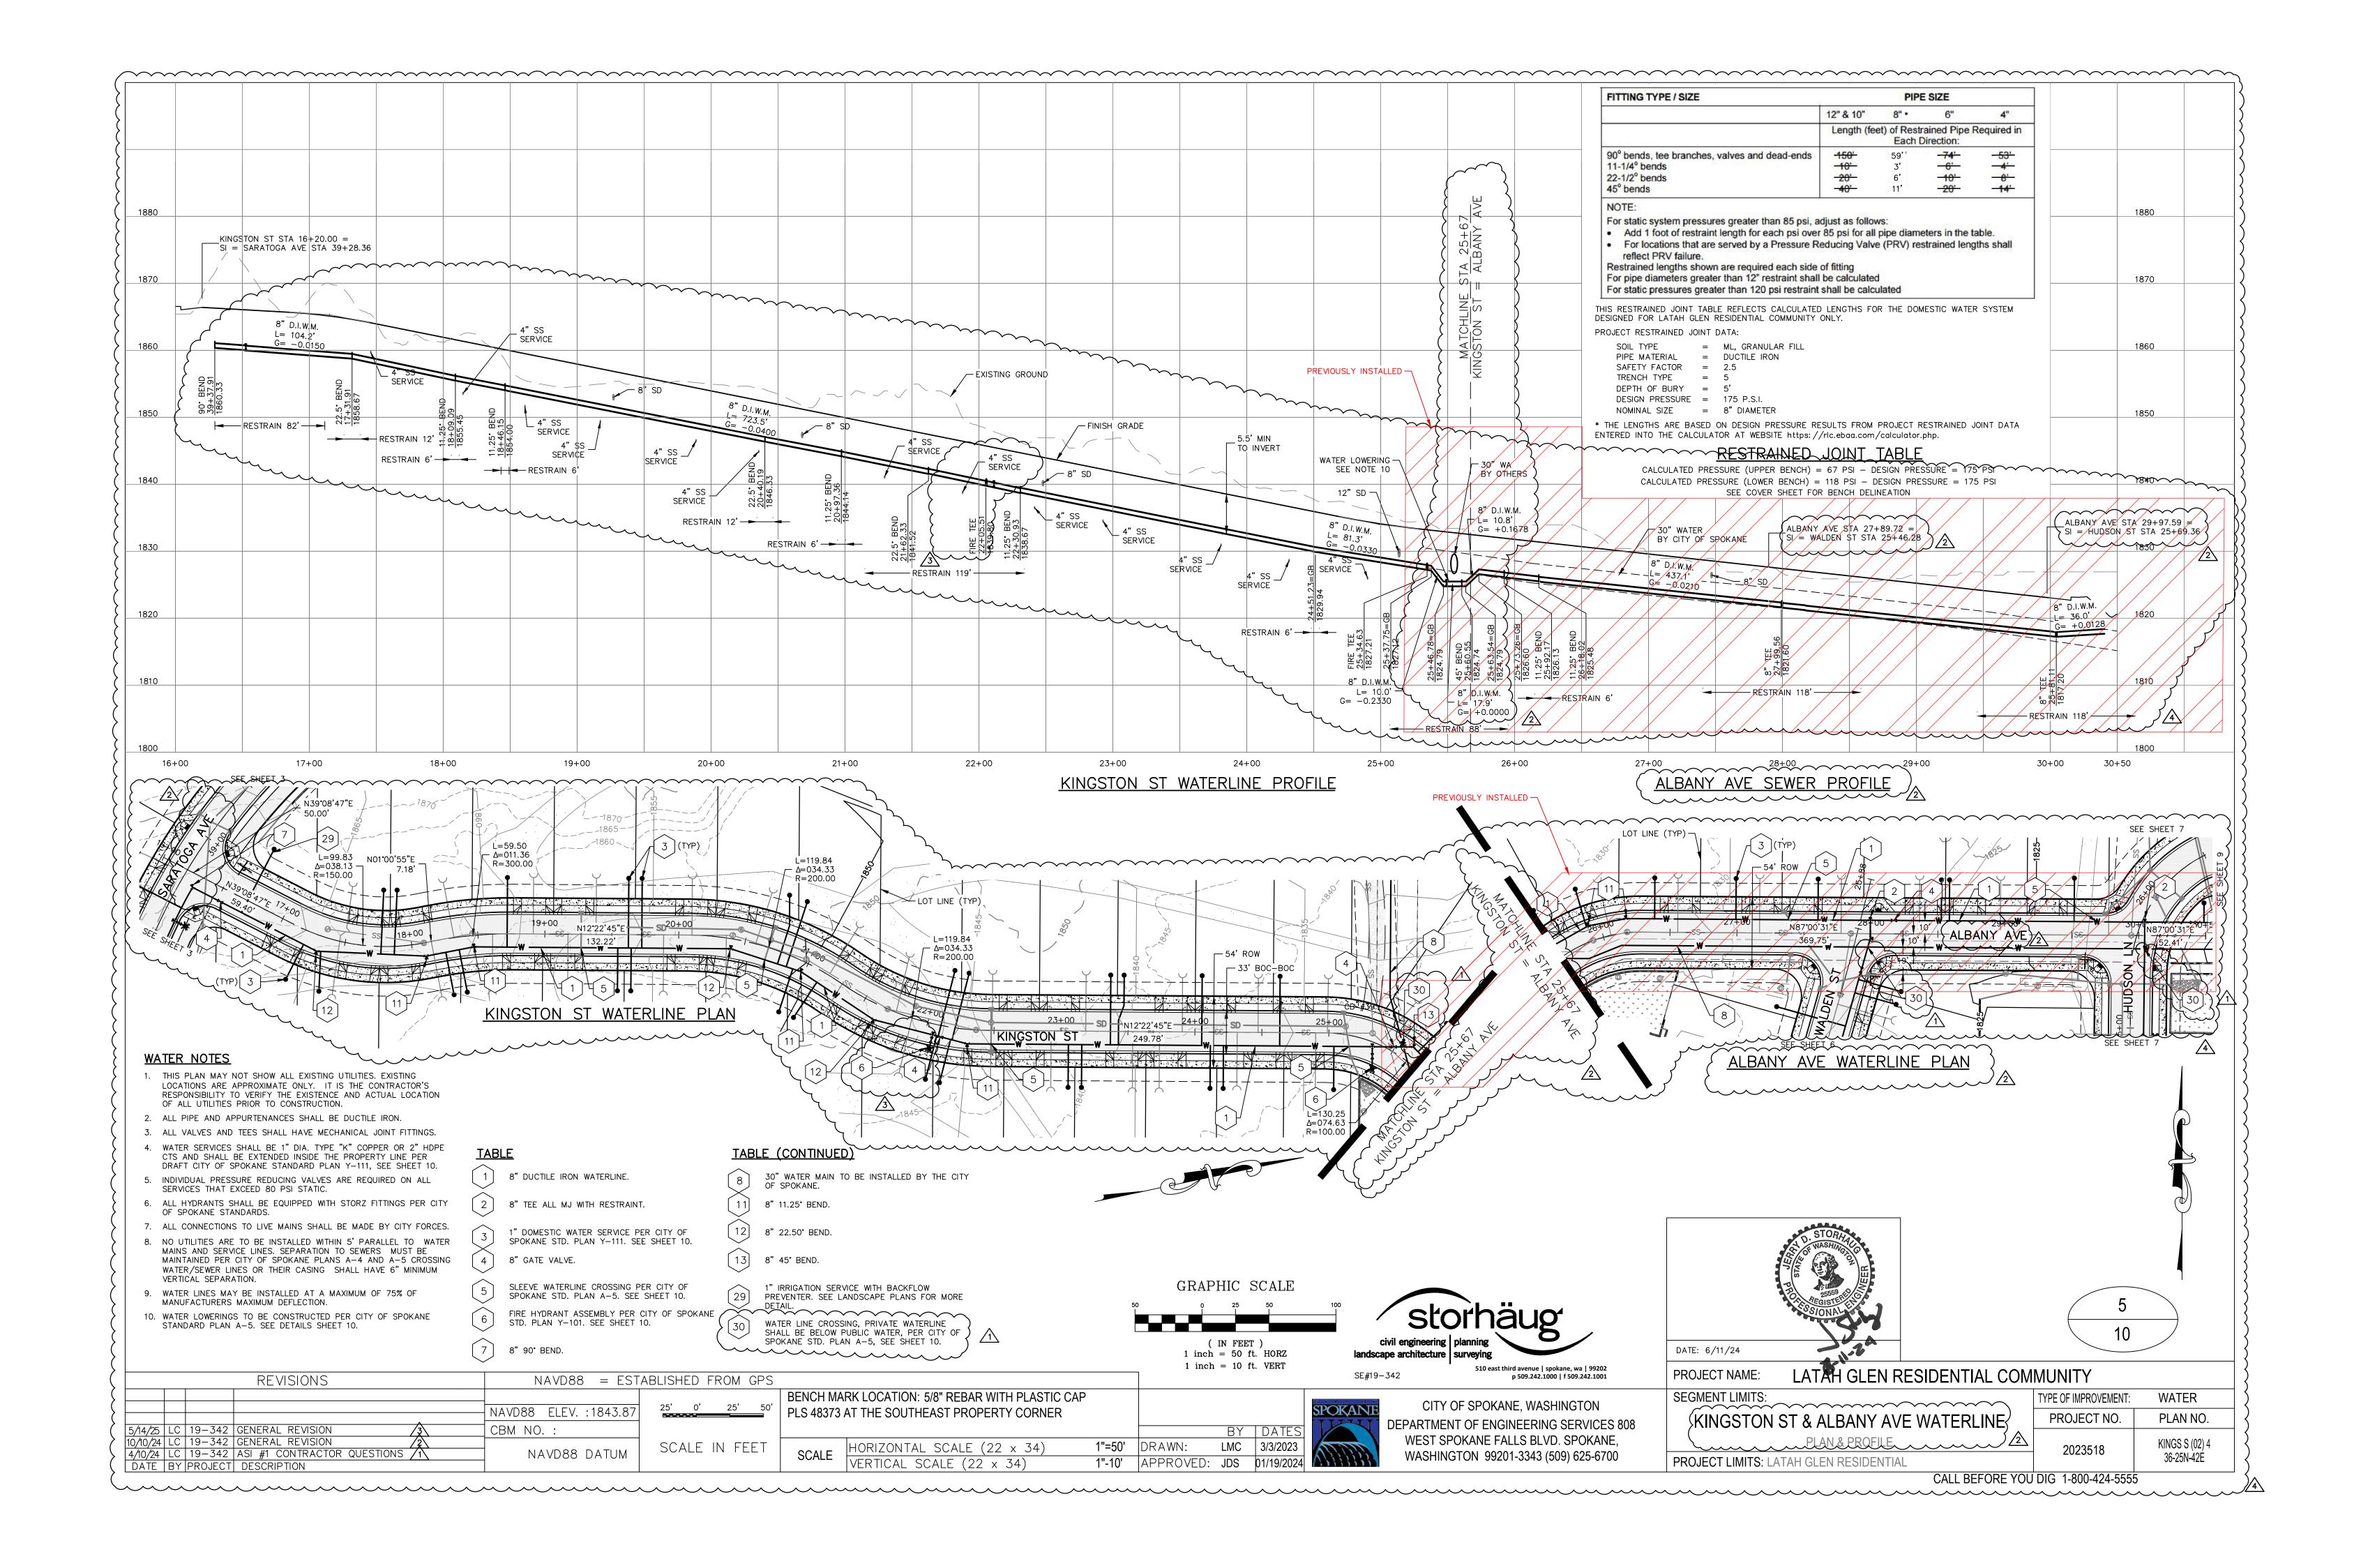


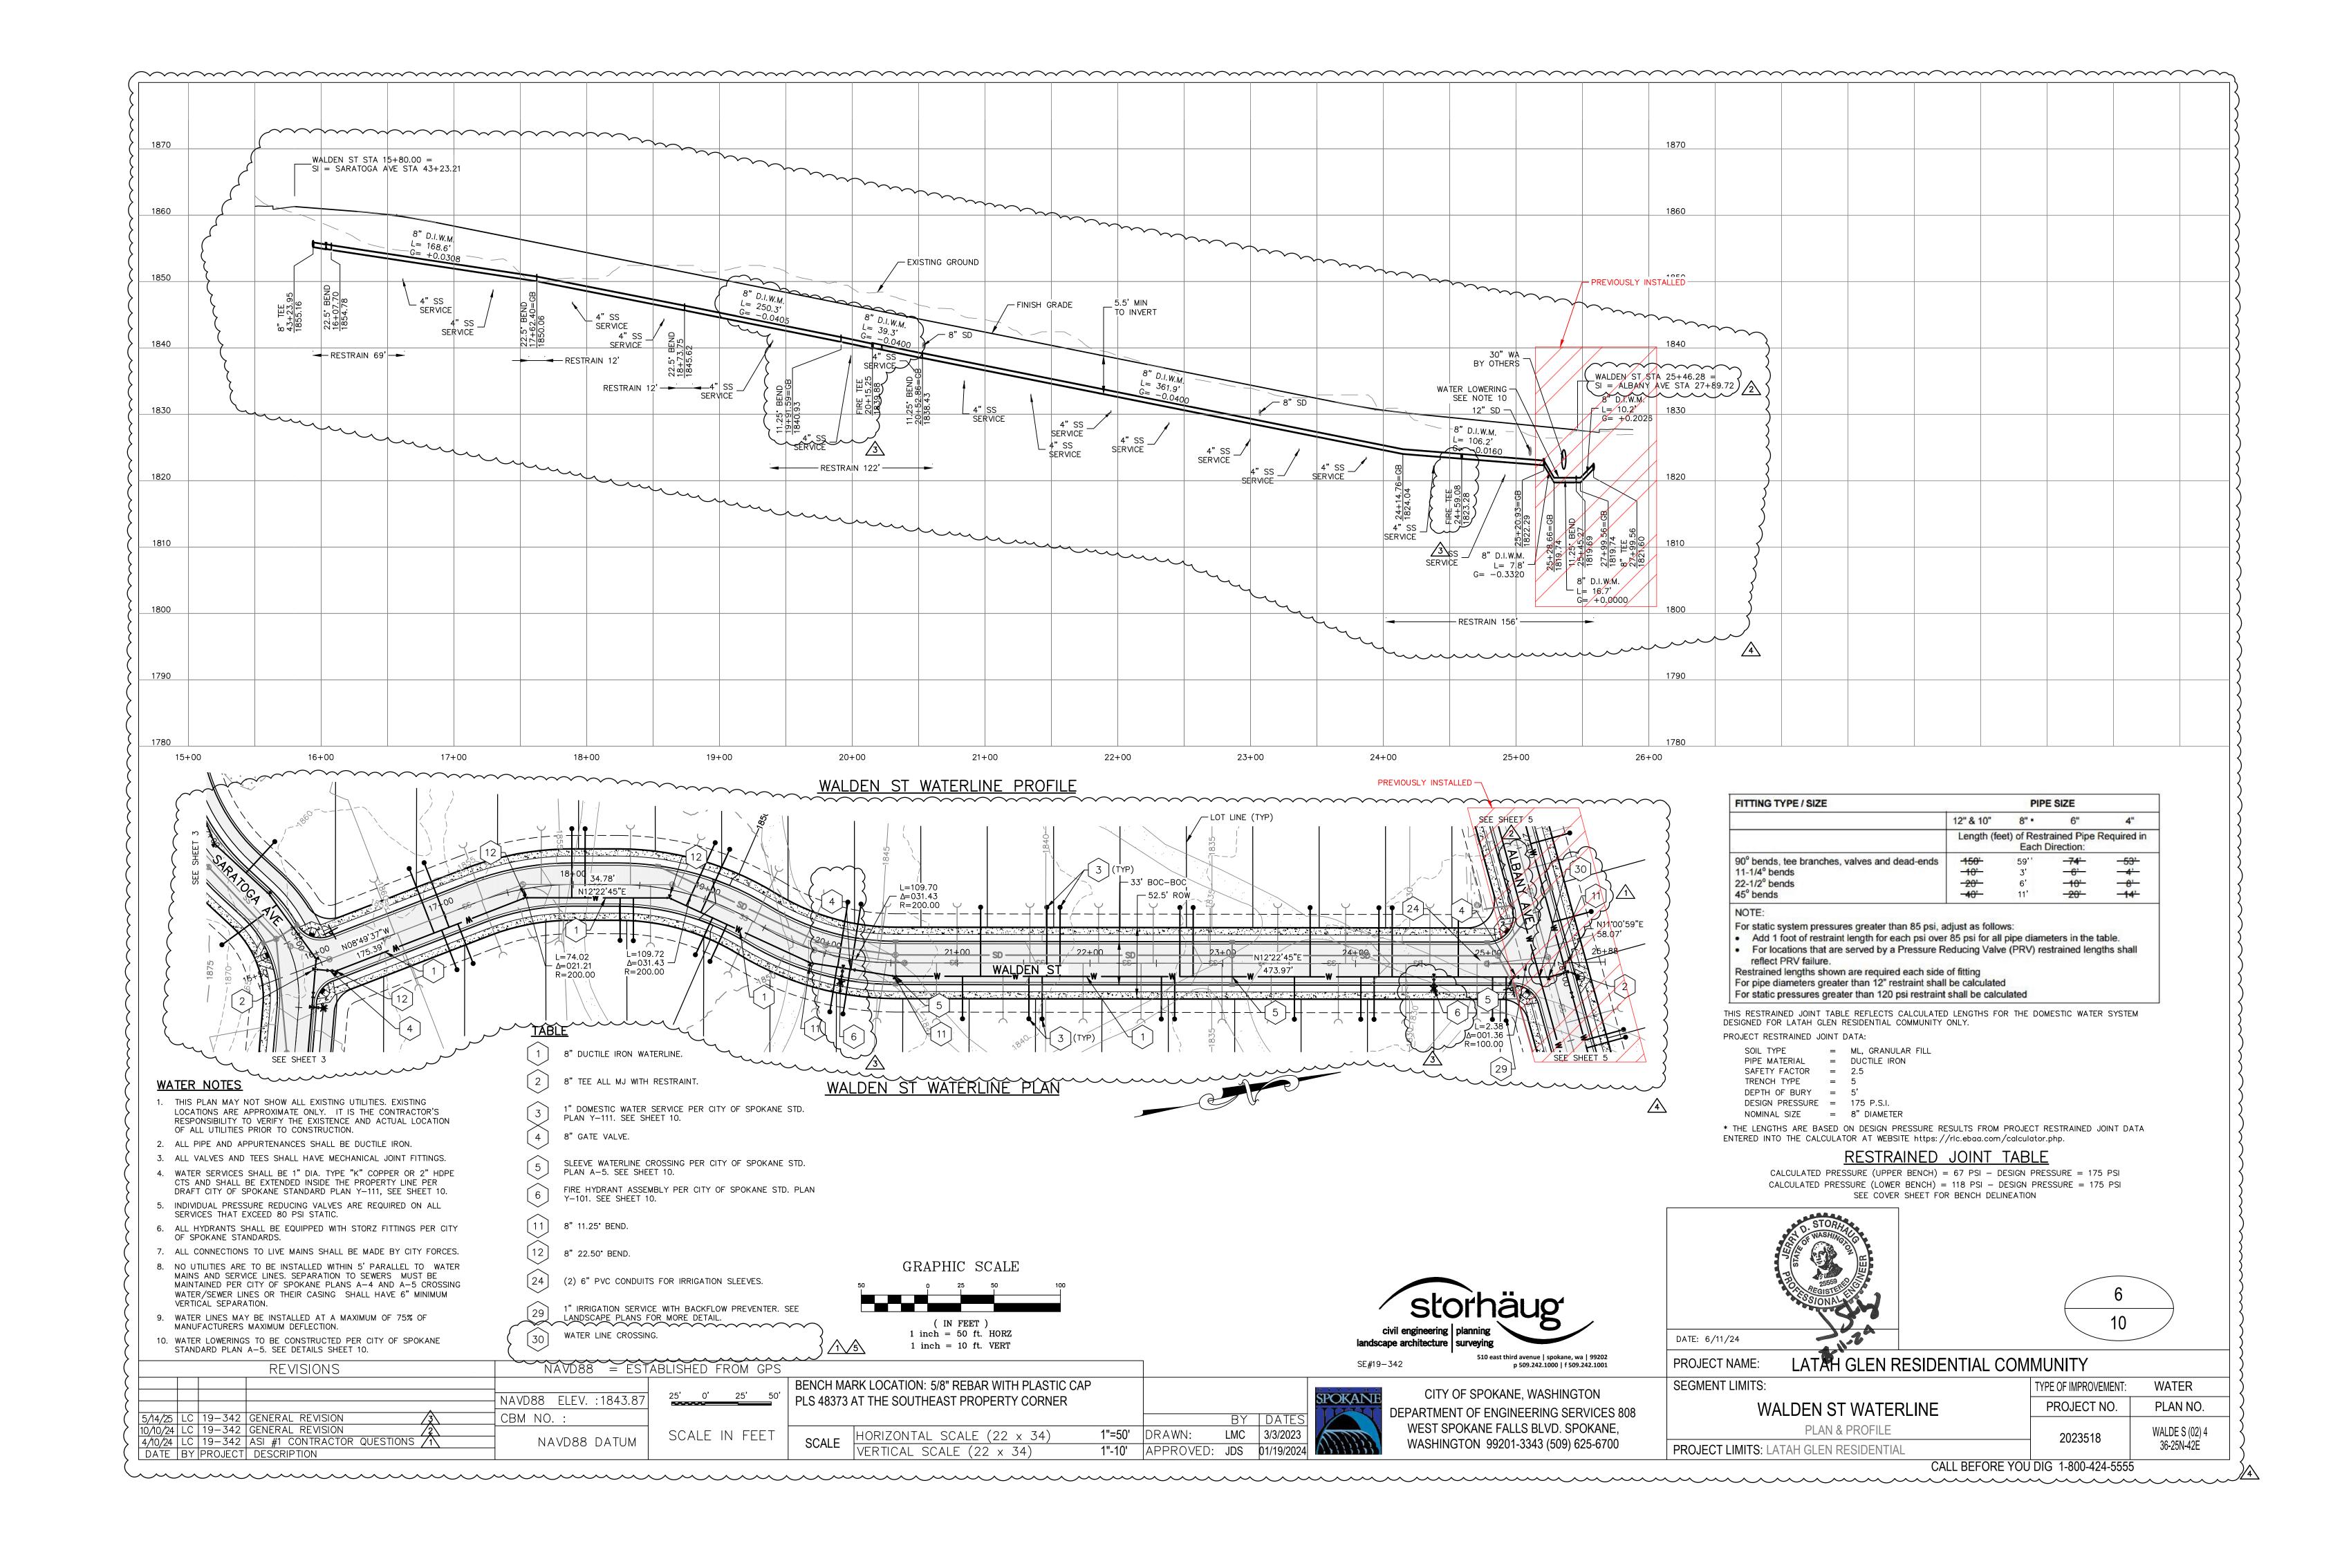


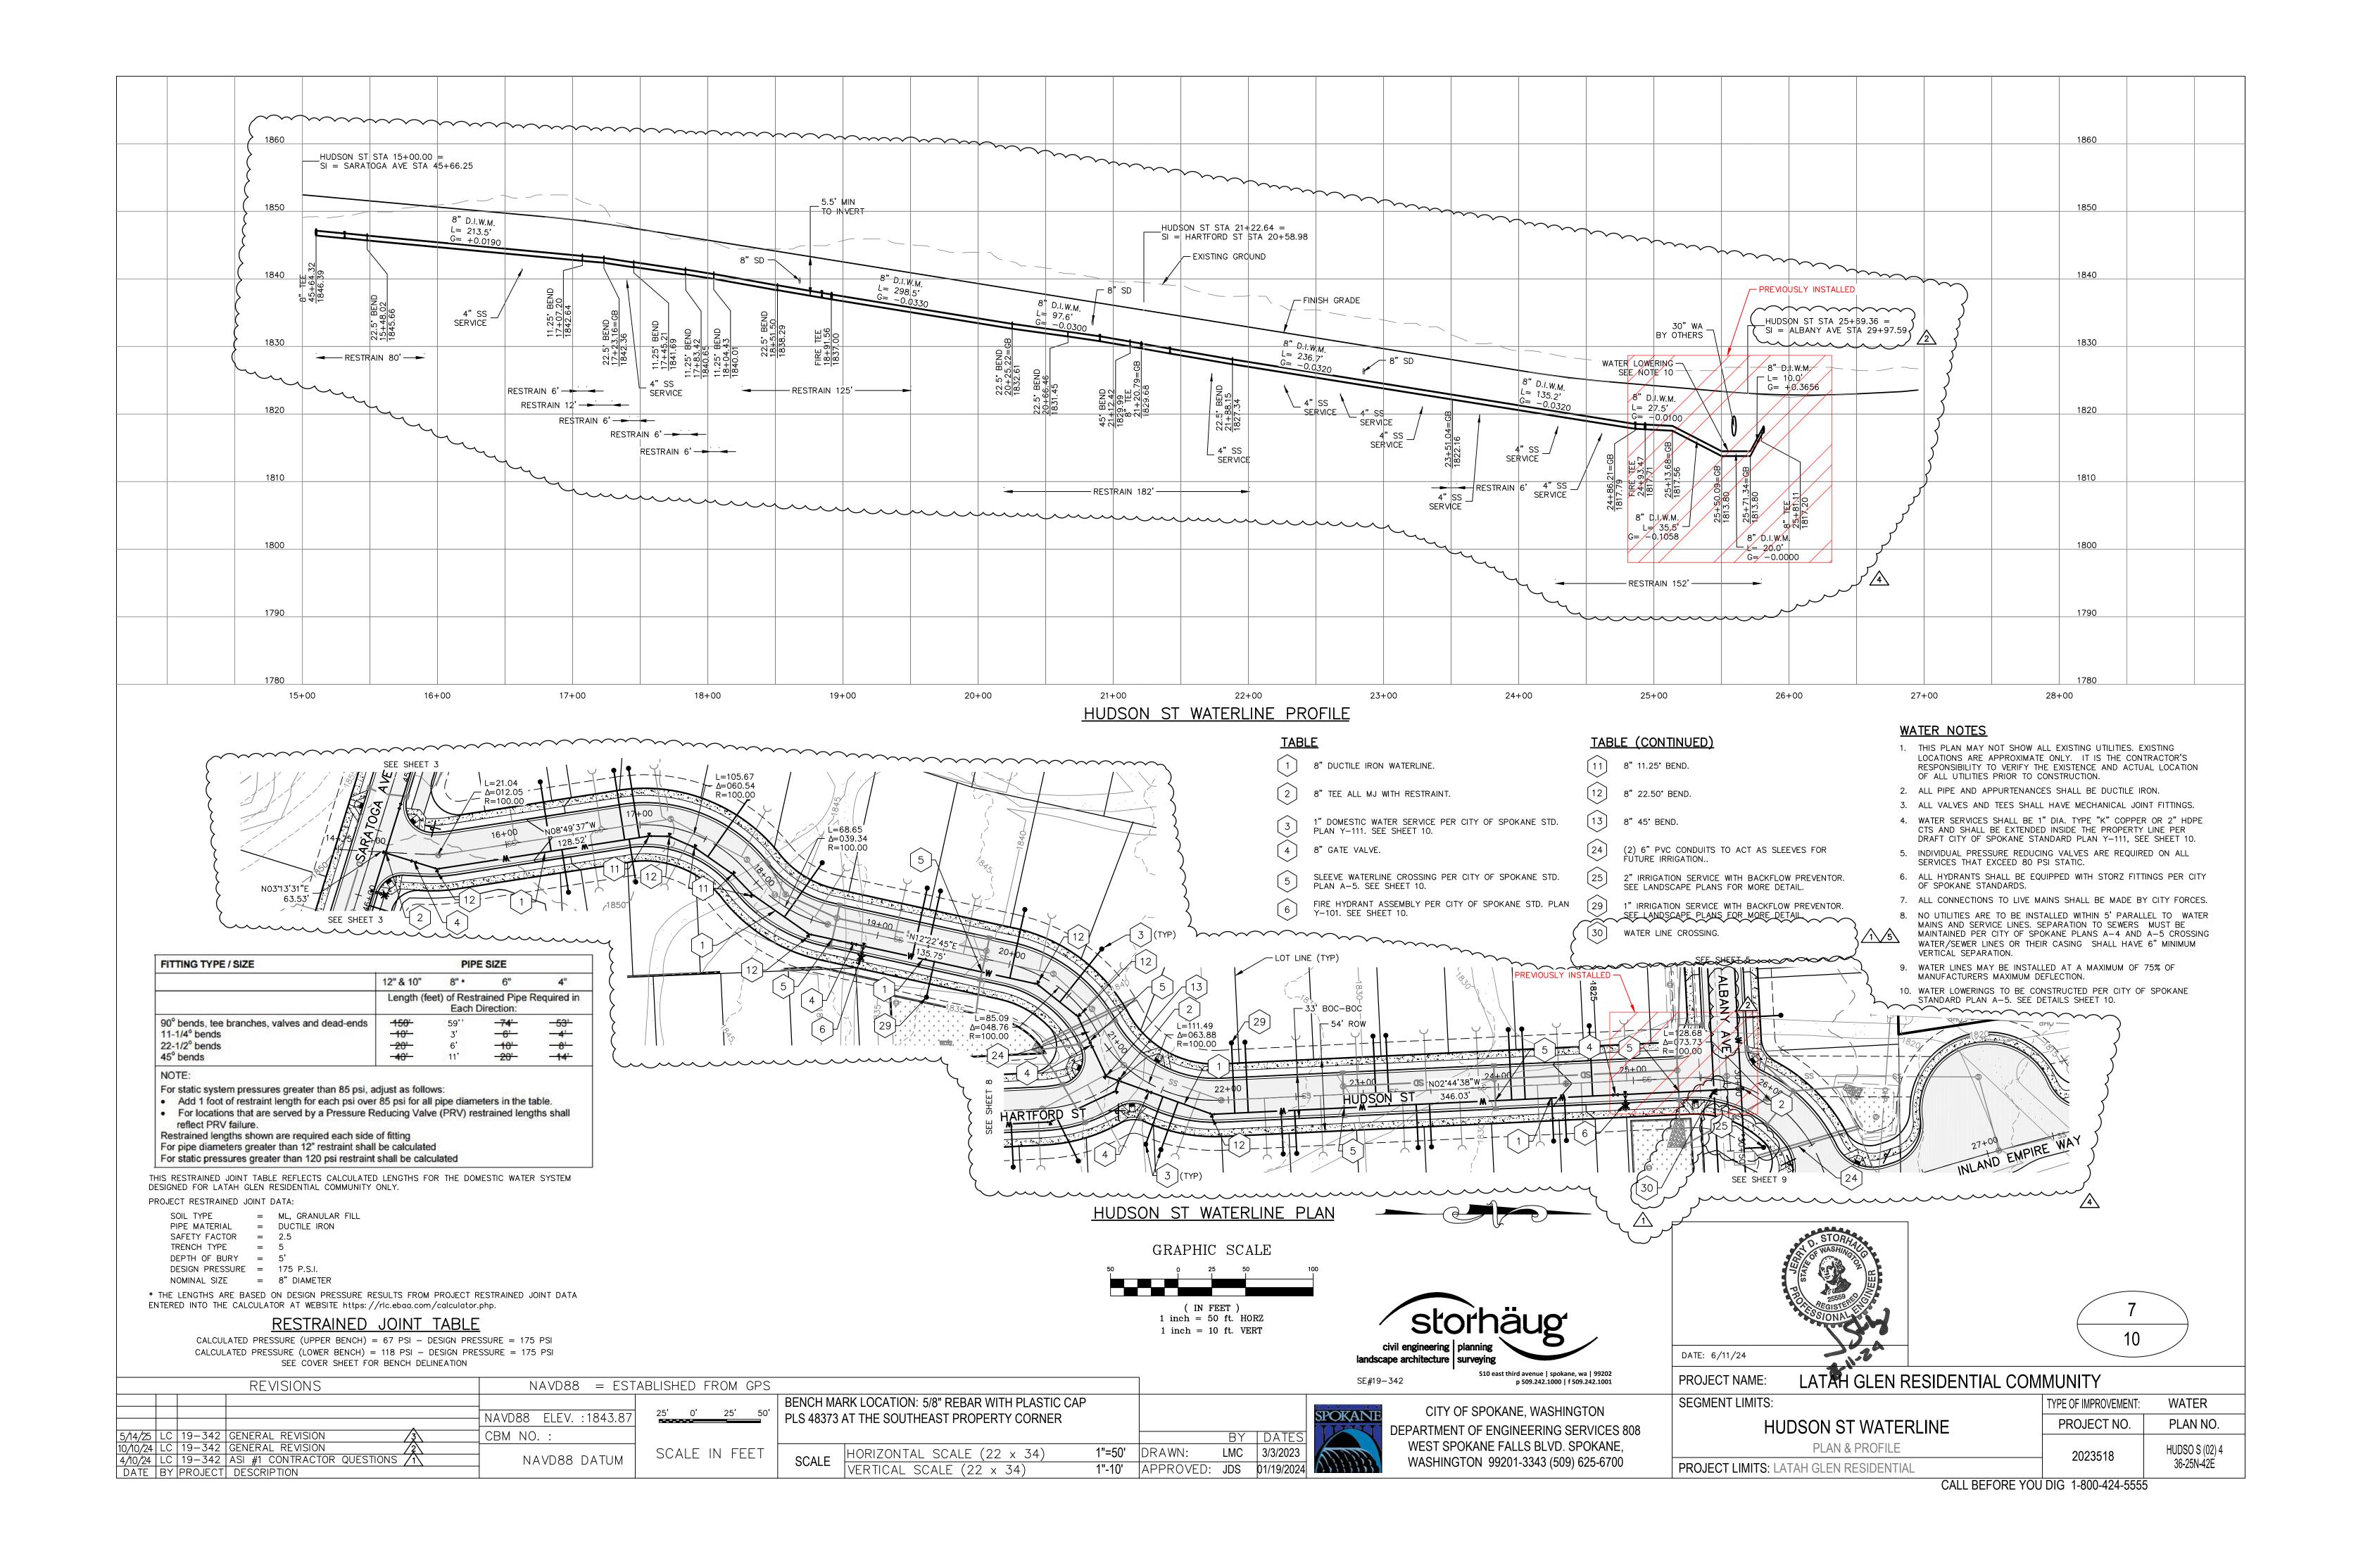


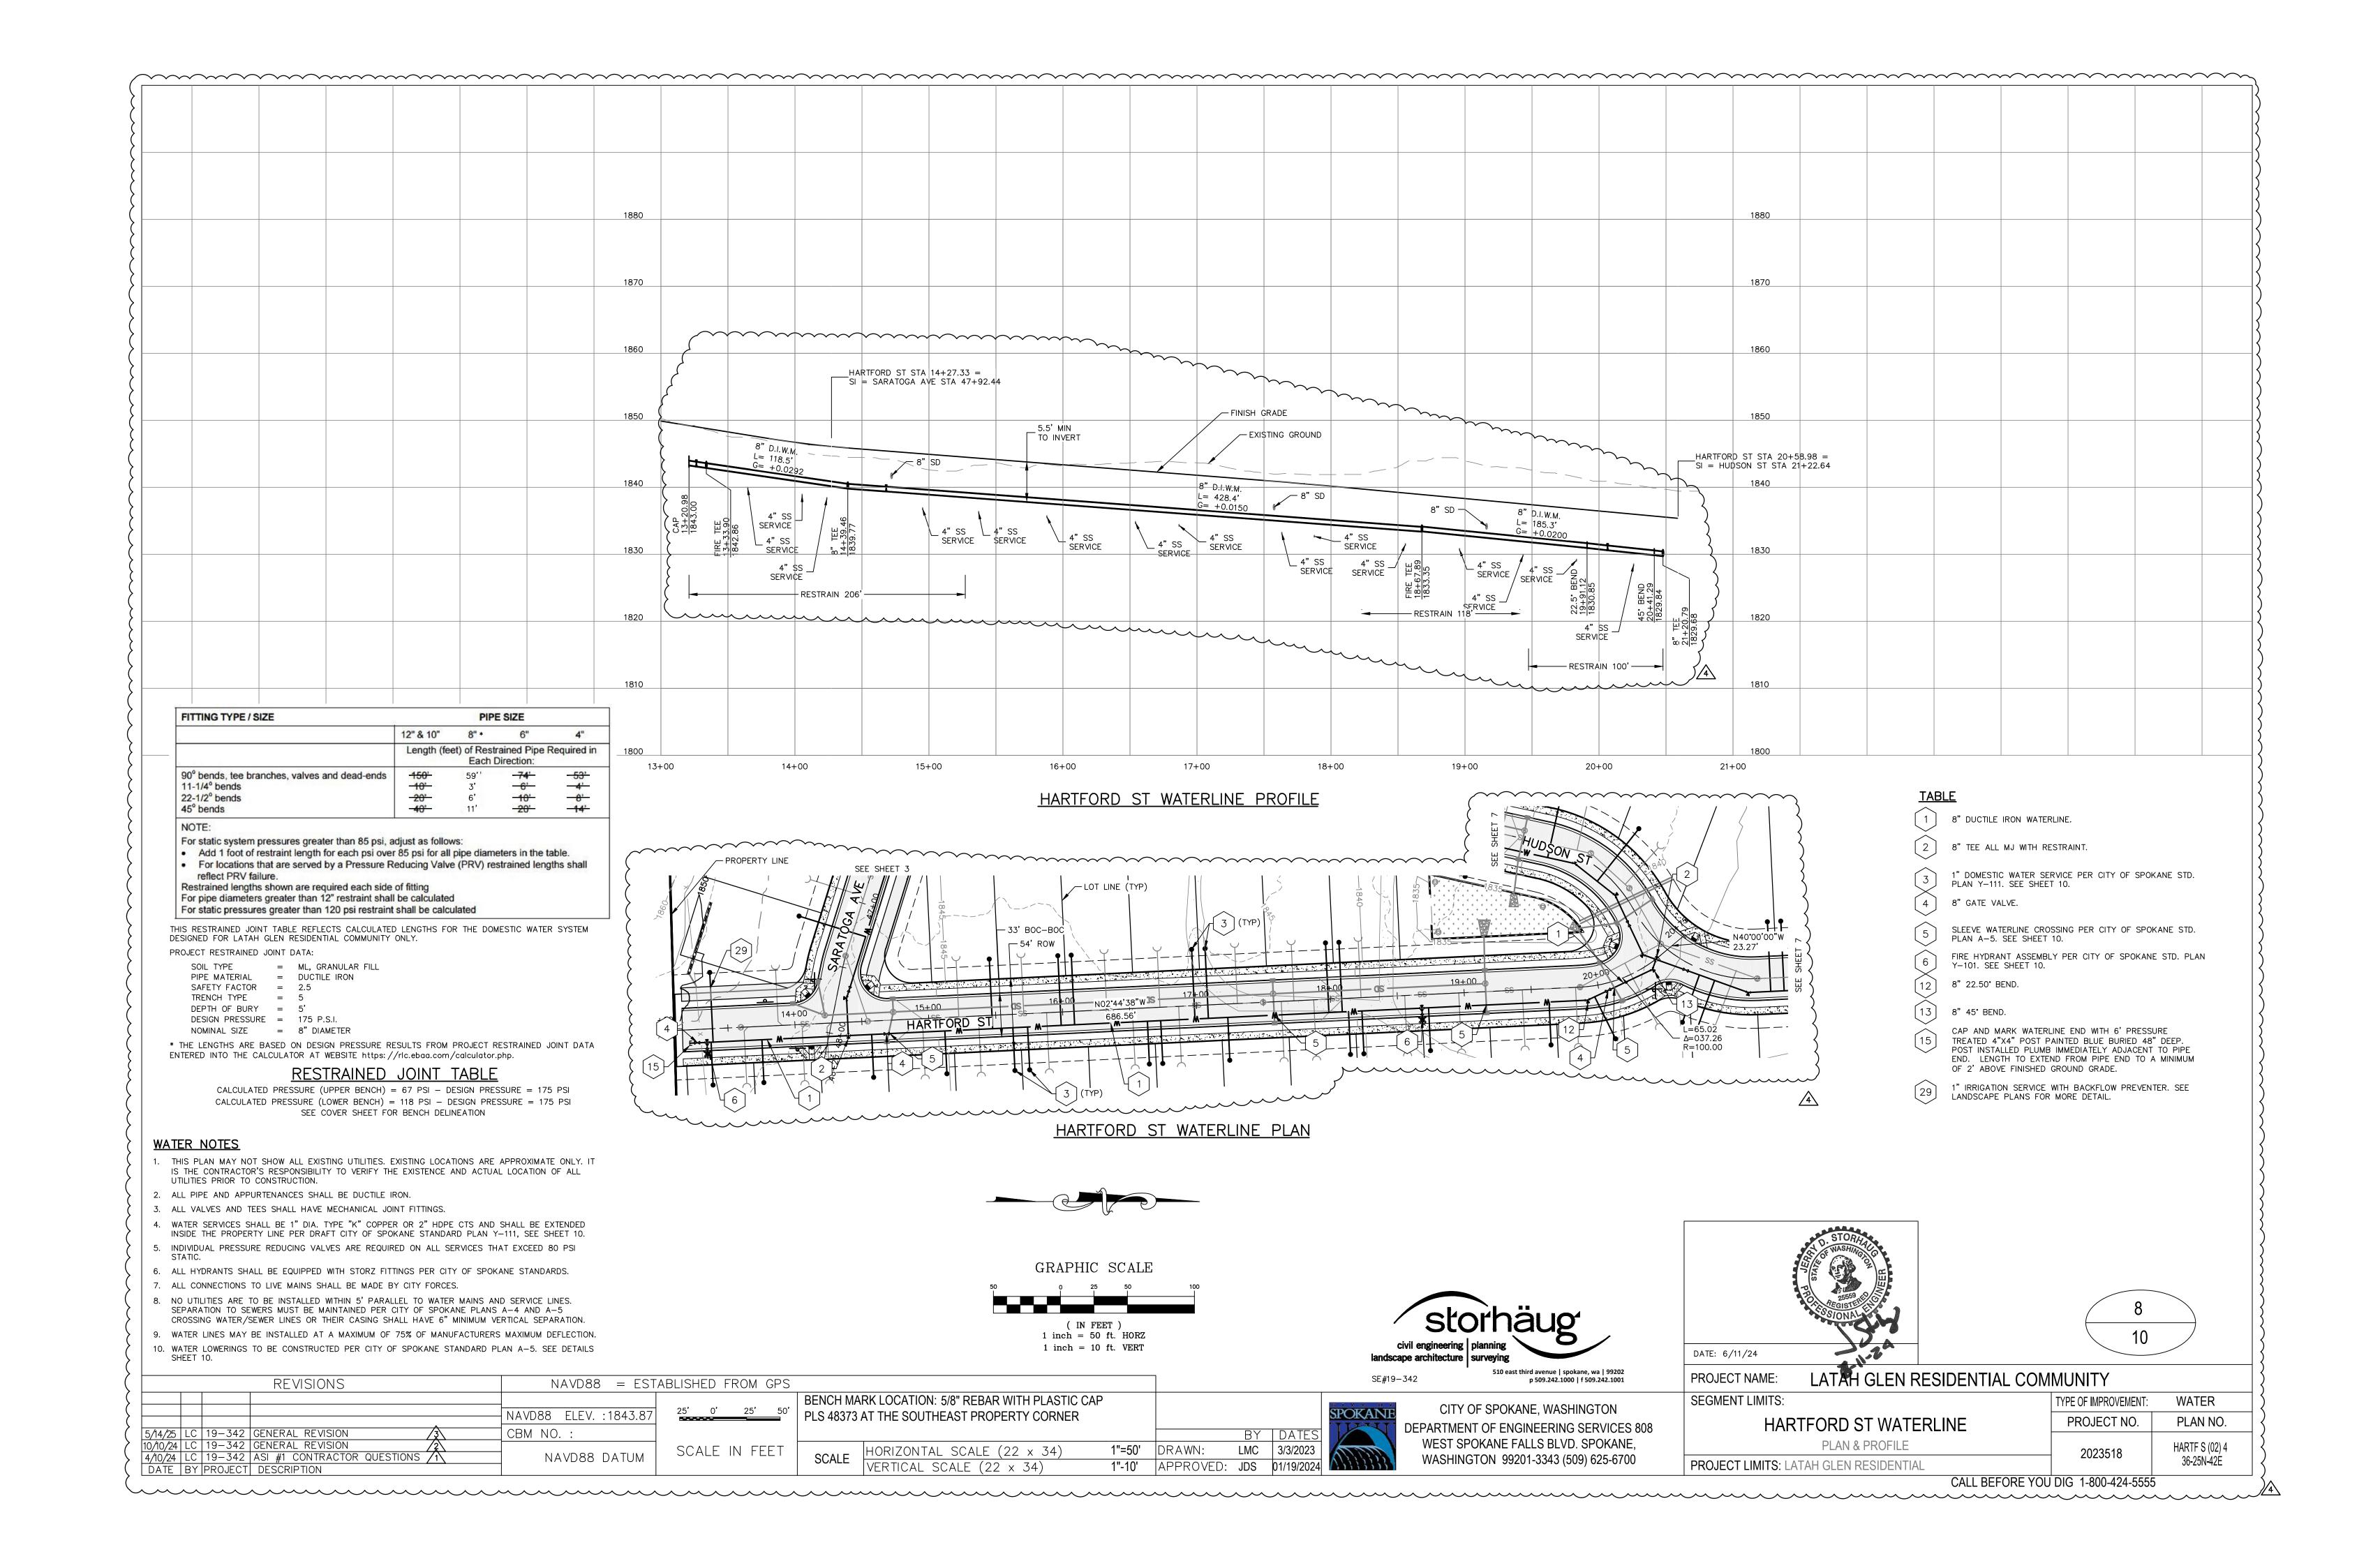


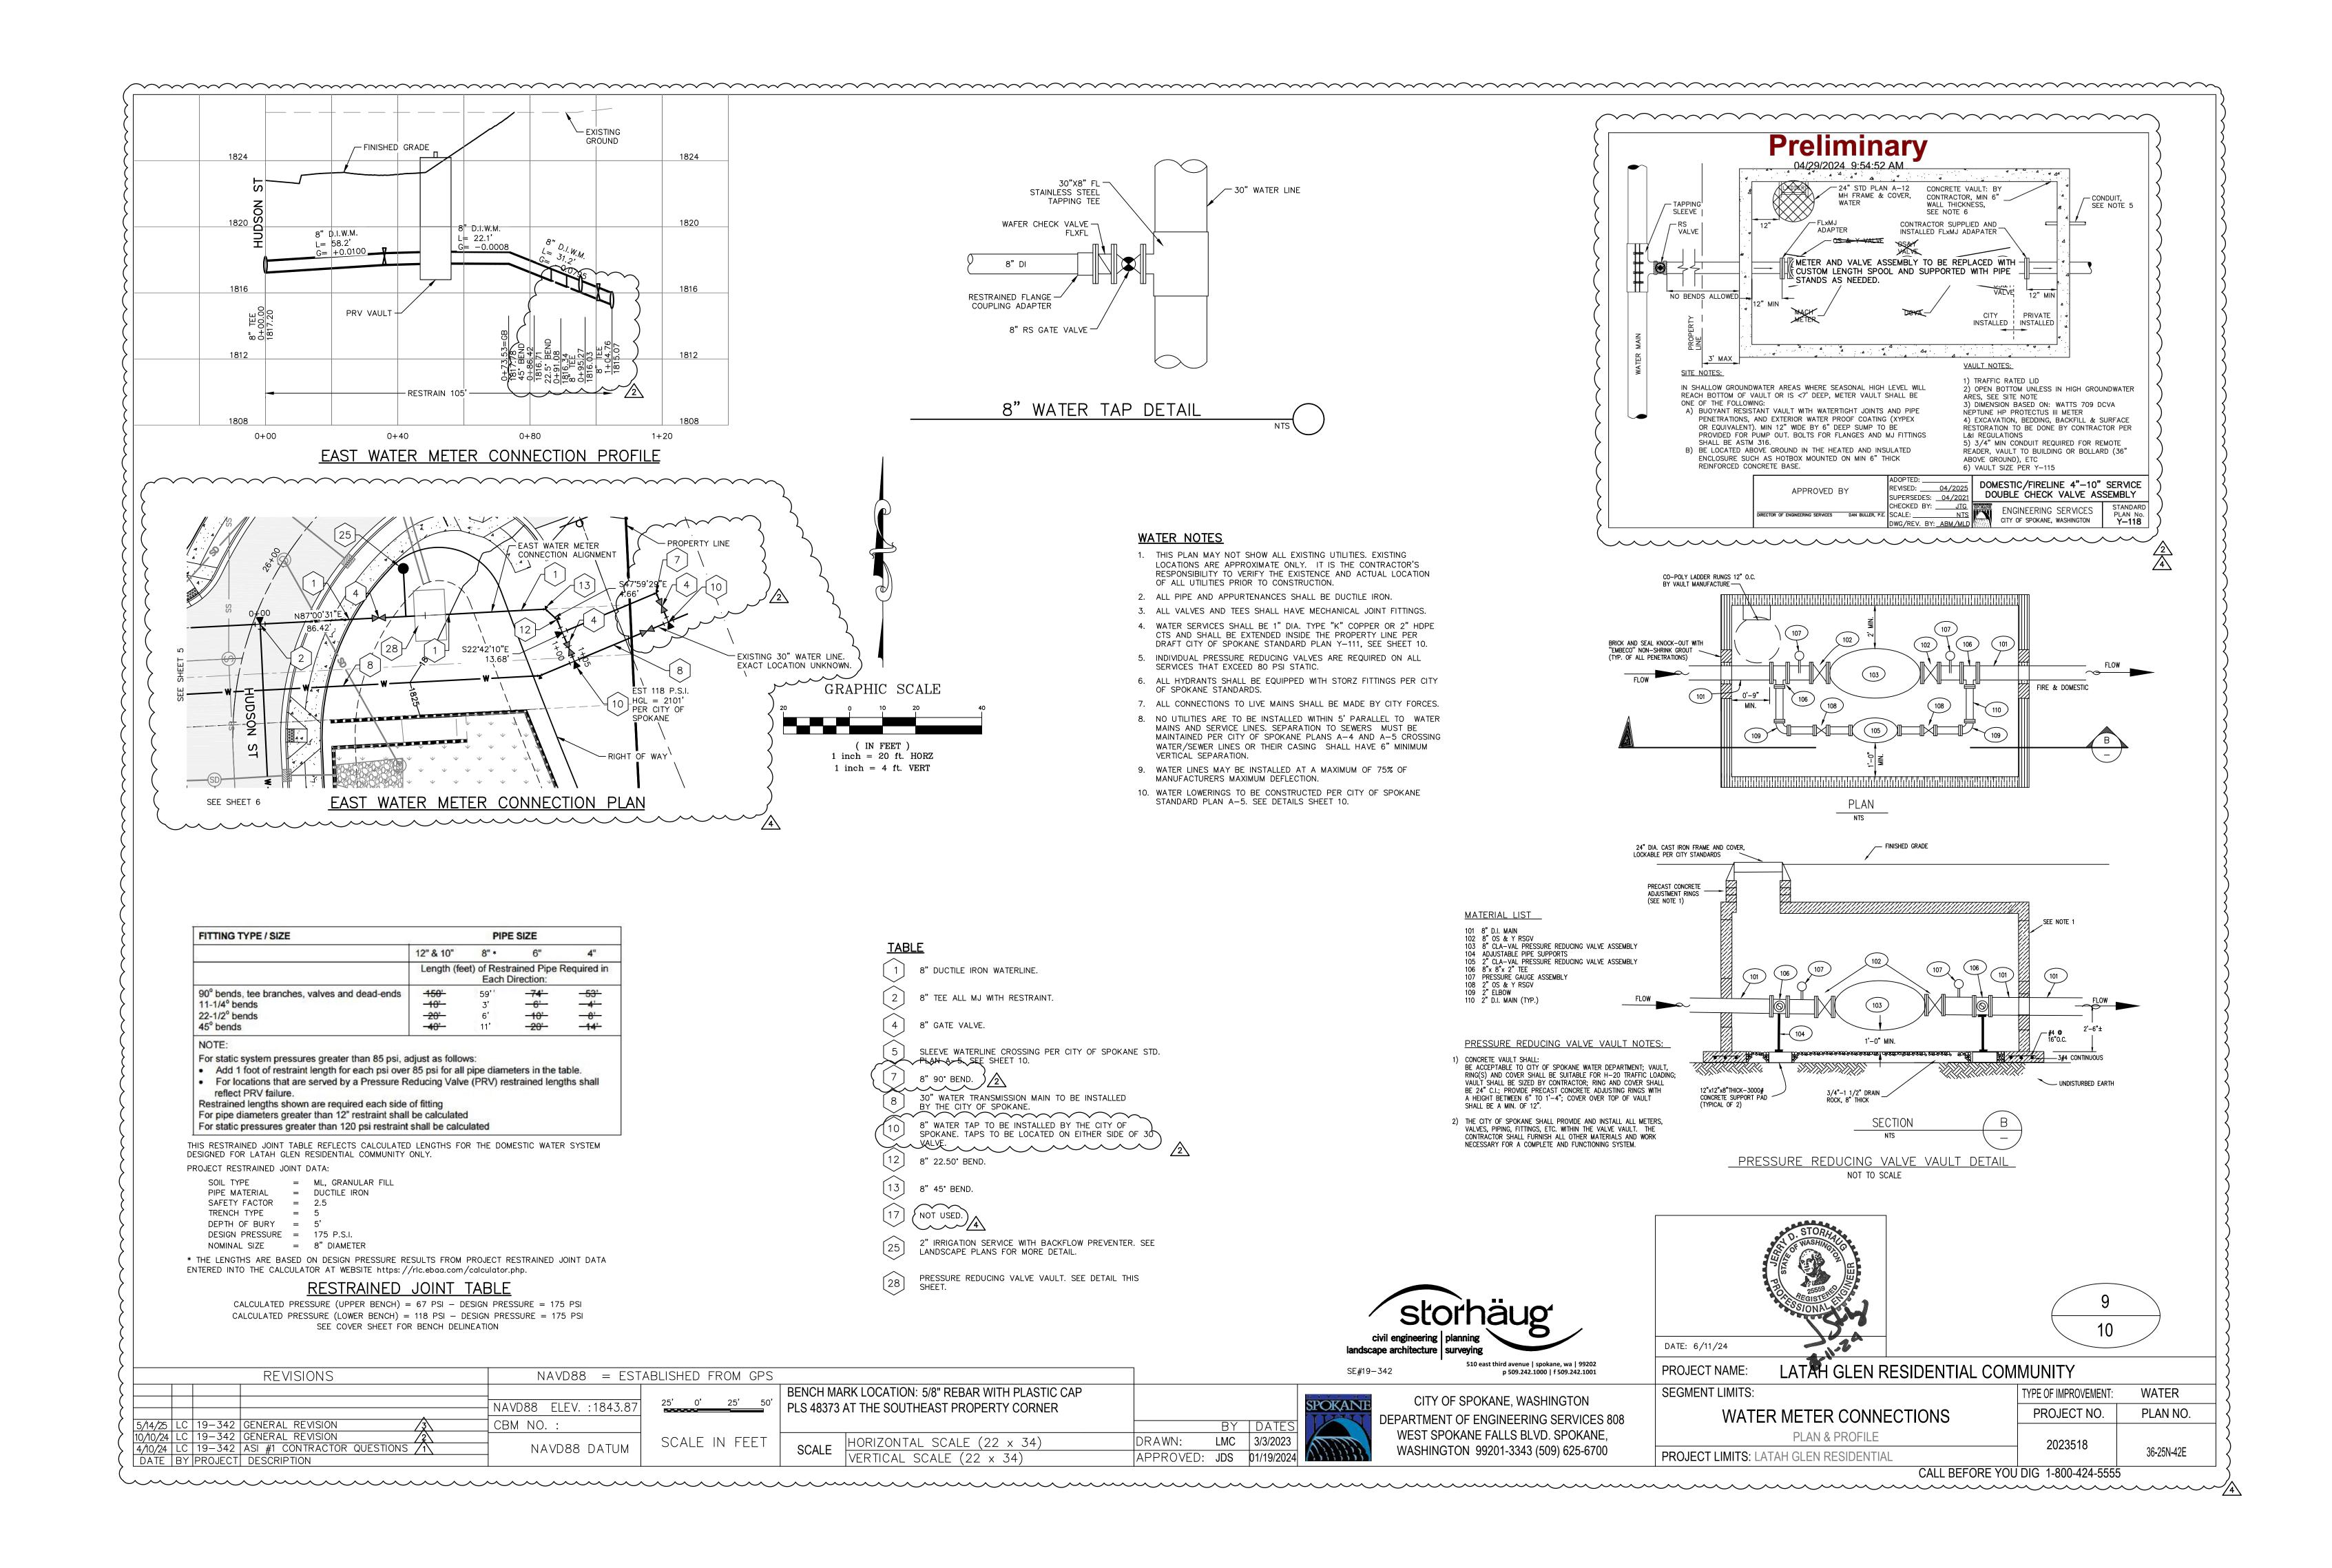

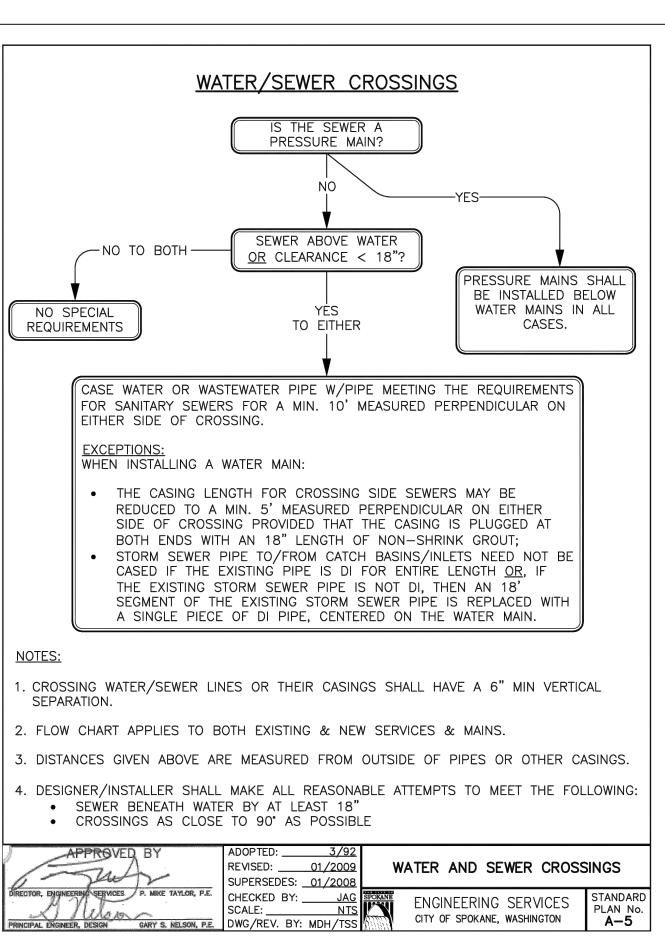

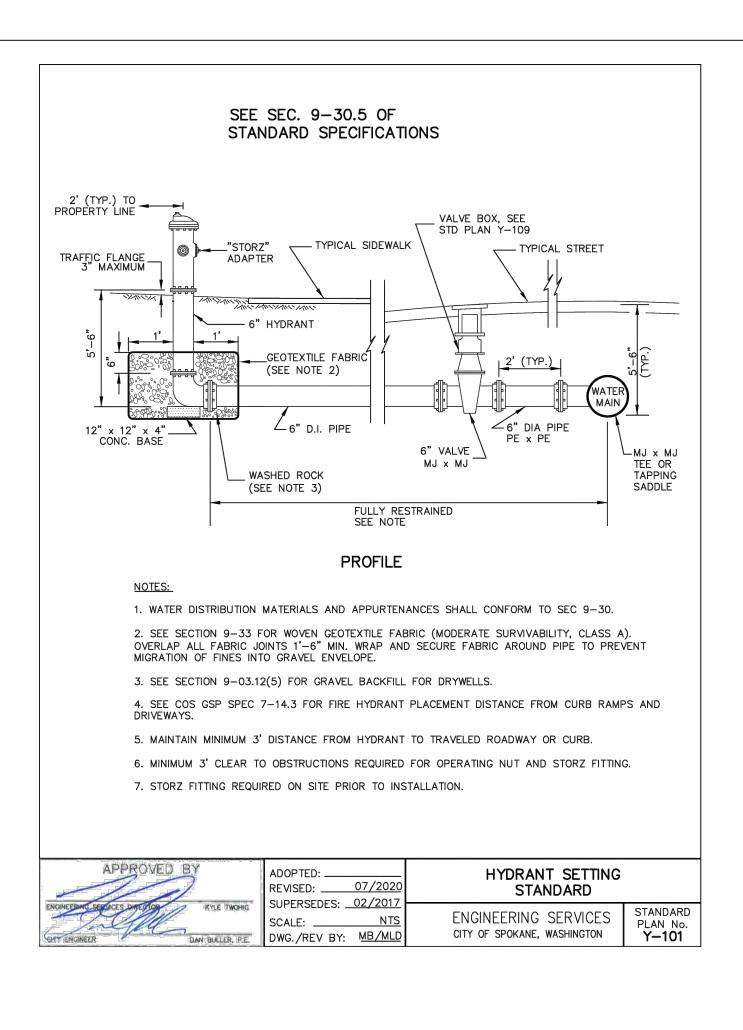

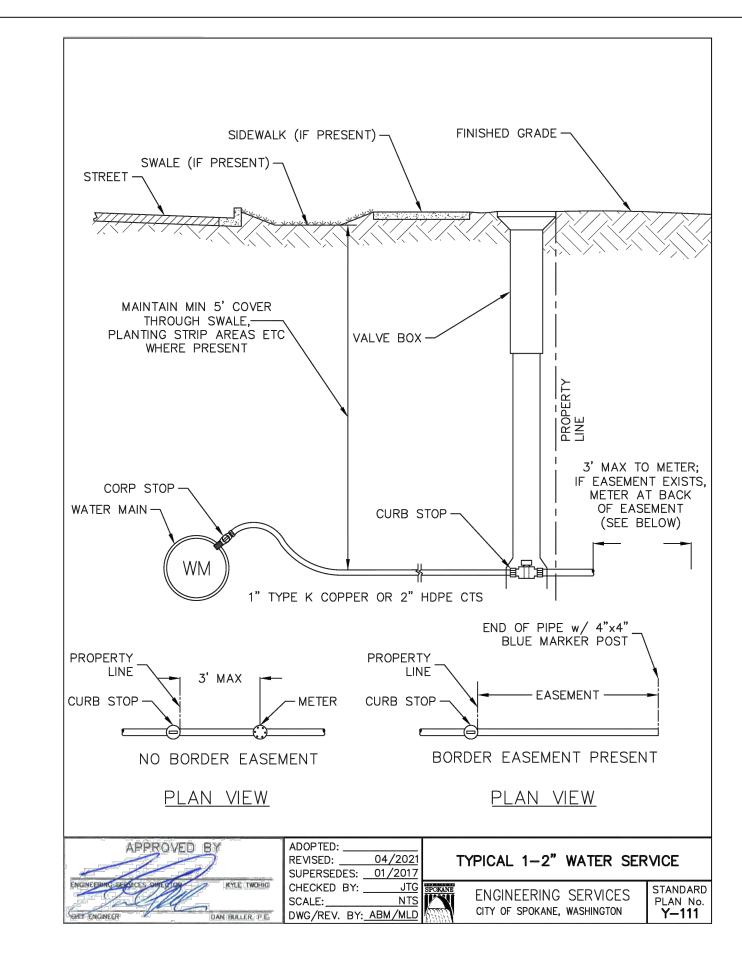

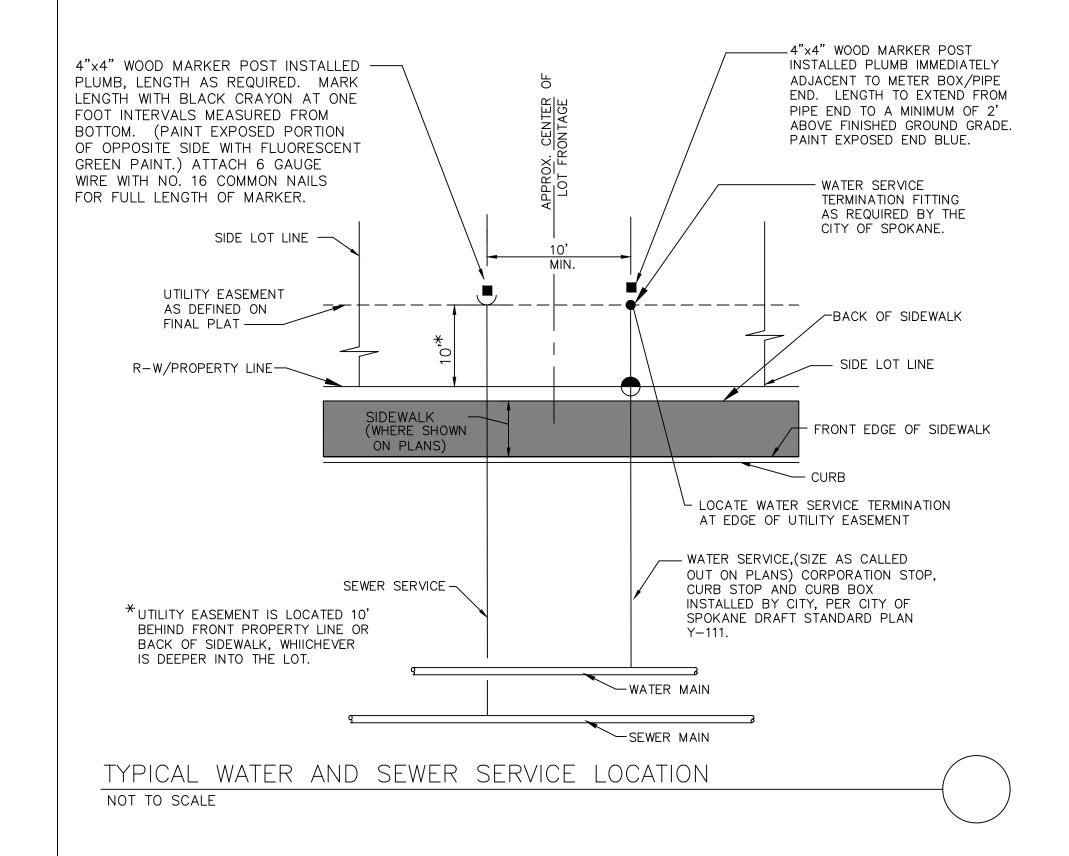



DATE: 6/11/24

PROJECT LIMITS: LATAH GLEN RESIDENTIAL

WATER

PLAN NO.

36-25N-42E

REVISIONS			REVISIONS	NAVD88 = ESTABLISHED FROM				
				NAVD88 ELEV.:1843.87	25' 0' 25' 50'			
5/14/2			GENERAL REVISION 3	CBM NO. :				
10/10/2 4/10/2			GENERAL REVISION /2 ASI #1 CONTRACTOR QUESTIONS /1	NAVD88 DATUM	SCALE IN FEET			
DATE	E BY	PROJECT	DESCRIPTION					

OM GF3						
25' 50'	_	RK LOCATION: 5/8" REBAR WITH PLASTIC CAI AT THE SOUTHEAST PROPERTY CORNER	D			
					BY	DATES
FEET	SCALE	HORIZONTAL SCALE (22 x 34)	1"=50'	DRAWN:	LMC	3/3/2023
		VERTICAL SCALE (22 x 34)	1"-10'	APPROVED:	JDS	01/19/2024

CITY OF SPOKANE, WASHINGTON WEST SPOKANE FALLS BLVD. SPOKANE, WASHINGTON 99201-3343 (509) 625-6700

DEPARTMENT OF ENGINEERING SERVICES 808

PROJECT NAME: LATAH GLEN RESIDENTIAL COM	LATAH GLEN RESIDENTIAL COMMUNITY					
SEGMENT LIMITS:	TYPE OF IMPROVEMENT:					
DOMESTIC WATER DETAILS	PROJECT NO.					
	2023518					

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