# **NOMNOM ILLINOIS #10 UST REPLACEMENT**

## for **NOMNOM STORES** 1503 E ILLINOIS AVE **SPOKANE**, WA 99207



#### SYMBOLS & GRAPHICS

0	GRIDLINE	
-	REFERENCE/ ELEVATION POINT	
1 Ref	INTERIOR ELEVATIONS	
1 A101	BLDG SECTION	
1 A101	DETAIL SECTION	
$\langle 1 \rangle$	KEYNOTE	
	DEMOLITION KEYNOTE	
	WINDOW TAG	
1	FINISH KEYNOTE	
(101)	DOOR TAG	
	WALL TAG	
	LEVEL HEAD	
Room name 101 150 SF	ROOM TAG	
	REVISION TAG	


	ALUMINUM
	BATT INSULATION
	BRICK CUT
	CONCRETE
	CONCRETE CUT
$\sim$	CMU CUT
<u> </u>	EARTH
	E.I.F.S. IN ELEV
$\square$	FINISH WOOD
	FIRE PROOFING
	GLASS
$\downarrow$	GRASS
, Ç	GRAVEL
	GROUT
	GYPSUM BOARD
	METAL FRAMING
	PLASTIC
	PLYWOOD
	RIGID INSULATION
- / -	SAND
	SPRAY INSULATION
	STEEL GRATE
	WOOD BLOCKING
$\leq$	WOOD FRAME

#### ABBREVIATIONS

ABB	REVIATIONS				
A.B.	ANCHOR BOLT			-	<b></b>
A.F.F.	ABOVE FINISH FLOOR	FND	FOUNDATION	R	RADI
ABV	ABOVE	FRM'G.	FRAMING	RD	ROOF
ACOUS	ACOUSTICAL	FT	FOOT OR FEET	REC	RECC
ALUM	ALUMINUM	FTG	FOOTING	REF	REFE
ARCH	ARCHITECTURAL			REINF	REIN
ASPH	ASPHALT	GA	GAUGE	REQ	REQL
		GALV	GALVANIZED	RM	ROOM
BD	BOARD	GC	GENERAL CONTRACTOR		
BLDG	BUILDING	GL	GLASS	S	SOUT
BLK'G	BLOCKING	GND	GROUND	S & V	STAIN
BM	BEAM	GWB	GYPSUM WALL BOARD	SC	SOLD
BTM	BOTTOM	GYP	GYPSUM	SCHED	SCHE
				SHT	SHEE
CAB	CABINET	HB	HOUSE BIBB	SHT'G	SHEA
СВ	CATCH BASIN	HC	HOLLOW CORE	SIM	SIMIL
CEM	CEMENT	HDCP	HANDICAP	SOG	SLAB
CJ	CONTROL JOINT	HDWD	HARDWOOD	SPEC	SPEC
CLG	CEILING	HDWR	HARDWARE	SQ FT	SQUA
CLR	CLEAR	HM	HOLLOW METAL	SS	STAIN
CO	CLEAN OUT	HORZ	HORIZONTAL	STD	STAN
COL	COLUMN	HR	HOUR	STL	STEE
CONC	CONCRETE	HT	HEIGHT	STOR	STOR
CONN	CONNECTION			STRUCT	STRU
CONT	CONTINUOUS	IBC	INTERNATIONAL BUILDING	SUSP	SUSP
CT	CERAMIC TILE		CODE	SVC	SERV
CTR	CENTER	INST	INSTALLATION		
•	022.	INSUL	INSULATION	Т	TEMP
DBL	DOUBLE	INT	INTERIOR	T & G	TONG
DEPT	DEPARTMENT			TC	TOP (
DIA	DIAMETER	JAN.	JANITOR	THK	THIC
DIM	DIMENSION			TOP	TOP (
DN	DOWN	LAM	LAMINATE	TP	TOP (
DR	DOOR	LAV	LAVATORY	TRD	THRE
DS	DOWNSPOUT	LOC	LOCATION	TRTD	TREA
DTL	DETAIL			TW	TOP (
DWG	DRAWING	MATL	MATERIAL	TYP	TYPIC
-		MAX	MAXIMUM		
Е	EAST	MECH	MECHANICAL	UNFIN	UNFI
EA	EACH	MFGR	MANUFACTURER	UON	UNLE
EIFS	EXT. INSULATION FINISH	MH	MANHOLE		
	SYSTEM	MIN	MINIMUM	VERT.	VERT
EJ	EXPANSION JOINT	MISC	MISCELLANEOUS	VEST.	VEST
EL	ELEVATION	MTD	MOUNTED	VTR	VENT
ELEC	ELECTRICAL	MTL	METAL		
ELEV	ELEVATOR			W	WEST
ENCL	ENCLOSURE	N	NORTH	W/	WITH
EQ	EQUAL	NIC	NOT IN CONTRACT	W/O	WITH
EQUIP	EQUIPMENT	NO	NUMBER	WD	WOO
EXIST	EXISTING	NTS	NOT TO SCALE	WDW	WIND
EXPO	EXPOSED			WP	WATE
EXT	EXTERIOR	OC	ON CENTER	WR	WATE
		OFCI		WSCT	WAIN
FD	FLOOR DRAIN	0501		WT	WEIG
FE	FIRE EXTINGUISHER	OFOI	OWNER FURNISHED OWNER INSTALLED		
FH	FIRE HYDRANT	OPP	OPPOSITE		
FIN	FINISH	UI F	OF COTE		
FLR	FLOOR	PL	PLATE		
FLSH'G	FLASHING	PLAM	PLATE PLASTIC LAMINATE		
FLUOR	FLUORESCENT		PLASTIC LAWINATE		

	PROJECT TE	AM
ADIUS OR RISER DOF DRAIN ECOMMENDED EFERENCE EINFORCE, REINFORCED EQUIRED DOM	OWNER:	NOMNOM 3808 N SULLIVAN RD BLDG #15, STE 106 SPOKANE VALLEY, WA 99216 DON TAGGART (509) 960-6217 DTAGGART@PARPACIFIC.COM
JTH IN AND VARNISH D CORE IEDULE ET EATHING	ARCHITECT:	WOLFE ARCHITECTURAL GROUP 1015 N CALISPEL, STE B SPOKANE, WA 99201 MCKAYLA HOLLIDAY (509) 455-6999
R DN GRADE FICATION RE FOOT LESS STEEL DARD AGE CTURAL	SURVEY::	WHIPPLE CONSULTING ENGINEERS 21 SOUTH PINES ROAD SPOKANE VALLEY, WA 99206 RYAN ANDRADE (509) 893-2617 RANDRADE@WHIPPLECE.COM
DED SD & GROOVE URB LATE AVEMENT /ALL ED DTHERWISE NOTED RU ROOF ESISTANT T	FUEL SYSTEMS:	PACIFIC ENVIRONMENTAL SERVICES COMPANY 13022 W 18TH AVE AIRWAY HEIGHTS, WA 99001 MANNY CHAVEZ (509) 934-7785 MCHAVEZ@PACENVIRO.NET

#### VICINITY MAP

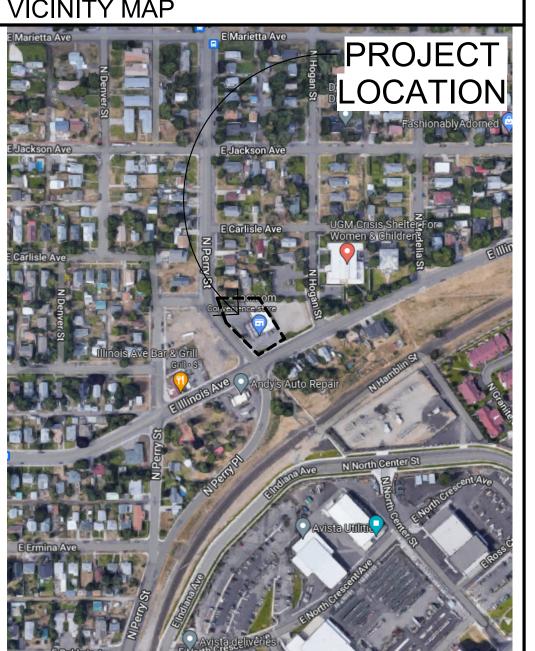

#### PROJECT INFORMATION

**PROJECT DESCRIPTION:** REPLACEMENT OF UNDERGROUND FUEL STORAGE TANKS FOR A GAS STATION. INCLUDES REMOVAL OF EXISTING TANKS, INSTALLTION OF NEW TANKS, RELEVANT CIVIL WORK FOR DEMO AND NECESSARY IMPROVEMENTS, AND RELEVANT ELECTRICAL WORK FOR NEW CONNECTIONS.

REPLACEMENT OF EXISTING FUEL PUMPS. INCLUDES REMOVAL OF EXISTING FUEL PUMPS AND CONCRETE ISLANDS, INSTALLATION OF NEW FUEL PUMPS AND CONCRETE ISLANDS, RELEVANT CIVIL WORK FOR DEMO AND NECESSARY IMPROVEMENTS, AND RELEVANT ELECTRICAL WORK FOR NEW CONNECTIONS.

UPDATES TO EXISTING ADA PARKING AND STRIPING TO BE COMPLIANT WITH CURRENT CITY STANDARDS.

ZONING INFORMATION: PARCEL NO .:

PARCEL AREA: ZONING:

35093.0416 0.85 ACRES NR-35 (NEIGHBORHOOD RETAIL)

#### **GENERAL NOTES**

- ALL CONSTRUCTION SHALL COMPLY WITH APPLICABLE STATE & LOCAL CODES
- DIMENSIONS ARE FACE OF STUD, OR GRID LINE AT NEW CONSTRUCTION AND FACE OF EXISTING
- FINISH AT EXISTING CONSTRUCTION, U.O.N. IT IS THE CONTRACTOR'S RESPONSIBILITY TO INSPECT THE JOB SITE TO FAMILIARIZE HER/HIMSELF WITH ALL THE EXISTING CONDITIONS THAT COULD AFFECT THE INSTALLATION OF
- THE JOB SITE AT THE COMPLETION OF CONSTRUCTION SHALL BE CLEAR OF ANY DEBRIS OR SPOIL RESULTING FROM THE CONSTRUCTION. AT NO TIME SHALL THIS MATERIAL OBSTRUCT THE NORMAL OPERATION OF THE OWNER
- ALL TERMINATIONS OF ONE FLOOR MATERIAL TO ANOTHER SHALL HAVE TRANSITION OR REDUCER STRIPS MADE FOR FLOORING TYPE
- THE CONTRACTOR SHALL BE RESPONSIBLE FOR VERIFYING THE EXISTENCE AND LOCATION OF ANY UNDERGROUND OR CONCEALED UTILITY LINES THAT MAY BE REQUIRED OR AVOIDED DURING CONSTRUCTION
- REFER TO CODE ANALYSIS AND CODE COMPLIANCE PLANS FOR FIRE RATED ASSEMBLIES EXITING & EGRESS ALL ROUGH OPENINGS ARE LOCATED 4" NEAREST ADJACENT WALL, U.O.N.
- ALL PENETRATIONS THROUGH FIRE RESISTIVE FLOORS OR WALLS SHALL BE PROTECTED B' MATERIALS AND INSTALLED TO CONFORM TO THE U.L. LISTING.
- U.O.N., ALL BLOCKING OR BACKING MATERIAL SHALL BE PLWD OR 2X FOR ALL WALL MOUNTED ITEMS REFER TO INTERIOR SHEETS FOR AL
- TREATMENT DETAILS.
- THE CONTRACTOR IS ADVISED THAT DAMAGE TO ANY PORTION OF THIS PROJECT'S BUILDING AS A RESULT OF THIS PROJECT, IS TO BE REPAIRED AT THE CONTRACTOR'S EXPENSE
- DO NOT SCALE DRAWINGS. WRITTEN DIMENSIONS SHALL PREVAIL . CONTRACTOR SHALL OBTAIN ALL PERMITS REQUIRED PRIOR TO ANY PHASE OF CONSTRUCTION.
- FEES AND ANY RELATED COSTS ARE THE RESPONSIBILITY OF THE CONTRACTOR. ALL DOOR OPENINGS SHALL HAVE 12" CLEAR ON THE PUSH SIDE & 18" CLEAR ON THE PULL SIDE


#### INDEX OF DRAWINGS

**GENERAL** G0.01 COVER SHEET

#### ARCHITECTURAL

- A0.00 SURVEY A0.01 EXISTING CONDITION PHOTOS
- A0.02 DEMOLITION SITE PLAN A0.03 SITE PLAN
- A0.11 SITE DETAILS

### Revisions:

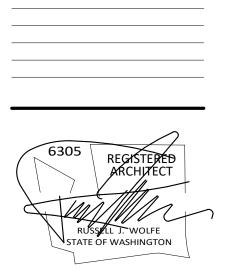

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Project No.:	22.000
Date:	02.28.2023
Drawn By:	MLH
Checked By:	RJW

Sheet No.



#### PERMIT SET 02.28.2023

#### LEGEND WATER FIRE HYDRANT WATER METER H WATER VALVE WATER VALVE MARKER WELL ۲ WATER MANHOLE 0 SEWER SANITARY SEWER MANHOLE SANITARY SEWER CLEANOUT 0 GAS GAS METER GAS MANHOLE KA GAS VALVE IRRIGATION IRRIGATION CATCH BASIN IRRIGATION BOX IRRIGATION VALVE M STORM CATCH BASIN DRAINAGE MANHOLE DRYWELL 00 CATCH BASIN POWER ELECTRIC METER GUY WIRE POWER POLE POWER MANHOLE POWER VAULT POWER TRANSFORMER


#### TELEPHONE/MISC. UTILITIES


0	TE I	POLE	
	TEL	CABLE	RISER

- TEL-JBOX **6**
- TEL MANHOLE 0
- UTILITY MANHOLE
- UTILITY VAULT


#### MISCELLANIOUS

- JUNCTION BOX
- JUNCTION BOX 8 SIGN +
- SIGN 4
- -X STREET LIGHT ASSEMBLY
- LIGHT POLE •
- MAIL BOX -
- ROCK ø RIPRAP -
- 0 SHRUB
- TREE (CONIFER) 议
- $(\cdot)$ TREE (DECIDUOUS)
- /// RUMBLE BARS
- TEST WELL 0
- r WETLAND FLAG
- RR CROSSING SIGNAL
- GATE POST
- BOLLARD •

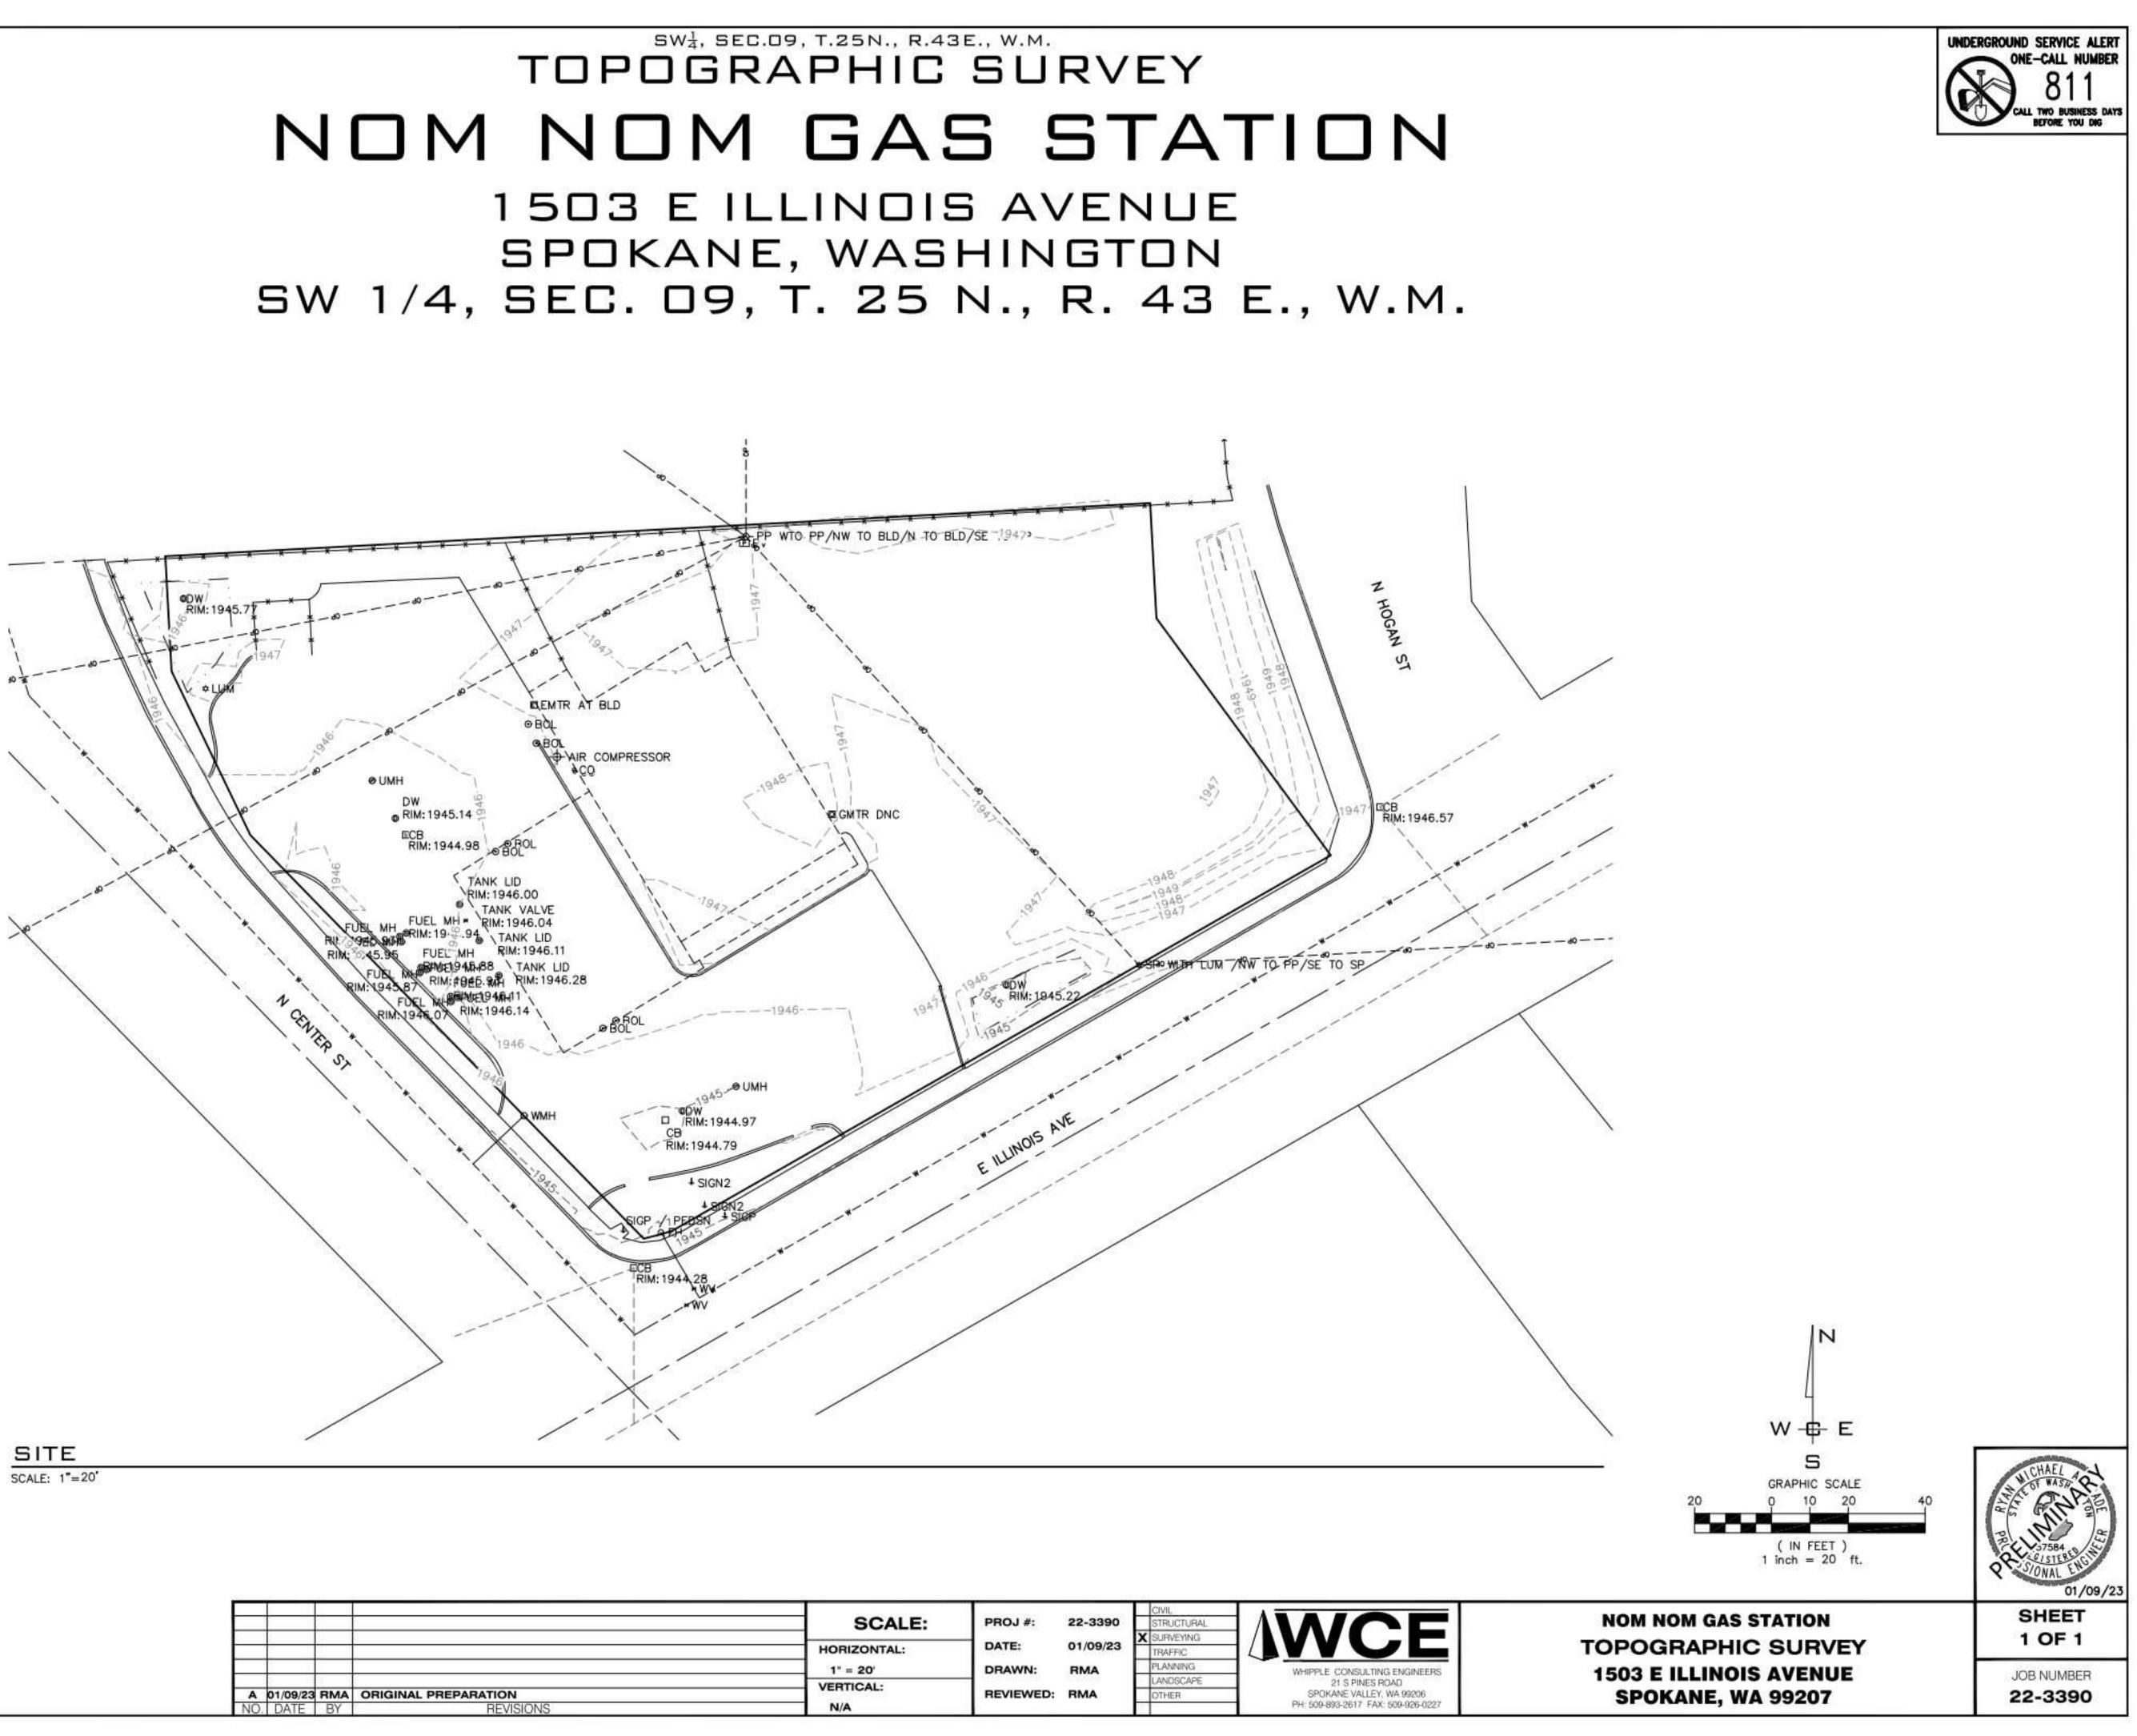

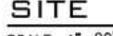

				SCALE:	PROJ #:	22-3390	CIVIL STRUCTURAL	
		i i		HORIZONTAL:	DATE:	01/09/23	X SURVEYING TRAFFIC	
-		1		1" = 20'	DRAWN:	RMA	PLANNING	WHIPPLE CONSULTING E
				VERTICAL:		50000335	LANDSCAPE	21 S PINES ROAI
NO	01/09/23 DATE	BY	ORIGINAL PREPARATION REVISIONS	N/A	REVIEWED:	RMA	OTHER	SPOKANE VALLEY, WA PH: 509-893-2617 FAX: 509

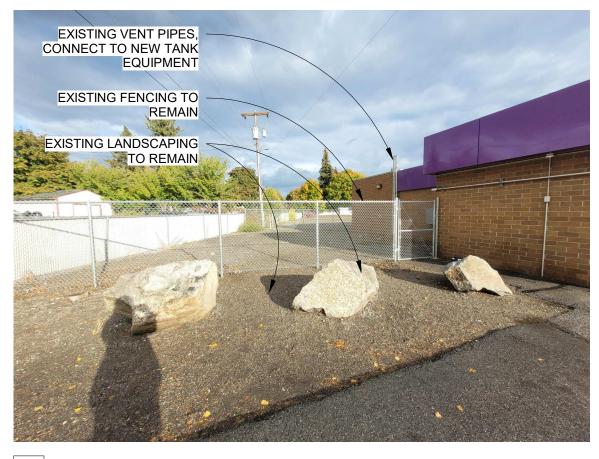

1 EXISTING CONDITIONS



2 EXISTING CONDITIONS



7 EXISTING CONDITIONS



6 EXISTING CONDITIONS

4 EXISTING CONDITIONS



7 EXISTING CONDITIONS

8 EXISTING CONDITIONS



<u>Revisions:</u> 6305 J. WOLFE TATE OF WASHINGTON

## PHOTO( CONDITION EXISTING

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NOMNOM ILLINOIS #10 UST REPLACEMENT 1503 E ILLINOIS AVE SPOKANE, WA 99207 NOMNOM STORES



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A0.01



Revisions:

#### **GENERAL NOTES**

- ALL COMPONENTS DAMAGED DURING CONSTRUCTION SHALL BE RESTORED TO ORIGINAL, OR BETTER CONDITION W/OUT COST TO THE OWNER.
- ALL EXISTING GRADING, PAVING, UTILITIES, AND STRIPING TO <u>\*</u> 2 REMAIN, U.O.N.

REPAIR ALL EXISTING LANDSCAPE, PLANTINGS, AND IRRIGATION IN PLACE, U.O.N.

#### KEYNOTES

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	EXISTING MANHOLE TO REMAIN
<b>2</b>	EXISTING DRYWELL TO REMAIN
3	EXISTING CATCH BASIN TO REMAIN
<b>4</b>	EXISTING AIR COMPRESSOR TO REMAIN
5	EXISTING BOLLARDS TO REMAIN
6	EXISTING CONDUIT TO REMAIN, COORDINATE NEW CONNECTIONS WITH ELECTRICAL CONSULTANT
<b>(7)</b>	EXISTING CANOPY ABOVE TO REMAIN
8	EXISTING CANOPY COLUMNS TO REMAIN
9	EXISTING SIGN
<b>(10)</b>	EXISTING FIRE HYDRANT
$\langle 11 \rangle$	
	EXISTING TRAFFIC LIGHT
$\langle 12 \rangle$	EXISTING TRAFFIC LIGHT EXISTING VENT LOCATION, CONNECT NEW TANK VENT LINES, COORDINATE NEW CONNECTIONS WITH FUEL CONSULTANT
	EXISTING VENT LOCATION, CONNECT NEW TANK VENT LINES,
12	EXISTING VENT LOCATION, CONNECT NEW TANK VENT LINES, COORDINATE NEW CONNECTIONS WITH FUEL CONSULTANT
<ul> <li>12</li> <li>13</li> </ul>	EXISTING VENT LOCATION, CONNECT NEW TANK VENT LINES, COORDINATE NEW CONNECTIONS WITH FUEL CONSULTANT EXISTING TRASH ENCLOSURE TO REMAIN

EXISTING LANDSCAPING TO REMAIN, PROTECT IN PLACE

## **DEMO KEYNOTES**

- DEMO EXISTING FUEL PUMPS AND CONCRETE ISLANDS, PREP FOR NEW
- DEMO EXISTING CONCRETE TO MAKE WAY FOR NEW FUEL PUMPS AND ISLANDS AND CONNECTIONS, PREP FOR NEW
- DEMO EXISTING ASPHALT TO MAKE WAY FOR NEW UNDERGROUND FUEL TANKS AND PADS, PREP FOR NEW CONCRETE PAD
- DEMO EXISTING UNDERGROUND FUEL TANKS, BACKFILL AS REQUIRED DEMO EXISTING CONCRETE PAD TO PREP FOR FUEL TANK
- REMOVAL DEMO EXISTING FUEL TANK MANHOLES
- <7> DEMO EXISTING FUEL TANK LIDS
- 8 DEMO EXISTING PARKING STRIPING AND CURBS, PREP FOR NEW
- 9 EXISTING TENSION LINE TO BE TEMPORARILY REMOVED FOR CONSTRUCTION, COORDINATE WITH UTILITY COMPANY
- DEMO EXISTING ASPHALT TO MAKE WAY FOR NEW CONDUIT/CONNECTIONS, PREP FOR NEW


#### DEMO LEGEND

- EXISTING TO REMAIN
- ----

\_ \_ \_ \_

EXISTING TO BE DEMOLISHED \_ \_ \_ \_



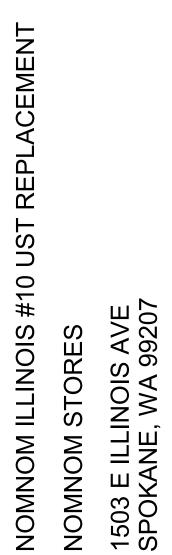



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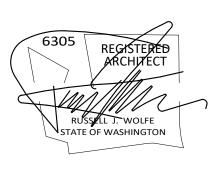




#### **GENERAL NOTES**

- LOCATE ALL UTILITIES PRIOR TO CONSTRUCTION "CALL BEFORE YOU DIG" 1-800-424-5555
- SEE SITE SURVEY FOR EXISTING CONDITIONS

<u>Revisions:</u>



#### **KEYNOTES**

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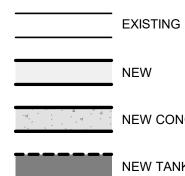
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 $\langle 17 \rangle$ 


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- EXISTING MANHOLE, PROTECT IN PLACE  $\langle 1 \rangle$
- **2** EXISTING DRYWELL, PROTECT IN PLACE
- $\langle 3 \rangle$ EXISTING CATCH BASIN, PROTECT IN PLACE
- COORDINATE NEW ELECTRICAL CONNECTIONS WITH ELECTRICAL CONSULTANT  $\langle 4 \rangle$ 
  - EXISTING CANOPY ABOVE
- $\langle 6 \rangle$ EXISTING CANOPY COLUMNS
- $\langle 7 \rangle$ CONNECT NEW TANK VENT LINES, COORDINATE NEW CONNECTIONS WITH FUEL CONSULTANT
- <u> 8</u> COORDINATE CONNECTION TO EMERGENCY SHUT OFF
- SWITCH WITH FUEL AND ELECTRICAL CONSULTANTS 9 UNDERGROUND FUEL TANK, COORDINATE LOCATION,
  - INSTALL, AND CONNECTIONS WITH FUEL AND ELECTRICAL CONSULTANTS
- **(10)** 8" CONCRETE TANK SLAB WITH #4 REINFORCEMENT TIED AT 16" 0.C.
- $\langle 11 \rangle$ FUEL TANK LIDS, COORDINATE LOCATION AND INSTALL WITH FUEL CONSULTANT
- $\langle 12 \rangle$ FUEL PUMP AND CONCRETE ISLAND, COORDINATE INSTALL AND CONNECTIONS WITH FUEL AND ELECTRICAL CONSULTANTS
- $\langle 13 \rangle$ 6" CONCRETE DRIVE SLAB WITH #4 REINFORCEMENT TIED AT 16" O.C., MAKE FLUSH W/ ADJACENT CONCRETE SLAB/ASPHALT  $\langle 14 \rangle$ 
  - TENTATIVE ELECTRICAL CONDUIT LAYOUT FOR FUEL SYSTEMS, COORDINATE WITH FUEL TANK AND ELECTRICAL CONSULTANTS 60" WIDE ACCESSIBLE PATHWAY STRIPING, 6" BLUE PER CITY
  - STANDARDS ADA PARKING STALL AND AISLE STRIPING PER CITY
  - STANDARDS, SEE STANDARD PLAN G-80A (1/A0.11) AND STANDARD PLAN G-54 (2/A0.11) PARKING STALL STRIPING, 6" WHITE

## LEGEND



- NEW CONCRETE
- NEW TANK
- ----- NEW CONDUIT/CONNECTION

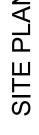

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NOMNOM STORES

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Wolfe Architectural Group

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