SITE CONSTRUCTION PLANS FOR: AVISTA METRO SUBSTATION IMPROVEMENTS

222 SOUTH WALL
SPOKANE, WASHINGTON 99201

SW 1/4 OF SEC. 9, T.25N., R.43E., W.M., SPOKANE COUNTY, WA

SCHEDULE OF DRAWINGS

SHEET NO. DESCRIPTION

C0.1	.CIVIL COVER/VICINITY MAP
C0.5.	TEMP. EROSION/SEDIMENT CONTROL PLAN
	SITE SURFACING/HORIZ. CONTROL PLAN
	GRADING AND DRAINAGE PLAN
C4.0	CIVIL SITE DETAILS
C4.1	GRADING/DRAINAGE DETAILS
110	LANDSCAPE PLANTING PLAN
L2.0	LANDSCAPE IRRIGATION PLAN

GENERAL NOTES:

- 1. ALL MATERIALS, WORKMANSHIP, TESTING AND CONSTRUCTION SHALL BE COMPLETED IN CONFORMANCE WITH THE 2021 WASHINGTON STATE DEPARTMENT OF TRANSPORTATION STANDARD SPECIFICATIONS FOR ROAD, BRIDGE & MUNICIPAL CONSTRUCTION, THE CITY OF SPOKANE STANDARDS, AND THE CITY OF SPOKANE GENERAL SPECIAL PROVISIONS FOR PRIVATE CONTRACTS.
- 2. THE CONTRACTOR SHALL MAINTAIN ALL EXISTING DRAINAGE FACILITIES WITHIN THE CONSTRUCTION AREA UNTIL THE DRAINAGE IMPROVEMENTS ARE IN PLACE AND FUNCTIONING.
- 3. ALL CONTRACTORS WORKING WITHIN THE PROJECT BOUNDARIES ARE RESPONSIBLE FOR COMPLIANCE WITH ALL APPLICABLE SAFETY LAWS OF ANY JURISDICTIONAL BODY. THE CONTRACTOR SHALL BE RESPONSIBLE FOR ALL BARRICADES, SAFETY DEVICES AND CONTROL OF TRAFFIC WITHIN AND AROUND THE CONSTRUCTION AREA.
- 4. ALL MATERIAL FURNISHED ON OR FOR THE PROJECT MUST MEET THE MINIMUM REQUIREMENTS OF THE APPROVING AGENCIES OR AS SET FORTH HEREIN, WHICHEVER IS MORE RESTRICTIVE.
- 5. CONTRACTORS MUST FURNISH PROOF THAT ALL MATERIALS INSTALLED ON THIS PROJECT MEET THE REQUIREMENTS OF ITEM #4 AT THE REQUEST OF THE AGENCY AND/OR THE ENGINEER.
- 6. THE LOCATIONS OF EXISTING UNDERGROUND UTILITIES ARE SHOWN IN AN APPROXIMATE WAY ONLY. THE CONTRACTOR SHALL DETERMINE THE EXACT LOCATION OF ALL EXISTING UTILITIES BEFORE COMMENCING WORK. HE AGREES TO BE FULLY RESPONSIBLE FOR ANY AND ALL DAMAGES WHICH MIGHT BE OCCASIONED BY HIS FAILURE TO EXACTLY LOCATE AND PRESERVE ANY AND ALL UNDERGROUND UTILITIES.
- 7. THE CONTRACTOR SHALL BE RESPONSIBLE FOR ALL PERMITS AS REQUIRED BY THE CITY OF SPOKANE AND THE STATE OF WASHINGTON.
- 8. THE CONTRACTOR SHALL TAKE CAUTION TO PREVENT SOIL AND DEBRIS FROM BEING TRACKED ONTO CITY STREETS. IF SOIL AND/OR DEBRIS IS TRACKED ONTO THE CITY STREETS, THE CONTRACTOR SHALL BE RESPONSIBLE FOR REMOVING SAID SOIL AND/OR DEBRIS AT THE END OF EACH WORKING DAY.
- 9. CONTRACTOR TO COORDINATE AND PROVIDE FOR INSTALLATION AND/OR RELOCATION OF DRY UTILITIES AS NECESSARY TO ELIMINATE CONFLICTS DURING CONSTRUCTION.
- 10. THE CONTRACTOR SHALL PROVIDE A COMPREHENSIVE TRAFFIC CONTROL PLAN (INCLUDING SIDEWALK ACCESS PLANS) WHICH SHALL BE SUBMITTED TO AND APPROVED BY THE CITY OF SPOKANE ENGINEERING DEPARTMENT PRIOR TO ANY WORK IN THE PUBLIC R.O.W.. CONTRACTOR IS RESPONSIBLE FOR SAFETY TO THE PUBLIC BY MINIMIZING THE INTERRUPTION OF USE OF ROADS AND PROVIDING SIGNS, FLARES, BARRICADES, ETC. AS NECESSARY.
- 11. CONTRACTOR SHALL COORDINATE WORK COMPLETED BY THE OWNER AND ALSO WORK COMPLETED "BY OTHERS".
- 12. THE CONTRACTOR IS REQUIRED TO HAVE A COMPLETE SET OF THE APPROVED PLANS ON THE JOB SITE WHENEVER CONSTRUCTION IS IN PROGRESS. CONTRACTOR SHALL ALSO MAINTAIN ON THE SITE A COMPLETE SET OF RED LINE RECORD DRAWINGS INDICATING ALL CHANGES FROM THE APPROVED DRAWINGS INCLUDING STRUCTURE LOCATION PIPE MATERIAL AND INVERT ELEVATIONS.
- 13. CONTRACTOR IS RESPONSIBLE FOR REPAIR OF ANY DAMAGE TO ADJACENT EXISTING PROPERTIES OR IMPROVEMENTS. CONTRACTOR IS RESPONSIBLE FOR CLEAN-UP OF ANY AREAS DISTURBED BY HIS ACTIVITIES.
- 14. THE CONTRACTOR SHALL MEET CURRENT BACKFLOW STANDARDS PER WAC 246-290-490 AND FOLLOW CITY OF SPOKANE WATER DEPARTMENT RULES AND REGULATIONS FOR ALL WATER SERVICE INSTALLATIONS.
- 15. THE CONTRACTOR IS RESPONSIBLE FOR REMAINING DEMOLITION WORK, AS NECESSARY, TO COMPLETE THE PROJECT. THE CONTRACTOR SHALL REVIEW THE PROJECT LIMITS FOR QUANTITY AND TYPE OF STRUCTURES, GROUND COVER AND DEBRIS AT THE TIME OF BIDDING AND SHALL INCORPORATE REMOVALS / DISPOSAL IN THEIR BID. ALL EXISTING UTILITIES ON SITE (INSIDE PROPERTY LINE) ARE ASSUMED TO BE REMOVED OUT TO PROPERTY LINE. CONTRACTOR SHALL VERIFY ACTUAL LIMITS OF REMOVAL WITH AVISTA.

SURVEY CONTROL POINTS HORIZONTAL DATUM: NAD 1983(XX) VERTICAL DATUM: NAVD 88

TBM#1001 MAG NAIL LOCATED APPROX. 62.4' WESTERLY OF NORTHWEST PROPERTY CORNER. N 257,158.57 E 2,480,514.22

EL 1906.44

EL 1911.61


MAG NAIL LOCATED APPROX. 4.0' NORTHEAST OF NORTHEAST PROPERTY CORNER. N 257,176.83 E 2,480,860.37 EL 1906.90


TBM#2011 MAG NAIL LOCATED APPROX. 100.7' SOUTHEAST OF SOUTHEAST PROPERTY CORNER.
N 256,952.65
E 2,480,924.17

REBAR WITHOUT CAP LOCATED APPROX. 75.9'
NORTHWESTERLY OF NORTHWEST PROPERTY CORNER.
N 257,172.74
E 2,480,501.63
EL 1907.54

REBAR WITH CAP LOCATED APPROX. 83.9'
SOUTHWEST OF SOUTHWEST PROPERTY CORNER.
N 256,941.83
E 2,480,550.52
EL 1907.84



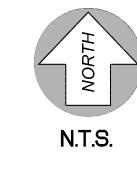

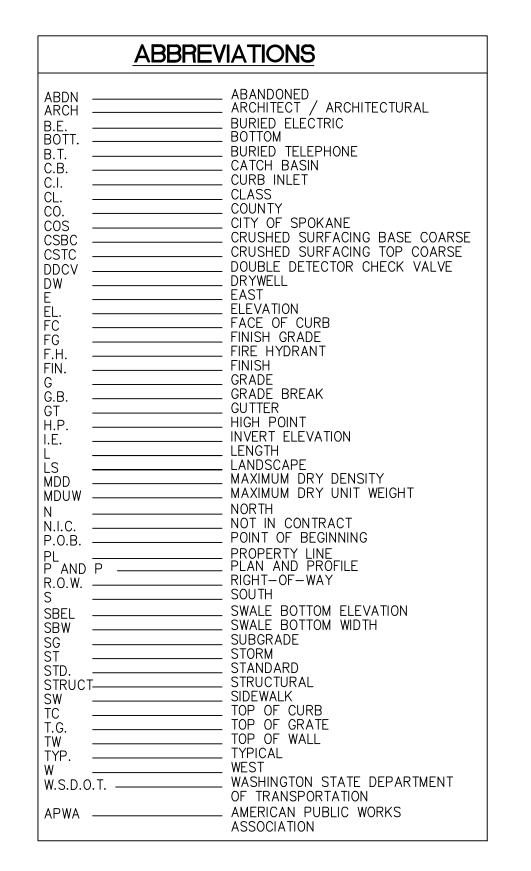

DESIGN ACCEPTANCE IS SUBJECT TO THE FOLLOWING CONDITIONS:

1. THIS ACCEPTANCE IS FOR DESIGN ONLY. ACCEPTANCE IS BASED ON COMPLIANCE WITH THE PERMIT CONSTRUCTION PLANS STAMPED BY PLANNING AND DEVELOPMENT AS NOTED. CHANGES IN DESIGN FOR CONSTRUCTION ARE ONLY ACCEPTED WITH WRITTEN APPROVAL BY THIS OFFICE.

- 2. IN PROVIDING THIS ACCEPTANCE OF PLANS, THE CITY OF SPOKANE STATES ITS'
 BELIEF THAT THE PLANS CONFORM TO REGULATORY REQUIREMENTS AS NOTED
 ABOVE. SUCH ACCEPTANCE IS NOT A GUARANTEE OR WARRANTY OF DESIGN
 SUFFICIENCY FOR ANY PURPOSE OR PROMISE OF CUSTOMER SATISFACTION. THE
 OWNER AND ENGINEER REMAIN SOLELY RESPONSIBLE FOR DESIGN AND EXECUTION OF
 THE PROJECT.
- 3. THE CITY'S ACCEPTANCE OF THIS SUBMITTAL DOES NOT RELIEVE THE OWNER OR HIS/HER AGENTS FROM ANY LIABILITY RELATED TO PORTIONS OF THE DESIGN THAT ARE NOT IN CONFORMANCE WITH THE STANDARDS, OR WHICH DO NOT FOLLOW GOOD ENGINEERING PRACTICE. ACTIONS OR CLAIMS ARISING FROM PLANNING, SURVEYING, ENGINEERING, DESIGN, CONSTRUCTION, ALTERATION, REPAIR, ETC., OF IMPROVEMENTS UPON REAL PROPERTY WILL ADHERE TO THE REQUIREMENTS AS NOTED IN RCW 4.16.310.

UNDERGROUND SERVICE ALER

ONE-CALL NUMBER

CALL TWO BUSINESS DAY:

BEFORE YOU DIG

OWNER: AVISTA CORP.
EAST 1411 MISSION AVE.
SPOKANE, WA 99220
CONTACT: AARON HENSON
PHONE: (509) 495-4550
EMAIL: Aaron.Henson@avistacorp.com

PARCEL I.D. NO: 35192.2207, .2206, .2205

SITE ADDRESS: 222 S. WALL STREET SPOKANE, WA 99201

CIVIL ENGINEER: PARAMETRIX 106 W. MISSION AVE. SPOKANE, WA 99201 CONTACT: SCOTT BUSCH PHONE: 509-328-3371

LEGEND							
EXISTING	DESC.	PROPOSED					
	CONIFER TREE						
	DECIDUOUS TREE						
© © W	STORM MANHOLE DRYWELL	●●					
C.B.	CATCH BASIN						
co ^O	CLEANOUT CURB INLET	•					
0	SEWER MANHOLE SIGN	•					
- O -	POWER POLE BOLLARD						
\bowtie	WATER VALVE	H					
(⊞	FIRE HYDRANT WATER METER	A					
] J	JUNCTION BOX	~ *					
	PARKING METER	•					
	CURB						
	CURB & GUTTER ASPHALT LINE						
	CONCRETE LINE SEWER LINE						
	WATER LINE	8"W					
	WATER LINE (IRRIGATION)	<u>(IRR</u>) _					
SD	PIPE CASING STORM LINE	SD					
— -AP— — — — — — — — — — — — — — — — — — —	OVERHEAD POWER LINE BURIED TEL./FIBER OPTIC						
— BC— — —	BURIED CABLE GAS						
1901——	MINOR CONTOUR	1901——					
1905———	MAJOR CONTOUR SWALE CONTOUR	1905 					
xx	FENCE RIGHT-OF-WAY LINE						
	BOUNDARY						
	LOT LINE CENTER LINE						
	ASPHALT						
	GRAVEL SECTION (PER AVISTA STD.)						
	GRAVEL SECTION (INFILTRATIVE)						
	CONCRETE	44					
	SWALE BOTTOM						
	BUILDING						
110.48 ×	SPOT EL. ASPH/GUT	⊗ _{98.05}					
110.53 <u>A</u>	SPOT EL.(INTERPOLATED)						
B−2004	SOIL BORING						

UTILITY STATEMENT

THE UNDERGROUND UTILITIES SHOWN HAVE BEEN LOCATED AS ACCURATELY AS POSSIBLE FROM FIELD SURVEY INFORMATION AND EXISTING DRAWINGS. PARAMETRIX MAKES NO GUARANTEES THAT THE UNDERGROUND UTILITIES SHOWN COMPRISE ALL SUCH UTILITIES IN THE AREA, EITHER IN SERVICE OR ABANDONED. FURTHER, WE DO NOT WARRANT THAT THE UNDERGROUND UTILITIES SHOWN ARE IN EXACT LOCATION INDICATED, ALTHOUGH WE DO CERTIFY THAT THEY ARE LOCATED AS ACCURATELY AS POSSIBLE FROM INFORMATION AVAILABLE.

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 Project No.:
 20.134

 Date:
 9.28.21

 Drawn By:
 S.M.B.

 Checked By:
 M.J.L.


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<u>UTILITY STATEMENT</u>

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- INSTALL CONSTRUCTION ENTRANCE PER WSDOT STANDARD PLAN 1-80.10-01 (LOCATION SUBJECT TO CHANGE)
- POSTED CONCRETE WASHOUT SEE NOTE 23. (LOCATION SUBJECT TO CHANGE)
- INSTALL INLET PROTECTION (PAVED) 3 PER WSDOT STANDARD PLAN 1-40.20-00
- 4 INSTALL INLET PROTECTION (UNPAVED)
 PER WSDOT STANDARD PLAN I-40.10-00
- INSTALL SILT FENCE 5 INSTALL SILI FENCE
 PER WSDOT STANDARD PLAN 1-30.10-02
- 6 PLAN I-30.10-01 OR WATTLES AS PER NOTE 21 INSTALL SILT FENCE AS PER WSDOT STANDARD ALONG THE ASPHALT EDGE, BASED ON CONTRACTOR'S MEANS AND METHODS OF CONSTRUCTION.
 - INSTALL INLET PROTECTION (PAVED) PER WSDOT STANDARD PLAN 1-40.20-00 IN EXISTING INLETS UNTIL INLETS ARE REMOVED.





EROSION CONTROL NOTES:

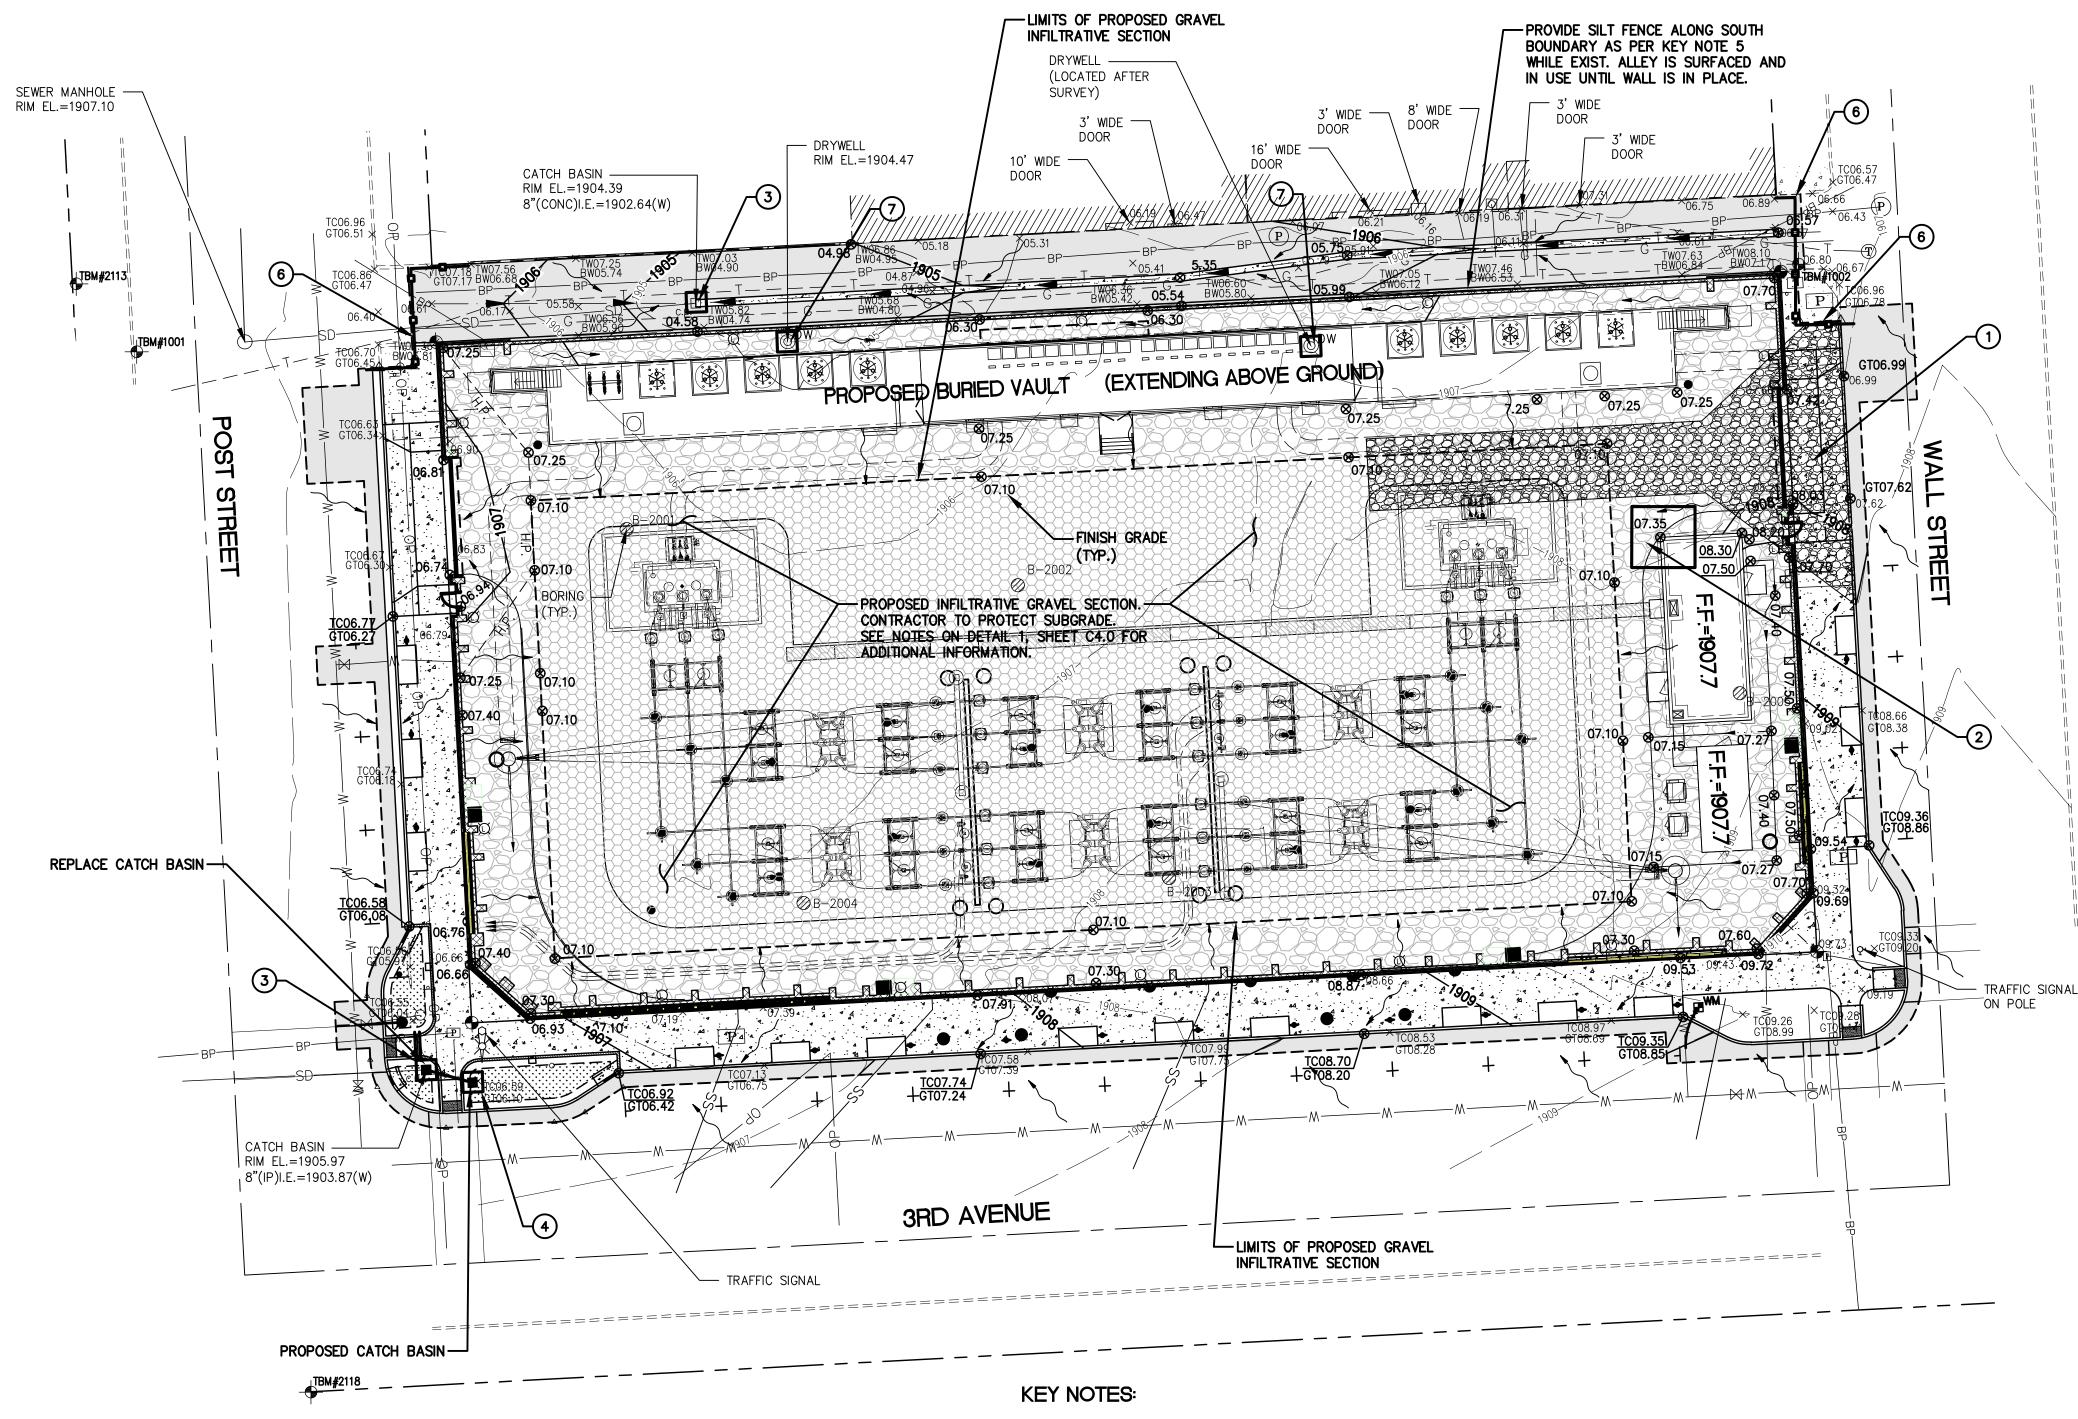- 1. THE FOLLOWING CONSTRUCTION SEQUENCE SHALL BE FOLLOWED IN ORDER TO BEST MINIMIZE THE POTENTIAL FOR EROSION AND SEDIMENTATION CONTROL PROBLEMS:
- (A) CLEAR AND GRUB SUFFICIENTLY FOR INSTALLATION OF TEMPORARY ESC BMPs;
- (B) INSTALL TEMPORARY ESC BMPs, CONSTRUCTING SEDIMENT TRAPPING BMPs AS ONE OF THE FIRST STEPS PRIOR
- (C) CLEAR, GRUB AND ROUGH GRADE FOR ROADS, TEMPORARY ACCESS POINTS AND UTILITY LOCATIONS;
- (D) STABILIZE ROADWAY APPROACHES AND TEMPORARY ACCESS POINTS WITH THE APPROPRIATE CONSTRUCTION
- (E) CLEAR, GRUB AND GRADE INDIVIDUAL LOTS OR GROUP OF LOTS;
- TEMPORARY STABILIZE, THROUGH RE-VEGETATION OR OTHER APPROPRIATE BMPs. LOTS OR GROUPS OF LOTS
- IN SITUATIONS WHERE SUBSTANTIAL CUT OF FILL SLOPES ARE A RESULT OF THE SITE GRADING; (G) CONSTRUCT ROADS, BUILDINGS, PERMANENT STORMWATER FACILITIES (I.E. INLETS, PONDS, UIC FACILITIES, ETC.);
- (H) PROTECT ALL PERMANENT STORMWATER FACILITIES UTILIZING THE APPROPRIATE BMPs; INSTALL PERMANENT ESC CONTROLS, WHEN APPLICIABLE; AND,
- REMOVE TEMPORARY ESC CONTROLS WHEN: • PERMANENT ESC CONTROLS. WHEN APPLICIBLE, HAVE BEEN COMPLETELY INSTALLED; AND
- ALL LAND—DISTURBING ACTIVITIES THAT HAVE THE POTENTIAL TO CAUSE EROSION OR SEDIMENTATION PROBLEMS HAVE CEASED; AND,
- · HARDSCAPE ELEMENTS HAVE BEEN INSTALLED SUCH AS ASPHALT, CONCRETE, BUILDINGS; AND, • VEGETATION HAS BEEN ESTABLISHED IN THE AREAS NOTED AS REQUIRING VEGETATION ON THE ACCEPTED ESC PLAN ON FILE WITH THE LOCAL JURISDICTION.
- 2. INSPECT ALL ROADWAYS AND ASPHALT SURFACES, AT THE END OF EACH DAY, ADJACENT TO THE CONSTRUCTION ACCESS ROUTE. IF IT IS EVIDENT THAT SEDIMENT HAS BEEN TRACKED ON ADJACENT ASPHALT SURFACES, OFF SITE AND/OR BEYOND THE ROADWAY APPROACH, CLEANING IS REQUIRED. CONTRACTOR TO INSTALL STABILIZED CONSTRUCTION ENTRANCE PER WSDOT STD. PLAN I-80.10-02 AND/OR MAINTAIN/CLEAN EXISTING CONSTRUCTION ENTRANCE IF SEDIMENT IS CONTINUALLY TRACKED OFF SITE.
- 3. IF SEDIMENT REMOVAL IS NECESSARY PRIOR TO STREET WASHING, IT SHALL BE REMOVED BY SHOVELING OR PICKUP SWEEPING AND TRANSPORTED TO A CONTROLLED SEDIMENT DISPOSAL AREA.
- 4. IF STREET WASHING IS REQUIRED TO CLEAN SEDIMENT TRACKED OFF SITE, ONCE SEDIMENT HAS BEEN REMOVED, STREET WASH WASTEWATER SHALL BE CONTROLLED BY PUMPING BACK ON-SITE OR OTHERWISE PREVENTED FROM DISCHARGING INTO SYSTEMS TRIBUTARY TO WATERS OF THE STATE.
- 5. RESTORE CONSTRUCTION ACCESS ROUTE EQUAL TO OR BETTER THAN THE PRE-CONSTRUCTION CONDITION.
- 6. NOT USED.
- 7. INSPECT SEDIMENT CONTROL BMPs WEEKLY AT A MINIMUM, DAILY DURING A STORM EVENT, AND AFTER ANY DISCHARGE FROM THE SITE (STORMWATER OR NON-STORMWATER). THE INSPECTION FREQUENCY MAY BE REDUCED TO ONCE A MONTH IF THE SITE IS STABILIZED AND INACTIVE.
- 8. CONTROL FUGITIVE DUST FROM CONSTRUCTION ACTIVITY IN ACCORDANCE WITH THE STATE AND/OR LOCAL AIR QUALITY CONTROL AUTHORITIES WITH JURISDICTION OVER THE PROJECT AREA.
- 9. STABILIZE EXPOSED UNWORKED SOILS (INCLUDING STOCKPILES), WHETHER AT FINAL GRADE OR NOT, WITHIN 10 DAYS DURING THE REGIONAL DRY SEASON (JULY 1 THROUGH SEPTEMBER 30) AND WITHIN 5 DAYS DURING THE REGIONAL WET SEASON (OCTOBER 1 THROUGH JUNE 30). SOILS MUST BE STABILIZED AT THE END OF A SHIFT BEFORE A HOLIDAY WEEKEND IF NEEDED BASED ON THE WEATHER FORECAST. THIS TIME LIMIT MAY ONLY BE ADJUSTED BY A LOCAL JURISDICTION WITH A "QUALIFIED LOCAL PROGRAM", IF IT CAN BE DEMONSTRATED THAT THE RECENT PRECIPITATION JUSTIFIES A DIFFERENT STANDARD AND MEETS THE REQUIREMENTS SET FORTH IN THE CONSTRUCTION STORMWATER GENERAL PERMIT.
- PROTECT INLETS, DRYWELLS, CATCH BASINS, AND OTHER STORMWATER MANAGEMENT FACILITIES FROM SEDIMENT, WHETHER OR NOT FACILITIES ARE OPERABLE. INSTALL INLET PROTECTION AS PER WSDOT STD. PLAN I-40.10-00 (FOR UNPAVED AREAS) OR WSDOT STD. PLAN I-40.20-00 (FOR PAVED AREAS).
- 11. KEEP ROADS ADJACENT TO THE INLETS CLEAN.
- 12. INSPECT INLETS WEEKLY AT A MINIMUM AND DAILY DURING STORM EVENTS.
- 13. CONSTRUCT STORMWATER CONTROL FACILITIES (DETENTION/RETENTION STORAGE POND OR SWALES) BEFORE GRADING BEGINS. THESE FACILITIES SHALL BE OPERATIONAL BEFORE CONSTRUCTION OF IMPERVIOUS SITE IMPROVEMENTS. CONTRACTOR IS RESPONSIBLE FOR REMOVAL OF EXCESS STORMWATER ON SITE UNTIL INFILTRATIVE GRAVEL SECTION CAN BE CONSTRUCTED WITHOUT POSSIBILITY OF BEING NEGATIVELY IMPACTED.
- 14. STOCKPILE MATERIALS (SUCH AS TOPSOIL) ON SITE, KEEPING OFF OF ROADWAYS AND SIDEWALKS.
- 15. COVER, CONTAIN AND PROTECT ALL CHEMICAL, LIQUID PRODUCTS, PETROLEUM PRODUCTS, AND NON-INERT WASTE), USE SECONDARY CONTAINMENT FOR ON-SITE FUELING TANKS.
- 16. CONDUCT MAINTENANCE AND REPAIR OF HEAVY EQUIPMENT AND VEHICLES INVOLVING OIL CHANGES, HYDRAULIC SYSTEM REPAIRS, SOLVENT AND DE-GREASING OPERATIONS, FUEL TANK DRAIN DOWN AND REMOVAL, AND OTHER ACTIVITIES THAT MAY RESULT IN DISCHARGE OR SPILLAGE OF POLLUTANTS TO THE GROUND OR INTO STORMWATER RUNOFF USING SPILL PREVENTION MEASURES, SUCH AS DRIP PANS. CLEAN ALL CONTAMINATED SURFACES IMMEDIATELY FOLLOWING ANY DISCHARGE OR SPILL INCIDENT. IF RAINING OVER EQUIPMENT OR VEHICLE, PERFORM EMERGENCY REPAIRS ON SITE USING TEMPORARY PLASTIC BENEATH THE VEHICLE.
- 17. CONDUCT APPLICATION OF AGRICULTURAL CHEMICALS, INCLUDING FERTILIZER AND PESTICIDES, IN SUCH A MANNER, AND AT APPLICATION RATES, THAT INHIBITS THE LOSS OF CHEMICALS INTO STORMWATER RUNOFF FACILITIES. AMEND MANUFACTURER'S RECOMMENDED APPLICATION RATES AND PROCEDURES TO MEET THIS REQUIREMENT, IF NECESSARY.
- 18. INSPECT ON A REGULAR BASIS (AT A MINIMUM WEEKLY, AND DAILY DURING/AFTER A RUNOFF PRODUCING EVENT) AND MAINTAIN ALL EROSION AND SEDIMENT CONTROL BMPs TO ENSURE SUCCESSFULL PERFORMANCE OF THE BMPs. NOTE THAT INLET PROTECTION DEVICES SHALL BE CLEANED OR REMOVED AND REPLACED BEFORE SIX INCHES OF SEDIMENT CAN ACCUMULATE.
- 19. REMOVE TEMPORARY ESC BMPs WITHIN 30 DAYS AFTER THE TEMPORARY BMPs ARE NO LONGER NEEDED. PERMANENTLY STABILIZE AREAS THAT ARE DISTURBED DURING THE REMOVAL PROCESS.
- 20. UPON COMPLETION OF GROUND DISTURBING ACTIVITY AND STABILIZATION OF AREAS CONTRIBUTING TO THE RESPECTIVE PERMANENT STORMWATER SWALES/PONDS, CONTRACTOR SHALL REMOVE ACCUMULATED SILT AND SEDIMENT FROM THE PERMANENT SWALES/PONDS. REPAIR AND REGRADE AS NECESSARY TO MEET THE REQUIREMENTS OF THE PLANS AND SPECIFICATIONS.
- 21. INSTALL WATTLES ON EXIST. PAVEMENT ON DOWNSTREAM SIDE OF EXPOSED AREAS (TYPICAL). SECURE WITH CMU BLOCKS OR OTHER WEIGHTS TO PREVENT MOVEMENT, AND MARK WITH TRAFFIC CONES.
- 22. CONTRACTOR IS RESPONSIBLE TO MAINTAIN A COPY OF THE CURRENT TESC PLAN ONSITE. THE CONTRACTOR SHALL ALSO UPDATE THE PLAN, WITH RED-LINED MARK-UP, ANY REVISIONS, ADDITIONS OR ADJUSTMENT TO THE BMPs TO MAINTAIN THE PLAN INTENT AND REQUIREMENTS.
- 23. CONTRACTOR TO PROVIDE A DESIGNATED, POSTED CONCRETE WASHOUT AREA. THE CONCRETE WASHOUT SHALL NOT BE ALLOWED TO DRAIN OFF THE SITE OR INTO ANY EXISTING OR FUTURE STORM DRAINAGE FACILITIES. WASHOUT SHALL, AS A MINIMUM, BE INSTALLED WITH A BERM TO ISOLATE AND CONTAIN THE CONCRETE WASTE. HARDENED WASH CONCRETE SHALL BE BROKEN UP AND REMOVED FROM SITE. A PORTABLE CONCRETE WASHOUT IS REQUIRED WHEN BUILDING CONSTRUCTION IS INITIATED.
- 24, THE CONTRACTOR SHALL COMPLY WITH ALL REQUIREMENTS SET FORTH BY THE DEPARTMENT OF ECOLOGY'S CONSTRUCTION STORMWATER GENERAL PERMIT AS OBTAINED BY THE OWNER. THE CONTRACTOR SHALL BE RESPONSIBLE FOR PROVIDING A CERTIFIED EROSION AND SEDIMENT CONTROL LEAD (CESCL) TO MONITOR EROSION CONTROL FACILITIES AND MONITOR SITE DISCHARGES IN ACCORDANCE WITH WSDOE REQUIREMENTS. THE CONTRACTOR SHALL PREPARE/PROVIDE AND MAINTAIN A COPY OF THE STORMWATER POLLUTION

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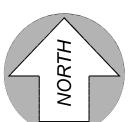
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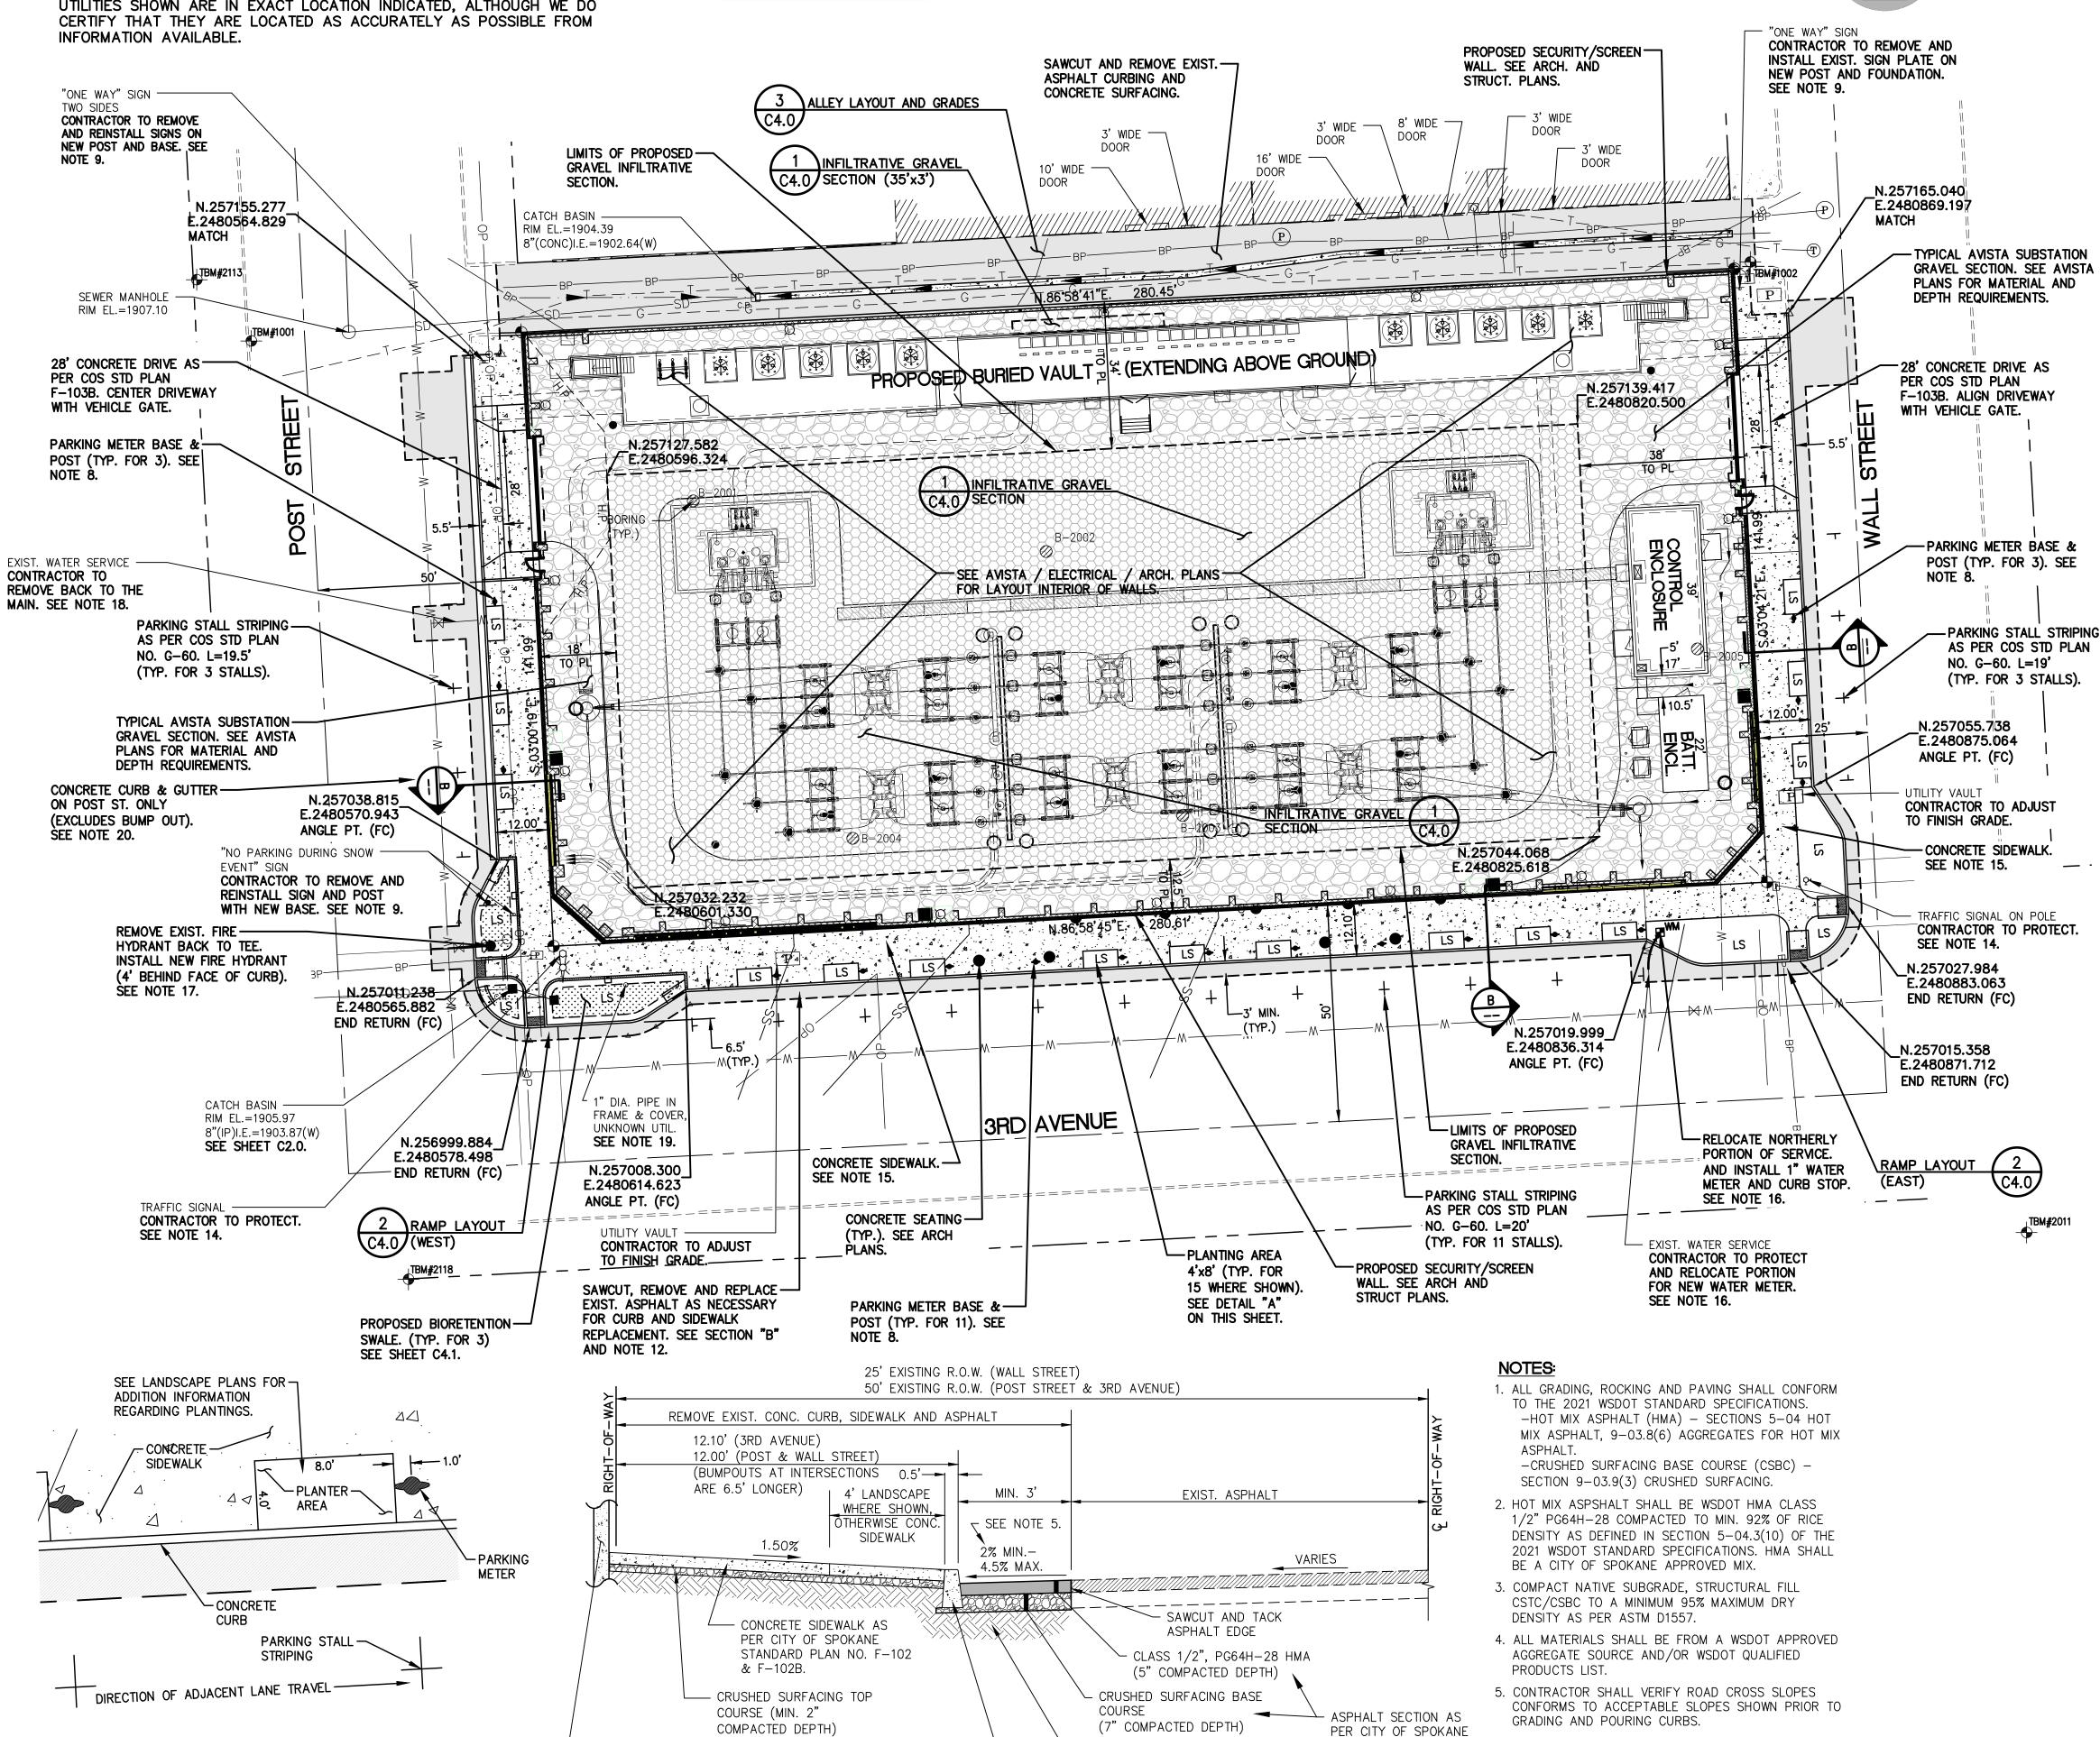
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1015 N. Calispel Street Suite 'B' Spokane, Washington 99201 p 509.455.6999 f 509.455.3933 www.wagarch.com

Project No.: 20.134 9.28.21 Drawn By: S.M.B. Checked By: M.J.L.





STANDARD PLAN NO.

W-101A

- COMPACTED SUBGRADE

- **POST STREET ONLY - CONCRETE CURB &

GUTTER AS PER CITY OF SPOKANE STANDARD

PLAN NO. F-106. (MIN. COMPACTED DEPTH OF 2")

SEE NOTE 3.

- PROPOSED SECURITY/

SCREEN WALL. SEE

ARCH. AND STRUCT.

PLANS.

CONCRETE CURB AS PER CITY ——

NO. F-106. (MIN. COMPACTED

DEPTH OF 2")

NOT TO SCALE

OF SPOKANE STANDARD PLAN 🔍

CURB AND SIDEWALK INSTALLATION

PARKING STALL PLANTER

SCALE: 1"=5"

- ALL MATERIALS, WORKMANSHIP, TESTING AND CONSTRUCTION SHALL BE IN CONFORMANCE WITH THE 2021 WASHINGTON STATE STANDARD SPECIFICATIONS FOR ROAD, BRIDGE & MUNICIPAL CONSTRUCTION, THE CITY OF SPOKANE STANDARDS, AND THE CITY OF SPOKANE GENERAL SPECIAL PROVISIONS FOR PRIVATE CONTRACTS.
- 2. CONTRACTOR SHALL VERIFY EXISTING SITE CONDITIONS PRIOR TO CONSTRUCTION.
- 3. SEE GRADING AND DRAINAGE PLAN FOR GRADING AND ELEVATION OF CURBS, WALLS, PARKING AREAS, SIDEWALKS AND NEW ACCESSES.
- 4. CONTRACTOR SHALL COORDINATE WITH THE CITY OF SPOKANE AND THE CITY OF SPOKANE FIRE DEPARTMENT FOR CONSTRUCTION TESTING AND INSPECTION AS NECESSARY. ALL TESTING SHALL BE PROVIDED, AS A MINIMUM, IN ACCORDANCE WITH CITY PERMIT REQUIREMENTS.
- 5. INSTALLATION OF CONCRETE CURB SHALL BE IN ACCORDANCE WITH CITY OF SPOKANE STANDARD PLAN NO. F-106. CURB SHALL BE INSTALLED WITH 6" EXPOSURE UNLESS NOTED OTHERWISE. PROVIDE 12" NOSE-DOWN AT LOCATIONS WHERE CURB DOES NOT MATCH INTO BUILDINGS, CURBING, OR RETAINING WALLS.
- 6. ALL APPROVALS AND PERMITS REQUIRED BY THE CITY OF SPOKANE SHALL BE OBTAINED BY THE CONTRACTOR PRIOR TO CONSTRUCTION. NO REVISIONS SHALL BE MADE TO THE APPROVED PLANS WITHOUT APPROVAL FROM THE CITY OF SPOKANE AND THE DESIGN ENGINEER OF RECORD.
- AN OBSTRUCTION PERMIT IS REQUIRED FOR ALL WORK WITHIN CITY RIGHT-OF-WAY. IF APPLICABLE, A TRAFFIC CONTROL PLAN, (INCLUDING PEDESTRIAN TRAFFIC CONTROL FOR SIDEWALK CLOSURES) WILL BE REQUIRED WITH THE OBSTRUCTION PERMIT APPLICATION. ALL FEES AND TRAFFIC CONTROL PLANS SHALL BE THE RESPONSIBILITY OF THE CONTRACTOR.
- 8. CONTRACTOR TO COORDINATE PARKING METER POST FOOTING INSTALLATION, POST INSTALLATION AND METER HEAD INSTALLATION WITH CITY FORCES. CONTRACTOR IS RESPONSIBLE TO REMOVE AND SALVAGE EXISTING PARKING METERS. CONTRACTOR TO COORDINATE REUSE OF EXISTING (SALVAGED) PARKING METER HEADS WITH CITY FORCES. CONTRACTOR PAYS FOR PARKING METER POST FOOTING. CITY PAYS FOR PARKING METER POST, POST INSTALLATION AND METER HEAD INSTALLATION.
- 9. ALL SIGNAGE SHALL BE INSTALLED IN ACCORDANCE WITH CITY OF SPOKANE STANDARD PLAN NO. G-10A, G-10C, G-20A AND G-20B. STREET SIGN POST LOCATIONS SHALL BE FIELD LOCATED/VERIFIED BY THE CITY OF SPOKANE PRIOR TO INSTALLATION.
- 10. ALL SIDEWALKS, CURBS, AND DRIVEWAY APPROACHES ADJACENT TO THE PROPERTY WILL BE REVIEWED BY THE CITY AT THE END OF THE PROJECT WHEN A CERTIFICATE OF OCCUPANCY IS REQUESTED. IF ANY ARE FOUND TO BE BROKEN, HEAVED, SUNKEN OR MISSING, THEY MUST BE REPAIRED/REPLACE WHETHER THE DAMAGE WAS EXISTING OR CAUSED BY CONSTRUCTION, AT THE CONTRACTOR'S EXPENSE. THE CONTRACTOR SHALL REQUEST A SIDEWALK INSPECTION PRIOR TO REQUESTING OCCUPANCY BY CONTACTING THE CITY OF SPOKANE AT (509) 625-6300 TO ARRANGE A SITE VISIT.
- 11. THE CONTRACTOR SHALL PROVIDE THE OWNER AND DESIGN ENGINEER WITH RECORD DRAWINGS PRIOR TO FINAL APPROVAL. ALL DEVIATIONS FROM THE ORIGINAL PLANS MADE DURING THE COURSE OF CONSTRUCTION INCLUDING LOCATIONS, INVERTS AND DEPTHS OF UTILITIES SHALL BE CLEARLY MARKED ON THE RECORD DRAWINGS.
- 12. PATCH PAVEMENT PER COS STD. PLAN W-101A "ARTERIAL STREET", 5" CL 1" HMA (PG64H-28) OVER 7" CSBC. THIS PAVEMENT SECTION APPLIES TO POST STREET, 3RD AVENUE AND WALL STREET. SAWCUT ALL EXISTING ASPHALT EDGES PRIOR TO MATCHING WITH NEW ASPHALT SECTION. ALL PAVEMENT CUTS IN THE PUBLIC RIGHT-OF-WAY SHALL BE IN ACCORDANCE WITH THE REGIONAL PAVEMENT CUT POLICY.
- 13. THE CONTRACTOR SHALL CONTACT THE DEPARTMENT OF ENGINEERING SERVICES CONSTRUCTION MANAGEMENT OFFICE, 1225 E. MARIETTA AVE., 509-625-7722 TO ARRANGE A MUTUALLY AGREEABLE "START WORK DATE".
- 14. CONTRACTOR TO PROTECT EXISTING TRAFFIC SIGNAL, POLE-SINGLE MAST ARM, FOUNDATION AND CONDUIT DURING CONSTRUCTION. ELECTRICAL SERVICE AND TRAFFIC SIGNALIZATION TO BE UNINTERRUPTED DURING CONSTRUCTION.
- 15. INSTALLATION OF CONCRETE SIDEWALK SHALL BE IN ACCORDANCE WITH CITY OF SPOKANE STANDARD PLAN NO. F-102.
- INSTALL 1" IRRIGATION METER WITH 1" SERVICE AND NEW CURB STOP WITH BOX AS PER CITY OF SPOKANE STANDARD PLANS Y-111 AND Y-112. METER BOX SHALL BE CENTERED 3.25' BEHIND FACE OF CURB AND A MINIMUM 10' FROM EDGE OF WALL. CONTRACTOR SHALL PROVIDE TRAFFIC CONTROL, EXCAVATION, BEDDING, BACKFILL, COMPACTION, REMOVAL AND REPLACEMENT OF EXISTING IMPROVEMENTS AND INSTALLATION OF METER BOX IN ACCORDANCE WITH CITY REQUIREMENTS, CONTRACTOR TO COORDINATE RELOCATION OF EXISTING SERVICE PIPE TO CONNECT TO NEW CURB STOP AND INSTALLATION OF SERVICE FROM CURB STOP TO THE METER WITH CITY OF SPOKANE WATER DEPARTMENT. RELOCATION, INSTALLATION AND MATERIALS SHALL BE PER CITY OF SPOKANE STANDARDS. ALL METER AND TAP FEES SHALL BE PAID BY THE CONTRACTOR.
- 17. FIRE HYDRANT SHALL BE INSTALLED AS PER CITY OF SPOKANE STANDARD PLAN Y-101. CONNECT AT EXIST. TEE WITH NEW VALVE AND VALVE BOX. PROVIDE A MINIMUM 3' CLEAR AROUND FIRE HYDRANT FROM STRUCTURES, CURB AND LANDSCAPE.
- 18. EXISTING ABANDONED WATER SERVICE SHALL BE "KILLED" BY CITY FORCES AT THE CONNECTION TO THE MAIN. ACTUAL WORK ON WATER SERVICE AND AT MAIN SHALL BE COMPLETED BY CITY FORCES. CONTRACTOR TO COORDINATE AND PROVIDE, TRAFFIC CONTROL, EXCAVATION, BEDDING, BACKFILL, COMPACTION AND ASPHALT REMOVAL AND REPLACEMENTS. CONTRACTOR TO PROVIDE FOR REMOVAL OF EXIST. SERVICE LINE. BACKFILL AND COMPACT W/STRUCTURAL MATERIAL UPON COMPLETION OF
- 19. CONTRACTOR TO EXCAVATE AND DETERMINE SOURCE OF UNKNOWN 1" DIA. UTILITY AND CONTACT AVISTA PROJECT MANAGER AND DESIGN ENGINEER WITH RESULT OF INVESTIGATION TO DETERMINE REMOVAL OR ADJUSTMENT OF UTILITY. FOR BID PURPOSES, CONTRACTOR TO ASSUME ADJUSTMENT OF UTILITY AND FRAME COVER TO FINISH GRADE.
- 20. CURBING INSTALLATION ALONG POST STREET SHALL BE IN ACCORDANCE WITH SECTION B EXCEPT, CURBING SHALL BE CONCRETE CURB & GUTTER IN LIEU OF CONCRETE CURB AND MINIMUM 3' ASPHALT REPLACEMENT SHALL EXTEND FROM LIP OF GUTTER.

CONSTRUCTION NOTES: (NOTES APPLY TO SHEET C1.0 AND C4.0)



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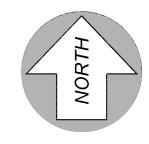



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Project No.: 20.134 9.28.21 Drawn By: S.M.B. Checked By: M.J.L.

THE UNDERGROUND UTILITIES SHOWN HAVE BEEN LOCATED AS ACCURATELY AS POSSIBLE FROM FIELD SURVEY INFORMATION AND EXISTING DRAWINGS. PARAMETRIX MAKES NO GUARANTEES THAT THE UNDERGROUND UTILITIES SHOWN COMPRISE ALL SUCH UTILITIES IN THE AREA, EITHER IN SERVICE OR ABANDONED. FURTHER, WE DO NOT WARRANT THAT THE UNDERGROUND UTILITIES SHOWN ARE IN EXACT LOCATION INDICATED, ALTHOUGH WE DO CERTIFY THAT THEY ARE LOCATED AS ACCURATELY AS POSSIBLE FROM INFORMATION AVAILABLE.






UNDERGROUND SERVICE ALER ONE-CALL NUMBER CALL TWO BUSINESS DAY

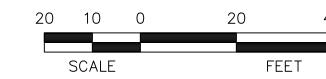8"I.E.=1903.95(SE)

EXIST. 8"I.E.=1903.87(W)

DETAIL 4 ON SHEET C4.1.

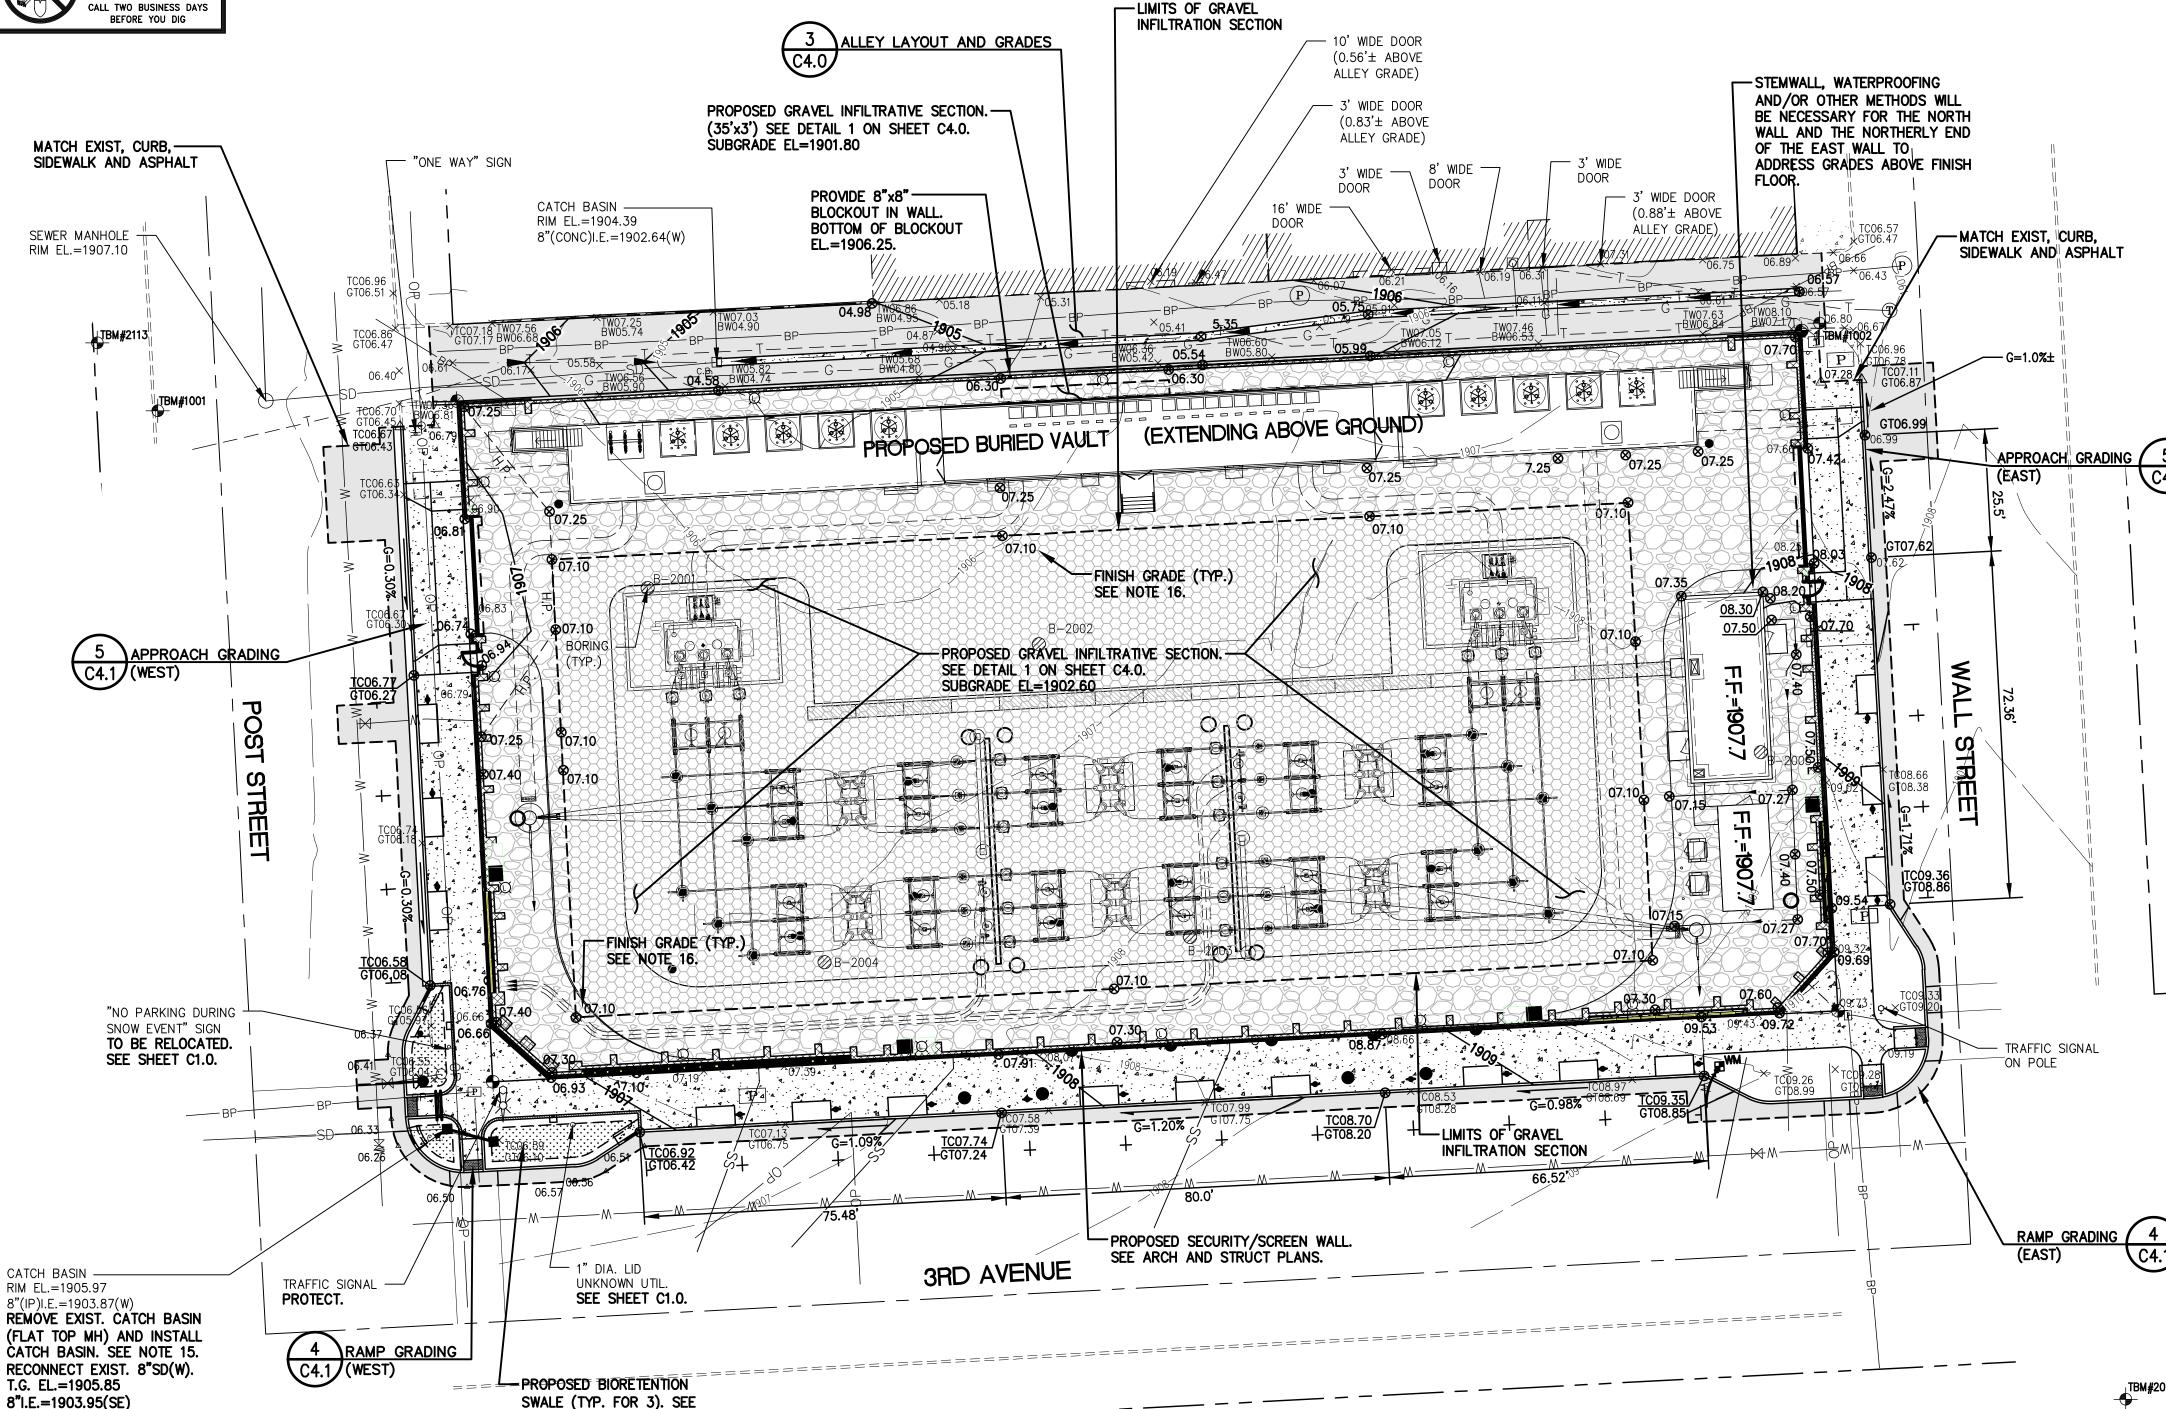

CONSTRUCTION NOTES: (NOTES APPLY TO SHEETS C2.0 AND C4.1) 1. ALL MATERIALS, WORKMANSHIP, TESTING AND CONSTRUCTION SHALL BE IN CONFORMANCE WITH WASHINGTON

STANDARDS, AND THE CITY OF SPOKANE GENERAL SPECIAL PROVISIONS FOR PRIVATE CONTRACTS. 2. CONTRACTOR SHALL VERIFY EXISTING CONDITIONS PRIOR TO CONSTRUCTION.

- 3. CONTRACTOR SHALL VERIFY LOCATION AND ELEVATION AND MATERIAL OF EXISTING UTILITIES AT POINTS OF CONNECTION AND CROSSINGS PRIOR TO CONSTRUCTION. ALL EXISTING UTILITIES ON SITE ARE ASSUMED TO BE REMOVED OUT TO PROPERTY LINE. CONTRACTOR SHALL VERIFY ACTUAL LIMITS OF REMOVAL WITH
- 4. ALL STORM PIPING SHALL BE AS SPECIFIED ON THE PLANS. PVC PIPE (PVC) SHALL CONFORM TO ASTM D3034, SDR 35 FOR PIPE SIZES SMALLER THAN 18" DIAMETER AND IN ACCORDANCE WITH ASTM F-679(T-1) FOR PIPE SIZES 18" IN DIAMETER AND LARGER, UNLESS NOTED OTHERWISE. DUCTILE IRON PIPE (D.I.) SHALL BE CLASS 50.

STATE STANDARD SPECIFICATIONS FOR ROAD, BRIDGE & MUNICIPAL CONSTRUCTION, THE CITY OF SPOKANE

- 5. LENGTHS FOR PIPING SHOWN ARE FROM CENTER OF CATCH BASIN, MANHOLE OR DRYWELL.
- 6. ALL STORM DRAIN PIPE CONNECTIONS SHALL BE MADE WITH WYES.
- 7. CONTRACTOR SHALL PROVIDE EROSION PROTECTION, AS A MINIMUM, IN ACCORDANCE WITH THE TEMPORARY EROSION AND SEDIMENTATION CONTROL PLAN DEVELOPED FOR THIS PROJECT AND THE SRSM. CONTRACTOR SHALL ALSO CONFORM TO ANY ADDITIONAL REQUIREMENTS SET FORTH BY A CONSTRUCTION STORMWATER GENERAL PERMIT, AS OBTAINED BY THE OWNER.
- 8. STORM LINE TRENCHING AND BACKFILL SHALL BE PER CITY OF SPOKANE STANDARD PLAN B-18C AND B-18D. IF THERE IS 6", OR LESS, OF CLEARANCE BETWEEN UTILITIES AT CROSSING, INSTALL CONTROL DENSITY FILL (CDF) BETWEEN CROSSING UTILITIES TO ENSURE COMPACTION.
- 9. ALL ADJUSTMENT RINGS AND CASTINGS SHALL BE CENTERED AND GROUTED ON ALL DRAINAGE STRUCTURES. CONTRACTOR SHALL GROUT AROUND ALL PIPES ENTERING AND EXITING STRUCTURES. PIPING SHALL NOT EXTEND MORE THAN 6" BEYOND INTERIOR OF DRAINAGE STRUCTURES, UNLESS OTHERWISE NOTED.
- 10. SITE EXCAVATION, INCLUDING ROCK CUTS AND REMOVAL, SHALL CONFORM TO SECTION 2-03 OF THE WSDOT STANDARD SPECIFICATIONS. EMBANKMENTS TO BE CONSTRUCTED ACCORDING TO THE APPLICABLE PARAGRAPHS OF SECTION 2-03 OF THE WSDOT STANDARD SPECIFICATIONS. EARTH EMBANKMENTS TO BE CONSTRUCTED USING METHOD B OF 2-03(14)C. ALL GRADING WORK SHALL ALSO CONFORM TO THE GEOTECHNICAL EVALUATION AND ADDENDUMS COMPLETED FOR THE SITE BY BUDINGER AND ASSOCIATES.
- 11. ALL APPROVALS AND PERMITS REQUIRED BY THE CITY OF SPOKANE SHALL BE OBTAINED AND PAID FOR BY THE CONTRACTOR PRIOR TO CONSTRUCTION. NO REVISIONS SHALL BE MADE TO THE APPROVED PLANS WITHOUT APPROVAL FROM THE CITY OF SPOKANE AND THE DESIGN ENGINEER OF RECORD.
- 12. STORMWATER FACILITIES, INCLUDING DRYWELLS, CB's, PIPES, AND INFILTRATION GALLERIES, MUST BE CONSTRUCTED UNDER THE SUPERVISION OF THE WASTEWATER MANAGEMENT DIVISION. STORMWATER Treatment/disposal facilities (208 swales/gravel infiltration areas) shall be inspected prior TO PLACEMENT OF TOPSOIL OR GRAVEL INFILTRATIVE SECTION, PLANTINGS, OR GRASS. THE CONTRACTOR SHALL CONTACT THE WASTEWATER MAINTENANCE DIVISION OFFICE AT (509) 625-7905 OR (509) 625-7912 IN ORDER TO ARRANGE A MUTUALLY AGREEABLE INSPECTION SCHEDULE.
- 13. HORIZONTAL AND VERTICAL SEPARATION BETWEEN WATER AND SEWER LINES SHALL BE MAINTAINED IN ACCORDANCE WITH CITY OF SPOKANE STANDARD PLANS W-110, W-111, W-112 AND W-113.
- 14. ALL SPOT ELEVATIONS ARE FOR FINISH GRADE OF ASPHALT, CONCRETE WALK, GRAVEL, ROCK TOP DRESSING OR LANDSCAPE, UNLESS NOTED OTHERWISE. SPOT ELEVATIONS ARE ABBREVIATED FOR PLAN CLARITY, FOR ACTUAL ELEVATION ADD 1900 TO SPOT ELEVATIONS SHOWN. CURBING SHALL BE INSTALLED WITH 6" EXPOSURE FROM ASPHALT GUTTER TO TOP OF CURB, UNLESS NOTED OTHERWISE.
- 15. CATCH BASINS SHALL BE TYPE O PER CITY OF SPOKANE STANDARD PLAN B-101B INSTALLED WITH FRAME & GRATE, UNLESS NOTED OTHERWISE.
- 16. THE CONTRACTOR SHALL PLACE MARKING TAPE IN THE EXCAVATION TRENCH AT A MID-DEPTH LOCATION FOR ALL UNDERGROUND SIDE SERVICE INSTALLATIONS FOR THE PURPOSE OF ALERTING ANY FUTURE EXCAVATION IN THE SPECIFIC AREA.
- 17. THE SITE CONTRACTOR SHALL COORDINATE THE STORM DRAIN CONNECTIONS TO THE BUILDING WITH THE BUILDING CONTRACTOR AND MECHANICAL/ARCHITECTURAL PLANS. CONTRACTOR SHALL PROVIDE REDUCERS/FITTINGS/BENDS AS NECESSARY TO COMPLETE THE CONNECTION.
- 18. CONTRACTOR TO PROVIDE, INSTALL AND GROUT ADJUSTMENT RINGS AND BARREL SECTIONS AS NECESSARY TO COMPLETE ADJUSTMENT OF EXISTING DRAINAGE FACILITIES TO BE MAINTAINED. HEIGHT OF ADJUSTMENT RINGS FOR MANHOLES SHALL NOT EXCEED 16".
- 19. CONTRACTOR SHALL REMOVE ALL UNDOCUMENTED FILL AND UNSUITABLE SOIL ON SITE, WITHIN THE AVISTA PROPERTY LINES, AND REPLACE WITH COMPACTED STRUCTURAL FILL IN ACCORDANCE WITH THE GEOTECHNICAL REPORT COMPLETED BY BUDINGER AND ASSOCIATES. TEST PITS SHALL ALSO BE REMEDIATED IN ACCORDANCE WITH THE GEOTECHNICAL REPORT. SEE REPORT FOR TEST PIT LOCATIONS. REMOVAL AND REPLACEMENT OF SOIL MATERIAL WITHIN THE GRAVEL INFILTRATIVE SECTION AREA SHALL BE COMPLETED IN ACCORDANCE WITH GEOTECHNICAL RECOMMENDATIONS.
- 20. UPON COMPLETION OF SITE IMPROVEMENTS, ALL EXCESS MATERIAL SHALL BE REMOVED FROM THE SITE AND DISPOSED OF OFF-SITE IN A LEGAL MANNER.
- 21. CONTRACTOR TO COORDINATE WITH OWNER'S GEOTECHNICAL ENGINEER TO PERFORM MATERIAL VERIFICATION AND/OR DRYWELL TESTING, AS REQUIRED BY THE CITY OF SPOKANE, FOR ALL OF THE DRYWELL AND/OR Infiltrative structure installations.
- 22. PROPOSED ELEVATIONS SHOWN ALONG THE CURB AND NEW ASPHALT, ADJACENT TO SAWCUTS AND ASPHALT MATCH LOCATIONS, ARE BASED ON INTERPOLATED SPOT ELEVATIONS AND INTERPOLATION BETWEEN EXISTING CONTOURS AND SPOT ELEVATIONS SHOWN ON THE SURVEY. PROPOSED SPOT ELEVATIONS PROVIDE GUIDANCE FOR CURB AND ASPHALT INSTALLATION TO MAINTAIN DRAINAGE PATTERNS AND POSITIVE DRAINAGE. IF ELEVATIONS SHOWN CREATE EXCESSIVE GRADES OR POTENTIAL PONDING AREAS, CONTRACTOR TO CONTACT ENGINEER FOR REVIEW PRIOR TO PLACING ROCK OR SURFACING.

Revisions

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Project No.: 20.134 9.28.21 Drawn By: S.M.B. Checked By: M.J.L.

NOTES:

1. ALL GRADING, ROCKING AND PAVING SHALL CONFORM TO THE 2021 WSDOT STANDARD SPECIFICATIONS.


NOTE 3.

2. GRAVEL BORROW AND PERMEABLE BALLAST SHALL BE COMPACTED TO 80 PERCENT OF MAXIMUM DRY UNIT WEIGHT (MDUW) IN LIFTS SUITABLE TO THE COMPACTION EQUIPMENT UTILIZED.

3. SUBGRADE SURFACE SHALL BE PROTECTED FROM DEGRADATION. PROTECTIVE MEASURES INCLUDE EROSION CONTROL MAINTENANCE DURING INCLEMENT WEATHER AND PREVENTING EQUIPMENT FROM DRIVING ON WET SUBGRADE TO AVOID DISTURBANCE. ANY MATERIAL REMOVED BELOW SUBGRADE FOR DEBRIS REMOVAL TYPE PURPOSES SHALL BE REPLACED WITH GRAVEL BORROW PER WSDOT SPECIFICATIONS. TRENCH BACKFILL FOR BURIED UTILITY INSTALLATION WITHIN THE SUBGRADE SHALL BE COMPLETED IN ACCORDANCE WITH THE UTILITY PURVEYOR REQUIREMENTS.

4. ALL MATERIALS SHALL BE FROM A WSDOT APPROVED AGGREGATE SOURCE AND/OR WSDOT QUALIFIED PRODUCTS LIST.



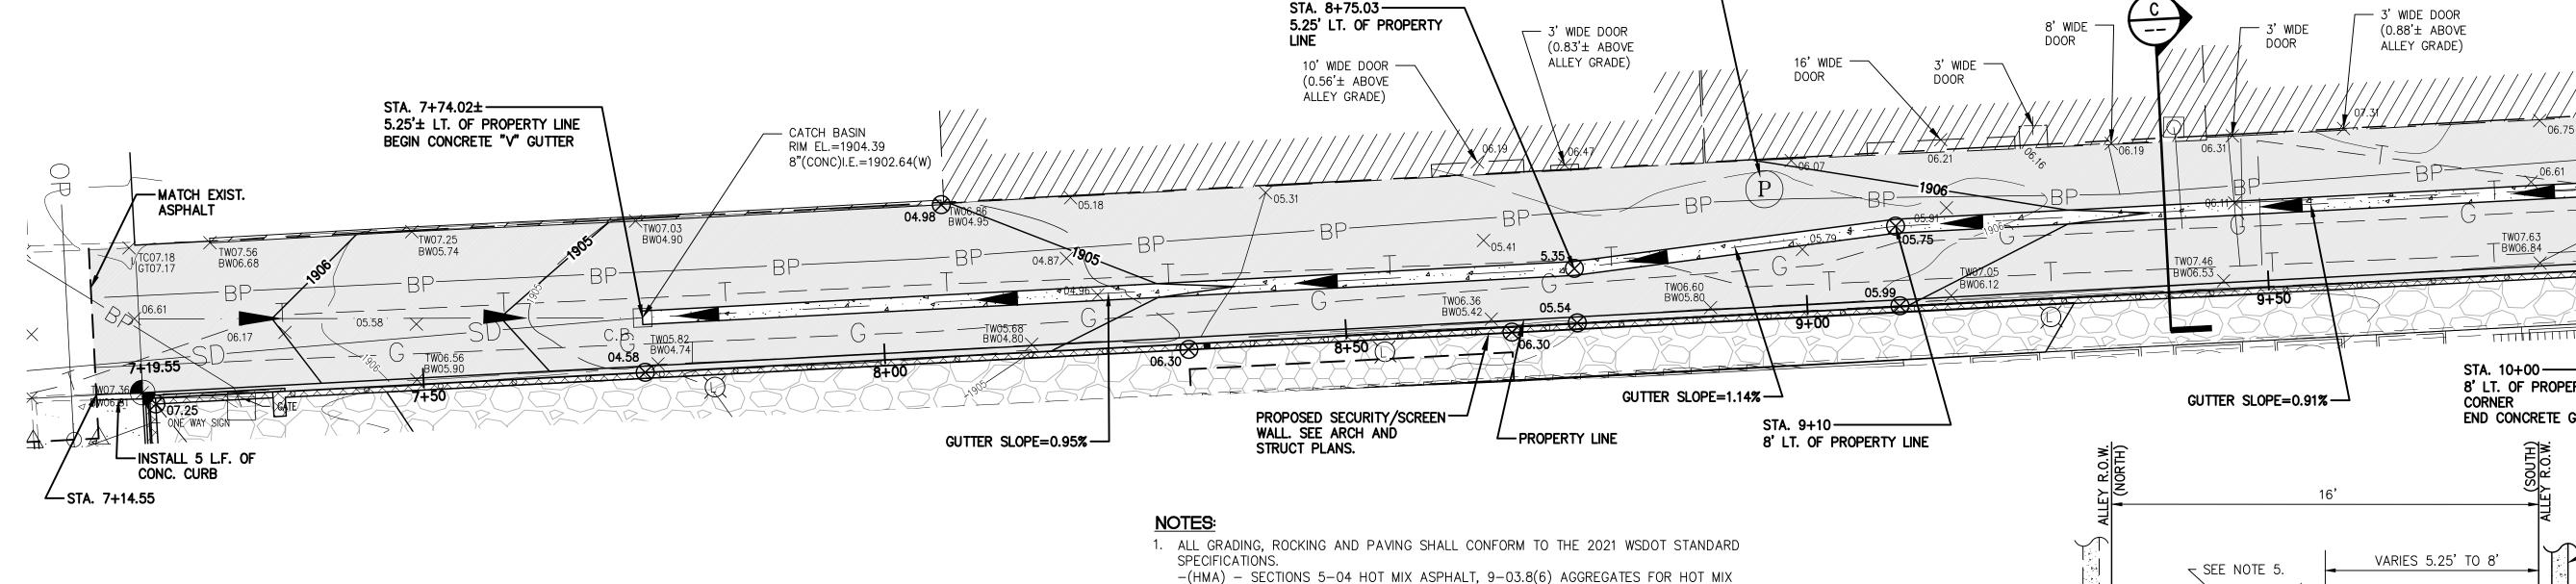

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DRY DENSITY AS PER ASTM D1557.

QUALIFIED PRODUCTS LIST.

-(CSTC) - SECTION 9-03.9(3) TOP COURSE FOR AGGREGATE BASE.

SHOWN PRIOR TO GRADING AND POURING CONCRETE "V" GUTTER.

EXCEPT, DEPRESSION SHALL BE 1" IN LIEU OF 2".

2. HOT MIX ASPHALT SHALL BE WSDOT HMA CLASS 1" PG64H-28 COMPACTED TO MIN.


92% OF RICE DENSITY AS DEFINED IN SECTION 5-04.3(10) OF THE 2021 WSDOT STANDARD SPECIFICATIONS. HMA SHALL BE A CITY OF SPOKANE APPROVED MIX.


3. COMPACT NATIVE SUBGRADE, STRUCTURAL FILL AND CSTC TO A MINIMUM 95% MAXIMUM

4. ALL MATERIALS SHALL BE FROM A WSDOT APPROVED AGGREGATE SOURCE AND/OR

5. CONTRACTOR SHALL VERIFY ROAD CROSS SLOPE CONFORMS TO ACCEPTABLE SLOPES


6. CONCRETE "V" GUTTER SHALL BE PER CITY OF SPOKANE STANDARD PLAN NO. F-106A

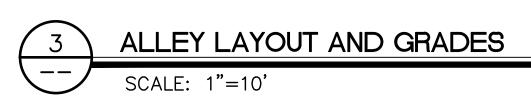

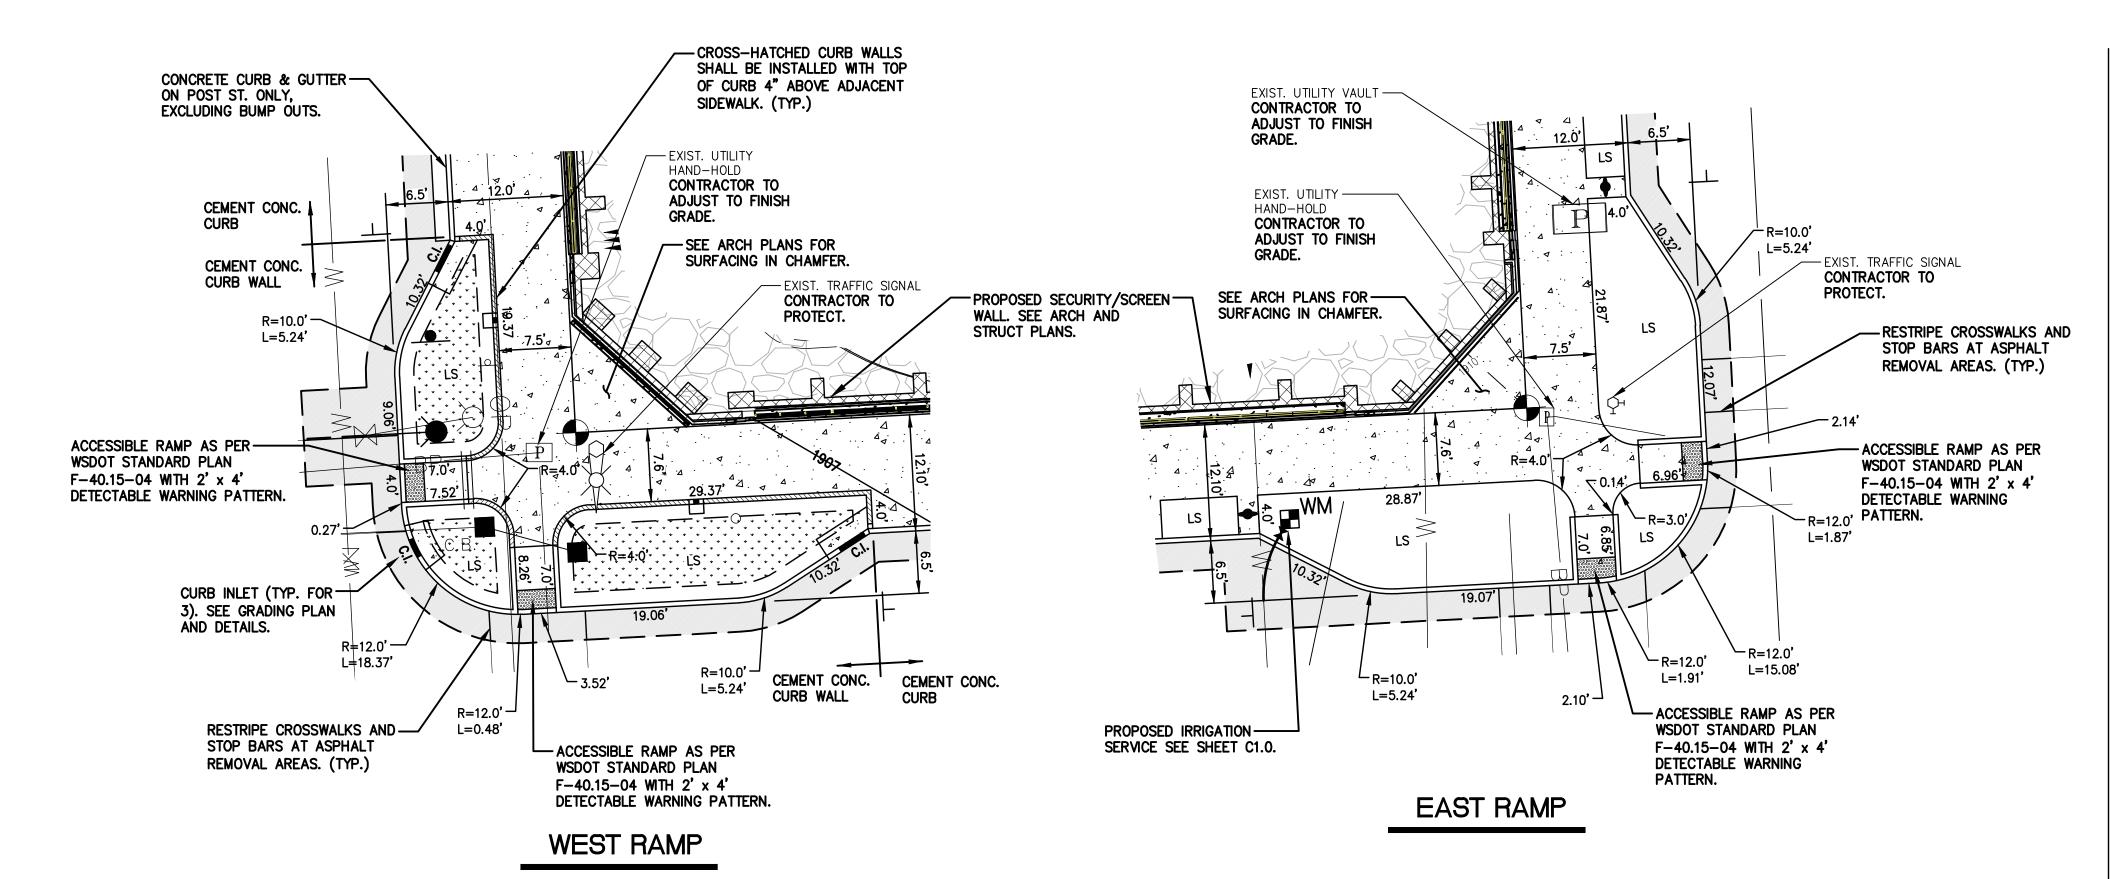




ADJUST ACCESS RING AND ——
COVER AS NECESSARY TO
MATCH FINISH GRADE.

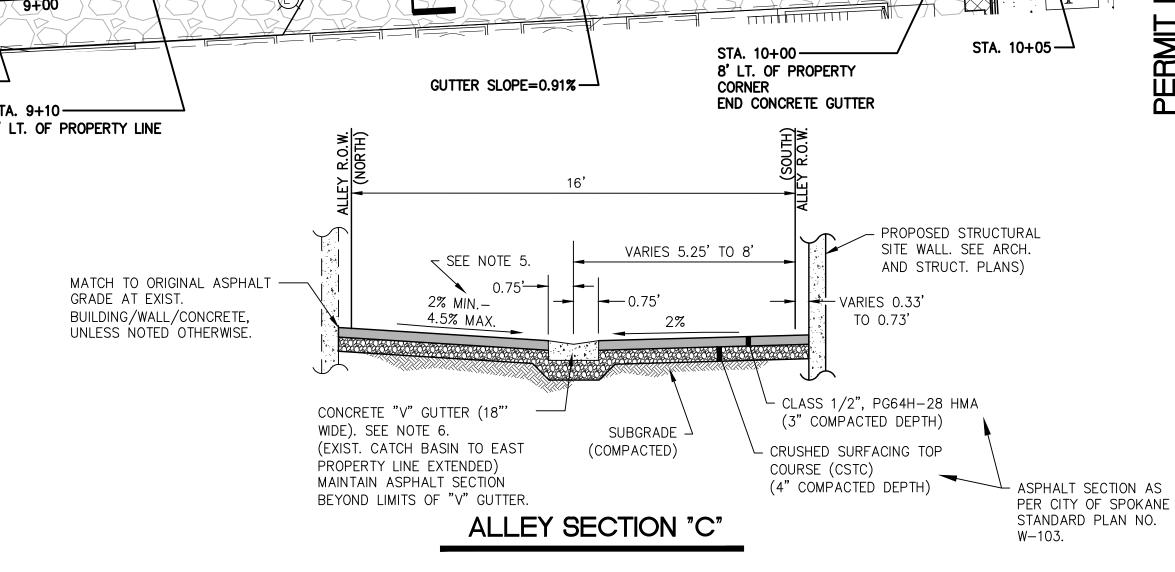

Revisions:

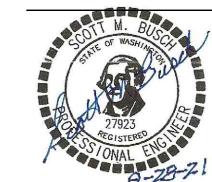

CIVIL SITE DETAILS

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MATCH EXIST. —

/ ASPHALT/ AND / CONCRETE // TRO SUBSTATION ENCLOSISTA CORPORATION

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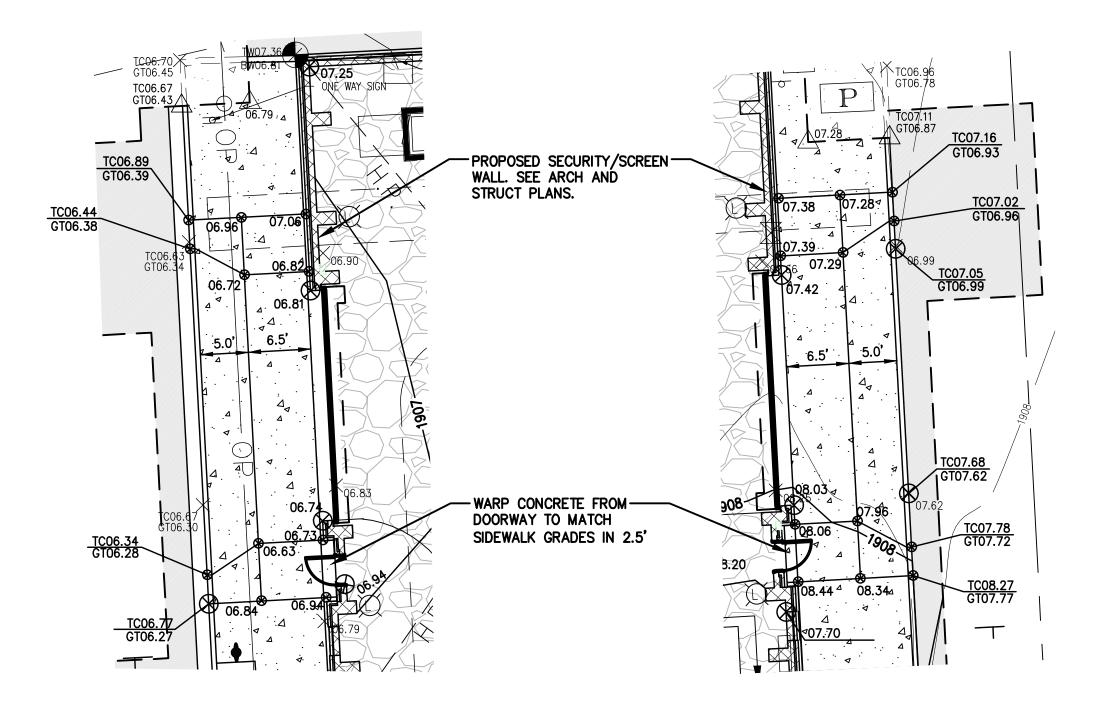
Date: 9.28.21

Drawn By: S.M.B.

Checked By: M.J.L.


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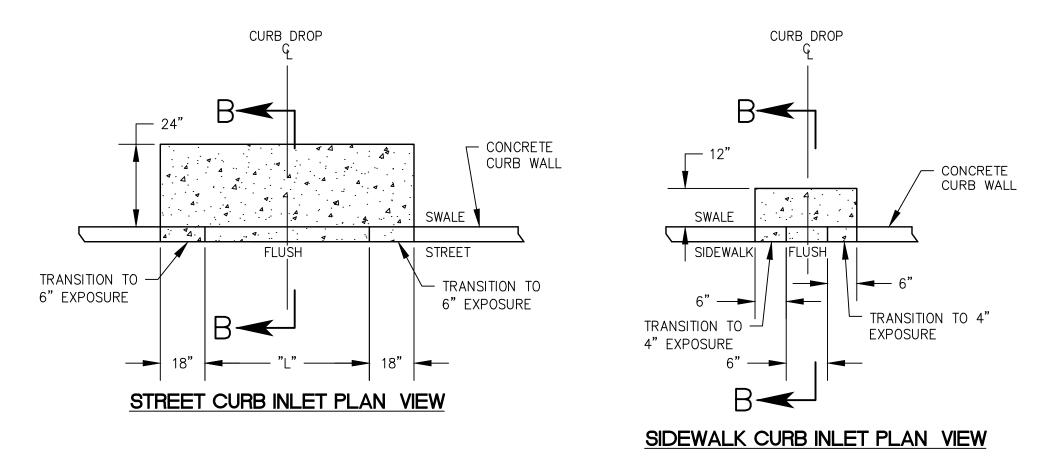
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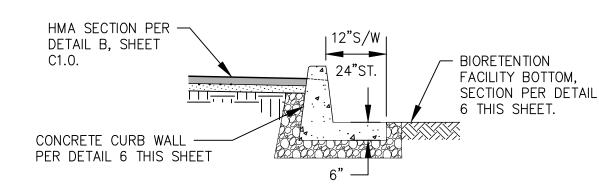


WEST APPROACH

EAST APPROACH





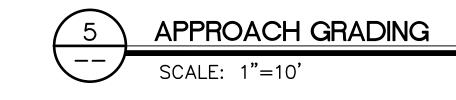

SECTION B-B


NOTES:

- 1. CURB INLET SHALL BE CONSTRUCTED IN ACCORDANCE WITH ASTM C478 (AASHTO M199) AND ASTM C890 UNLESS OTHERWISE SHOWN ON PLANS OR NOTED IN THE PROJECT SPECIAL PROVISIONS.
- 2. TOP SURFACE TO BE BROOM FINISHED.
- 3. ALL EXTERNAL EDGES NOT LABELED SHALL BE TROWELED WITH 1/4" RADIUS EDGER.
- 4. DIMENSION "L" SHALL BE SHOWN ON THE PLANS.

SEE SHEET C2.0 FOR CONSTRUCTION NOTES.



RAMP GRADING SCALE: 1"=10'

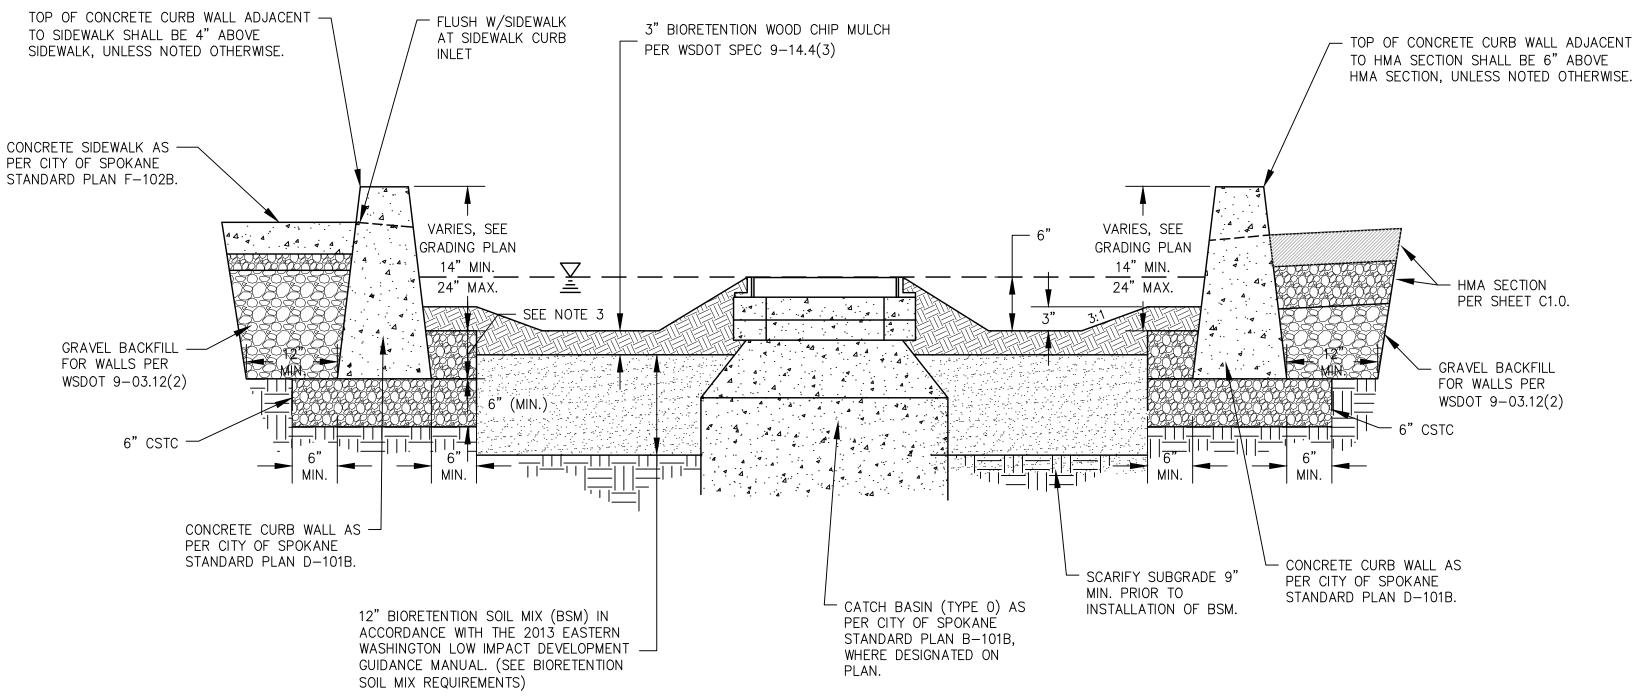

NOTES:

G = .010

1. CONSTRUCTION OF THE BIORETENTION FACILITY SHALL MEET THE REQUIREMENTS AS LISTED IN THE DEPARTMENT OF ECOLOGY EASTERN WASHINGTON LOW IMPACT DEVELOPMENT GUIDANCE MANUAL DATED JUNE 2013.

2. CONCRETE CURB WALL PER CITY OF SPOKANE STANDARD PLAN D101-B. THIS SECTION APPLIES TO THE CONCRETE CURB WALL AT THE BIORETENTION FACILITY.

3. PROVIDE 6-INCHES MINIMUM BACKFILL, INCREASE TO 8-INCHES MINIMUM BACKFILL WHERE LOCATIONS (ALONG DRIVE AISLE) EXCEED 24-INCHES TO TOP BACK OF CURB.

4. SCARIFY FINISHED SUBGRADE AND INCORPORATE BIORETENTION SOIL MIX INTO LOOSE SUBGRADE (3"-6" TYPICAL DEPTH).

BIORETENTION SOIL MIX (BSM) REQUIREMENTS:

BIORETENTION SOIL MIX SHALL CONSIST OF 40% COMPOST AND 60% MINERAL AGGREGATE.

- CATION EXCHANGE CAPACITY (CEC) > 5 MILLIEQUIVALENTS/100 GRAMS OF

DRY SOIL.

MINERAL AGGREGATE REQUIREMENTS

 WELL GRADED SAND PER ASTM D2487-11. COEFFICIENT OF UNIFORMITY (Cu) (D60/D10) > 4.

- COEFFICIENT OF CURVE (Cc) $((D30)2/D60 \times D10) > 1 \text{ AND } < 3.$

MINERAL AGGREGATE GRADATION

DE GRADING/DRAINAGE

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Project No.: 20.134 9.28.21 S.M.B. Drawn By: Checked By: M.J.L.

BASKETS, &/OR BURLAP COMPLETELY FROM ROOT BALL TYPICAL PLANTINGS — FOR ALL 4'X8' PLANTERS ALONG ENSURE SOIL HAS FULLY SETTLED — 3RD AVENUE (8)BOULDERS -

Shrub Planting Plan - East 1"=10"

3RD AVENUE

Shrub Planting Plan - West

1"=10"

GENERAL PLANTING NOTES

- 1. PLANT MATERIAL SHALL BE PLANTED IN THE LOCATIONS SHOWN. MAINTAIN SPACING AND DISTANCES RELATIVE TO HARD FEATURES. PLANT MATERIAL SHALL BE INSTALLED PER PLANTING DETAILS. ADJUST PLANT LOCATIONS TO ACCOMMODATE UTILITIES, VAULTS, ETC.
- 2. WORK SHALL BE PERFORMED BY PERSONS FAMILIAR WITH THIS TYPE OF WORK AND UNDER THE SUPERVISION OF A QUALIFIED LANDSCAPE FOREMAN. THE FOREMAN SHALL REMAIN ON-SITE DURING ALL LANDSCAPE SOIL
- PREPARATION, IRRIGATION AND PLANTING OPERATIONS. THE OWNER OR HIS REPRESENTATIVE RESERVES THE RIGHT TO MAKE SUBSTITUTIONS, ADDITIONS AND DELETIONS IN THE PLANTING SCHEME AS THEY FEEL NECESSARY WHILE WORK IS IN PROGRESS. SUCH CASES ARE TO BE ACCOMPANIED BY EQUITABLE ADJUSTMENT. SUBSTITUTIONS SHALL NOT DEVIATE FROM MUNICIPALITIES'
- LANDSCAPE REQUIREMENTS OR APPROVED LANDSCAPE PLANS. 4. PROTECT EXISTING AND PROPOSED LANDSCAPING FROM DAMAGE. ANY DAMAGE OCCURRING ON THE JOB SHALL BE THE RESPONSIBILITY OF THE CONTRACTOR AND SHALL BE REPAIRED OR REPLACED AT THE DISCRETION OF THE OWNER.
- 5. "PLANTING QUANTITIES" ARE SHOWN ON THE PLANS ARE FOR THE CONVENIENCE OF THE CONTRACTOR ONLY AND ARE NOT GUARANTEED. ALL PLANTING INDICATED ON THE DRAWINGS SHALL BE REQUIRED.
- 6. INSTALL AND TILL 36" TOPSOIL INTO RECTANGULAR PLANTING AREAS WITH TREES AND 18" OF TOPSOIL INTO OTHER PLANTING AREAS. INSTALL TOPSOIL IN 6" LIFTS AND ALLOW TO SETTLE. INSTALL IRRIGATION AND PLANTINGS ONLY AFTER ALL SETTLING IS COMPLETE. INSTALL ADDITIONAL TOPSOIL AS NECESSARY TO BRING
- THE SOIL TO THE HEIGHT RELATIVE TO THE SIDEWALK, AS SHOWN ON THE DETAIL. 7. THE SITE SHALL BE WEED-FREE UPON COMPLETION OF PROJECT AND ACCEPTANCE BY OWNER.
- ALL PLANTS SHALL BE HEALTHY AT TIME OF PLANTING AND UPON OWNER'S ACCEPTANCE.
- 9. THE CONTRACTOR SHALL WARRANTY ALL PLANT MATERIAL FOR A PERIOD OF ONE-YEAR FROM ACCEPTANCE BY OWNER. THE CONTRACTOR SHALL REPLACE IMMEDIATELY ANY DEAD, DYING, DAMAGED, DISEASED, OR OTHERWISE
- 10. TOP OF THE TOP DRESSING SHALL BE FLUSH WITH TOPS OF ADJACENT HARD SURFACES, INCLUDING CURBING.

PLANT SCHEDULE

SYMBOL	CODE	QTY	COMMON NAME / BOTANICAL NAME	SIZE	CLASS
	PSG	3	PRINCETON SENTRY GINKGO / GINGKO BILOBA 'PRINCETON SENTRY'	2" CAL.	CLASS II
	RPO	6	REGAL PRINCE OAK / QUERCUS ROBUR X BICOLOR 'LONG'	2" CAL.	CLASS II
00000000000000000000000000000000000000	MCZ	6	MUSASHINO COLUMNAR ZELVOKVA / ZELKOVA SERRATA 'MUSASHINO'	2" CAL.	CLASS II
<u>SHRUBS</u>	CODE	QTY	COMMON NAME / BOTANICAL NAME	CONT.	SIZE (H x W)
0	MVL	35	PRUNUS LAUROCERASUS 'MOUNT VERNON' / MOUNT VERNON ENGLISH LAUREL	2 GAL.	2' x 4'
\odot	DFG	19	DWARF FOUNTAIN GRASS / PENNISETUM ALOPECUROIDES 'HAMELN'	1 GAL.	2' x 1.5'
٥	BMS	31	BLUE MARVEL SALVIA SALVIA NEMOROSA 'BLUE MARVEL'	1 GAL	1' × 1'
·	RSC	50	RED SATIN COREOPSIS / RED FLOWERS	1 GAL.	1.5' x 1.5'
\odot	BSJ	11	BLUE STAR JUNIPER / JUNIPERUS SQUAMATA 'BLUE STAR'	2 GAL.	2' x 4'
0	WMP	36	CARSTEN'S WINTERGOLD MUGO PINE / PINUS MUGO 'CARSTEN'S WINTERGOLD'	2 GAL.	2' x 2.5'
ᢒ	BF	72	BOULDER BLUE FESCUE / FESTUCA GLAUCA 'BOULDER BLUE'	1 GAL.	1' × 1'
\odot	DL	16	STELLA DE ORO DWARF DAYLILY / HEMEROCALLIS x 'STELLA DE ORO'	1 GAL.	2' x 2'

LANDSCAPE LEGEND

TOP DRESSING

1"-2" CABINET MOUNTAIN SLATE STONE INSTALL 2" MIN. DEEP WITHIN ALL PLANTING AREAS. PULL BACK FROM BASE OF PLANTS. AVOID COVERING AND/OR DAMAGING PLANTS WHEN PLACING TOP DRESSING. DAMAGED PLANTS WILL BE REJECTED.

KEEP MULCH BACK FROM TRUNK AT

- 3" TOP BARK OR WOOD CHIP MULCH

ENSURE SOIL HAS SETTLED

PRIOR TO PLANTING TREE

LEAST 3 INCHES

30" DIA. AROUND TREE

TYPE A SOIL

PRIOR TO PLANTING TREE

FINISHED GRADE

OF HOLE WHEN

1. TREES BURIED TOO DEEP, OR WITHOUT EXPOSING ROOT FLARE WILL BE REJECTED & SHALL BE


MONTHS. ALL STAKING MATERIAL SHALL BE REMOVED. IF TREE IS STILL UNSTABLE. AFTER 6 MONTHS.

CITY OF SPOKANE STREET TREE PLANTING DETAIL

LANDSCAPE BOULDER ANGULAR, NATURALLY BROKEN GRANITE BOULDER, 2'-3' DIAMETER. (QUANTITY: 18)

BOULDER BENCH TO BE APPROX. 5'Lx2'Dx2'H HAVING A FLAT TOP SURFACE. CONTRACTOR TO SOURCE BENCH BOULDERS WITH OWNER'S REPRESENTATIVE FOR APPROVAL PRIOR TO PROCUREMENT. CONTRACTOR TO FIELD LOCATE THE BOULDER BENCHES AS SHOWN IN PLANS WITH

OWNER'S REPRESENTATIVE.

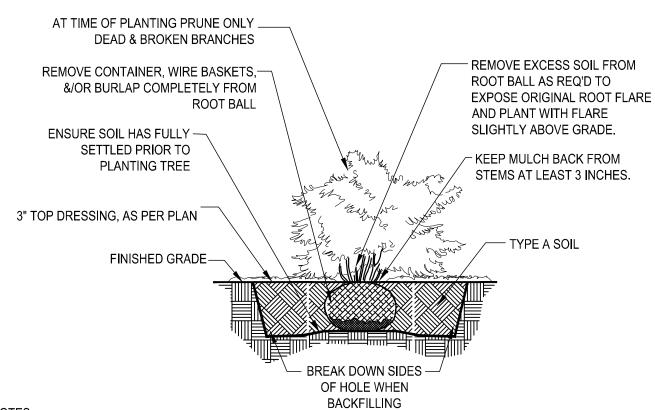

- 1. SHRUBS BURIED TOO DEEP, OR WITHOUT EXPOSING ROOT FLARE WILL BE REJECTED & SHALL BE REMOVED & REPLANTED AT PROPER DEPTH.
- DEVIATIONS FROM THIS DETAIL SHALL ONLY BE ALLOWED WITH PERMISSION FROM THE CITY ARBORIST. SHRUBS NOT PLANTED IN CONFORMITY WITH THIS DETAIL WILL BE REJECTED BY THE CITY ARBORIST. REPLACEMENT OF REJECTED SHRUBS WILL BE DONE AT THE CONTRACTOR'S EXPENSE & NOT BY THE CITY OF




Revisions:

FIVISTA

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Project No.: 20.134 9.28.21 Drawn By: S.M.B. Checked By: M.J.L.

THE UNDERGROUND UTILITIES SHOWN HAVE BEEN LOCATED AS ACCURATELY AS POSSIBLE FROM FIELD SURVEY INFORMATION AND EXISTING DRAWINGS. TAYLOR ENGINEERING, INC. MAKES NO GUARANTEES THAT THE UNDERGROUND UTILITIES SHOWN COMPRISE ALL SUCH UTILITIES IN THE AREA, EITHER IN SERVICE OR ABANDONED. FURTHER, WE DO NOT WARRANT THAT THE UNDERGROUND UTILITIES SHOWN ARE IN EXACT LOCATION INDICATED, ALTHOUGH WE DO CERTIFY THAT THEY ARE LOCATED AS ACCURATELY AS POSSIBLE FROM INFORMATION AVAILABLE.

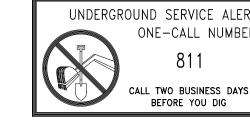

IRRIGATION SCHEDULE

MANUFACTURERE / MODEL/ DESCRIPTTION
FLUSH VALVE - NETAFIM TLSOV
MANUAL FLUSH VALVE

DRIPLINE - NETAFIM TLDL-06

TECHLINE PRESSURE COMPENSATING LANDSCAPE DRIPLINE

0.6 GPH EMITTERS @ 18" SPACING LAYOUT PER PLAN

AUTOMATIC CONTROL VALVE

RAIN BIRD VALVE WITH FLOW CONTROL. SET TO 35 PSI. INSTALL IN STATION "A" WITHIN PLANTING AREA.

POC IRRIGATION POINT OF CONNECTION

INSTALL PER CITY OF SPOKANE STANDARD PLAN NO. Y-111

IRRIGATION CONTROLLER
RAIN BIRD ESP-9V BATTERY-OPERATED CONTROLLER.
INSTALL WITHIN VALVE BOX USING SOLENOID MOUNT.

ENSURE VALVES ARE COMPATIBLE WITH CONTROLLER

VALVE #, ZONE GALLONS PER MINUTE, VALVE SIZE

PIPE MANUFACTURER / MODEL/ DESCRIPTION

IRRIGATION MAINLINE: 1" PVC SCHEDULE 40

〈 5.4 GPM

<NOT SHOWN>


IRRIGATION LATERAL LINE: 1" CLASS 200 PVC

PIPE SLEEVE: 4" SCHEDULE 40 PVC 4" SLEEVES. INSTALL QUANTITY OF SLEEVES SHALL BE AS NECESSARY TO ENSURE ALL PIPES UNDERNEATH PAVING ARE WITHIN 4" SLEEVES. EXTEND 12" MIN. INTO

PLANTER.

GENERAL IRRIGATION NOTES


- 1. THIS PLAN IS SCHEMATIC ONLY. IT IS INTENTIONALLY GENERAL TO DEPICT THE MATERIALS TO BE USED FOR THE IRRIGATION INSTALLATION. ADJUST THE DESIGN AND INSTALLATION TO FIT FIELD CONDITIONS.
- 2. ALL WORK SHALL BE PERFORMED BY PERSONS FAMILIAR WITH THIS TYPE OF WORK AND UNDER THE SUPERVISION OF A FOREMAN FAMILIAR WITH THIS TYPE OF WORK. THE FOREMAN SHALL REMAIN ON-SITE DURING ALL LANDSCAPE IRRIGATION INSTALLATIONS.
- 3. COMPLY WITH ALL LOCAL CODES AND ORDINANCES.
- 4. VERIFY LOCATIONS OF ALL UNDERGROUND UTILITIES PRIOR TO TRENCHING OPERATIONS.
- 5. INSTALL IRRIGATION SYSTEM PER DESIGN AND THEN ADJUST IRRIGATION HEAD LAYOUT TO FIT FIELD CONDITIONS, AS NECESSARY.
- 6. <u>IRRIGATION PLAN IS DIAGRAMMATIC ONLY.</u> MAINLINES, LATERALS, AND WIRES SHALL BE INSTALLED TO CONNECT PLANTERS.
- 7. 4" PVC SCHEDULE 40 SLEEVES SHALL BE INSTALLED BETWEEN PLANTERS, PER DETAILS. INSTALL ONE SLEEVE FOR EACH PIPE.
- 6. COORDINATE INSTALLATION/OPERATION OF IRRIGATION SYSTEM WITH OTHER TRADES.
- 7. PIPE LINES SHALL BE PLACED SO THAT DESCRIPTIONS FACE UP.
- 8. VERIFY 'WORKING' PSI AT MAXIMUM OPERATING FLOW PRIOR TO CONSTRUCTION OF SYSTEM AND NOTIFY OWNER'S REPRESENTATIVE OF ANY DEFICIENCY. (±80 PSI REPORTED)
- 9. USE KBI VALVE OR IN HEAD CHECK VALVES TO PREVENT LOW HEAD DRAINAGE WHERE IT OCCURS.
- 10. "AS-BUILT" RECORD DRAWINGS SHALL BE SIGNED BY THE INSTALLER AND DELIVERED TO OWNER PRIOR TO FINAL PAYMENT.
- 11. CONTRACTOR SHALL BE RESPONSIBLE FOR ALL COSTS ASSOCIATED WITH PERMITTING AND INSTALLING POINT OF CONNECTION AND ELECTRICAL.

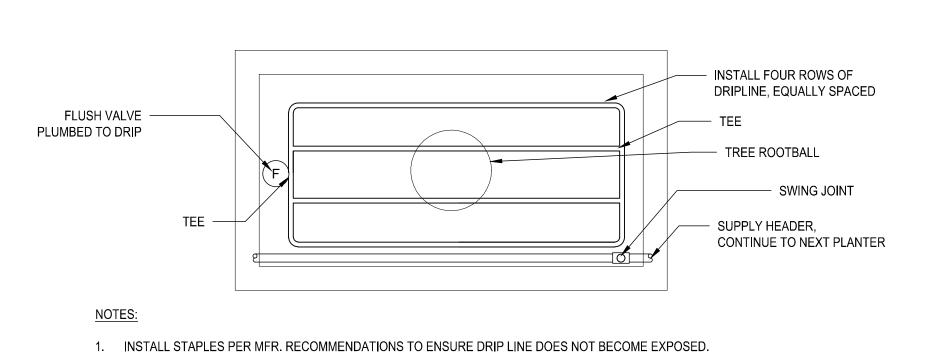


TYPICAL 4'x8' PLANTER IRRIGATION

(NOT TO SCALE)

2. SWING JOINT LOCATIONS WILL VARY BASED ON WHERE LATERAL LINE ENTERS PLANTER.

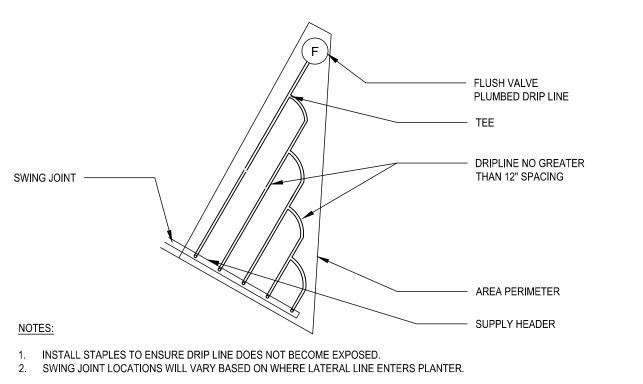

TYPICAL IRREGULAR PLANTER IRRIGATION (NOT TO SCALE)

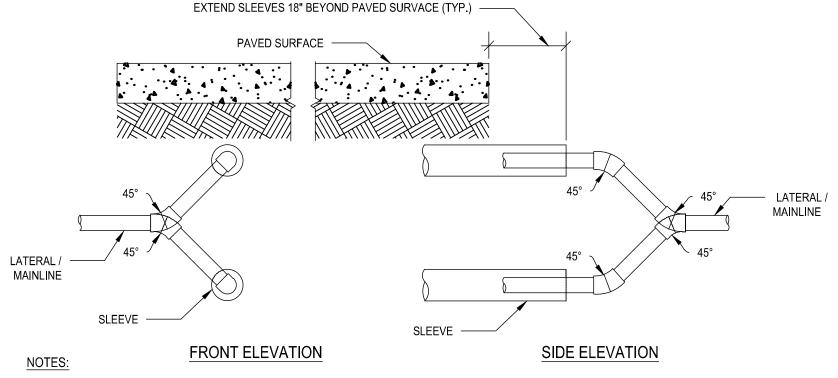

1. ALL SLEEVES UNDERNEATH STREETS SHALL BE DUCTILE IRON, SIZES AS INDICATED.

- 2. THERE SHALL NOT BE 90° JOINTS DIRECTING LATERALS AND MAINLINES INTO SLEEVES. MAXIMUM ANGLE SHALL BE 45°.
- 3. INSTALL SLEEVES 18" DEEP MINIMUM.


FEET

IRRIGATION SLEEVES (NOT TO SCALE)

IRRIGATION PLAN IS DIAGRAMMATIC ONLY MAINLINES, LATERALS, AND WIRES SHALL BE PLACED UNDERNEATH THE SIDEWALK. ALL CONTROL VALVES

AND OTHER IRRIGATION COMPONENTS SHALL BE PLACED WITHIN PLANTERS.

ERT REVISION

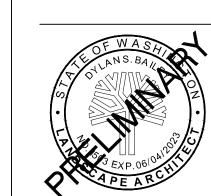

SCAPE IRRIGATION PLAN

MIT REVIEW DRAWING (9-28-2

VISTA° Cor

METRO



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